


TOWN OF ARLINGTON, MASSACHUSETTS

MINUTEMAN BIKEWAY IMPROVEMENTS


AT

LAKE STREET

SHEET NO.	DESCRIPTION
01	TITLE SHEET
02	PLAN SYMBOLS
03	GENERAL NOTES
04	CONSTRUCTION PLAN
05	CONSTRUCTION DETAILS
06	CURB TIE & LAYOUT PLAN
07	PLAZA LAYOUT PLAN
08	GRADING PLAN
09 - 10	TRAFFIC SIGNAL PLANS
11 - 12	SEQUENCE AND TIMING PLANS
13 - 16	TRAFFIC SIGNAL DETAILS
17	PAVEMENT MARKING AND SIGNING PLAN
18	TRAFFIC SIGN SUMMARY
19	LANDSCAPE MATERIALS AND LAYOUT PLAN
20	LANDSCAPE PLANTING PLAN
21 - 22	LANDSCAPE DETAILS
23	LIGHTING PLAN
24	LIGHTING PHOTOMETRICS PLAN
25 - 26	TRAFFIC MANAGEMENT PLANS

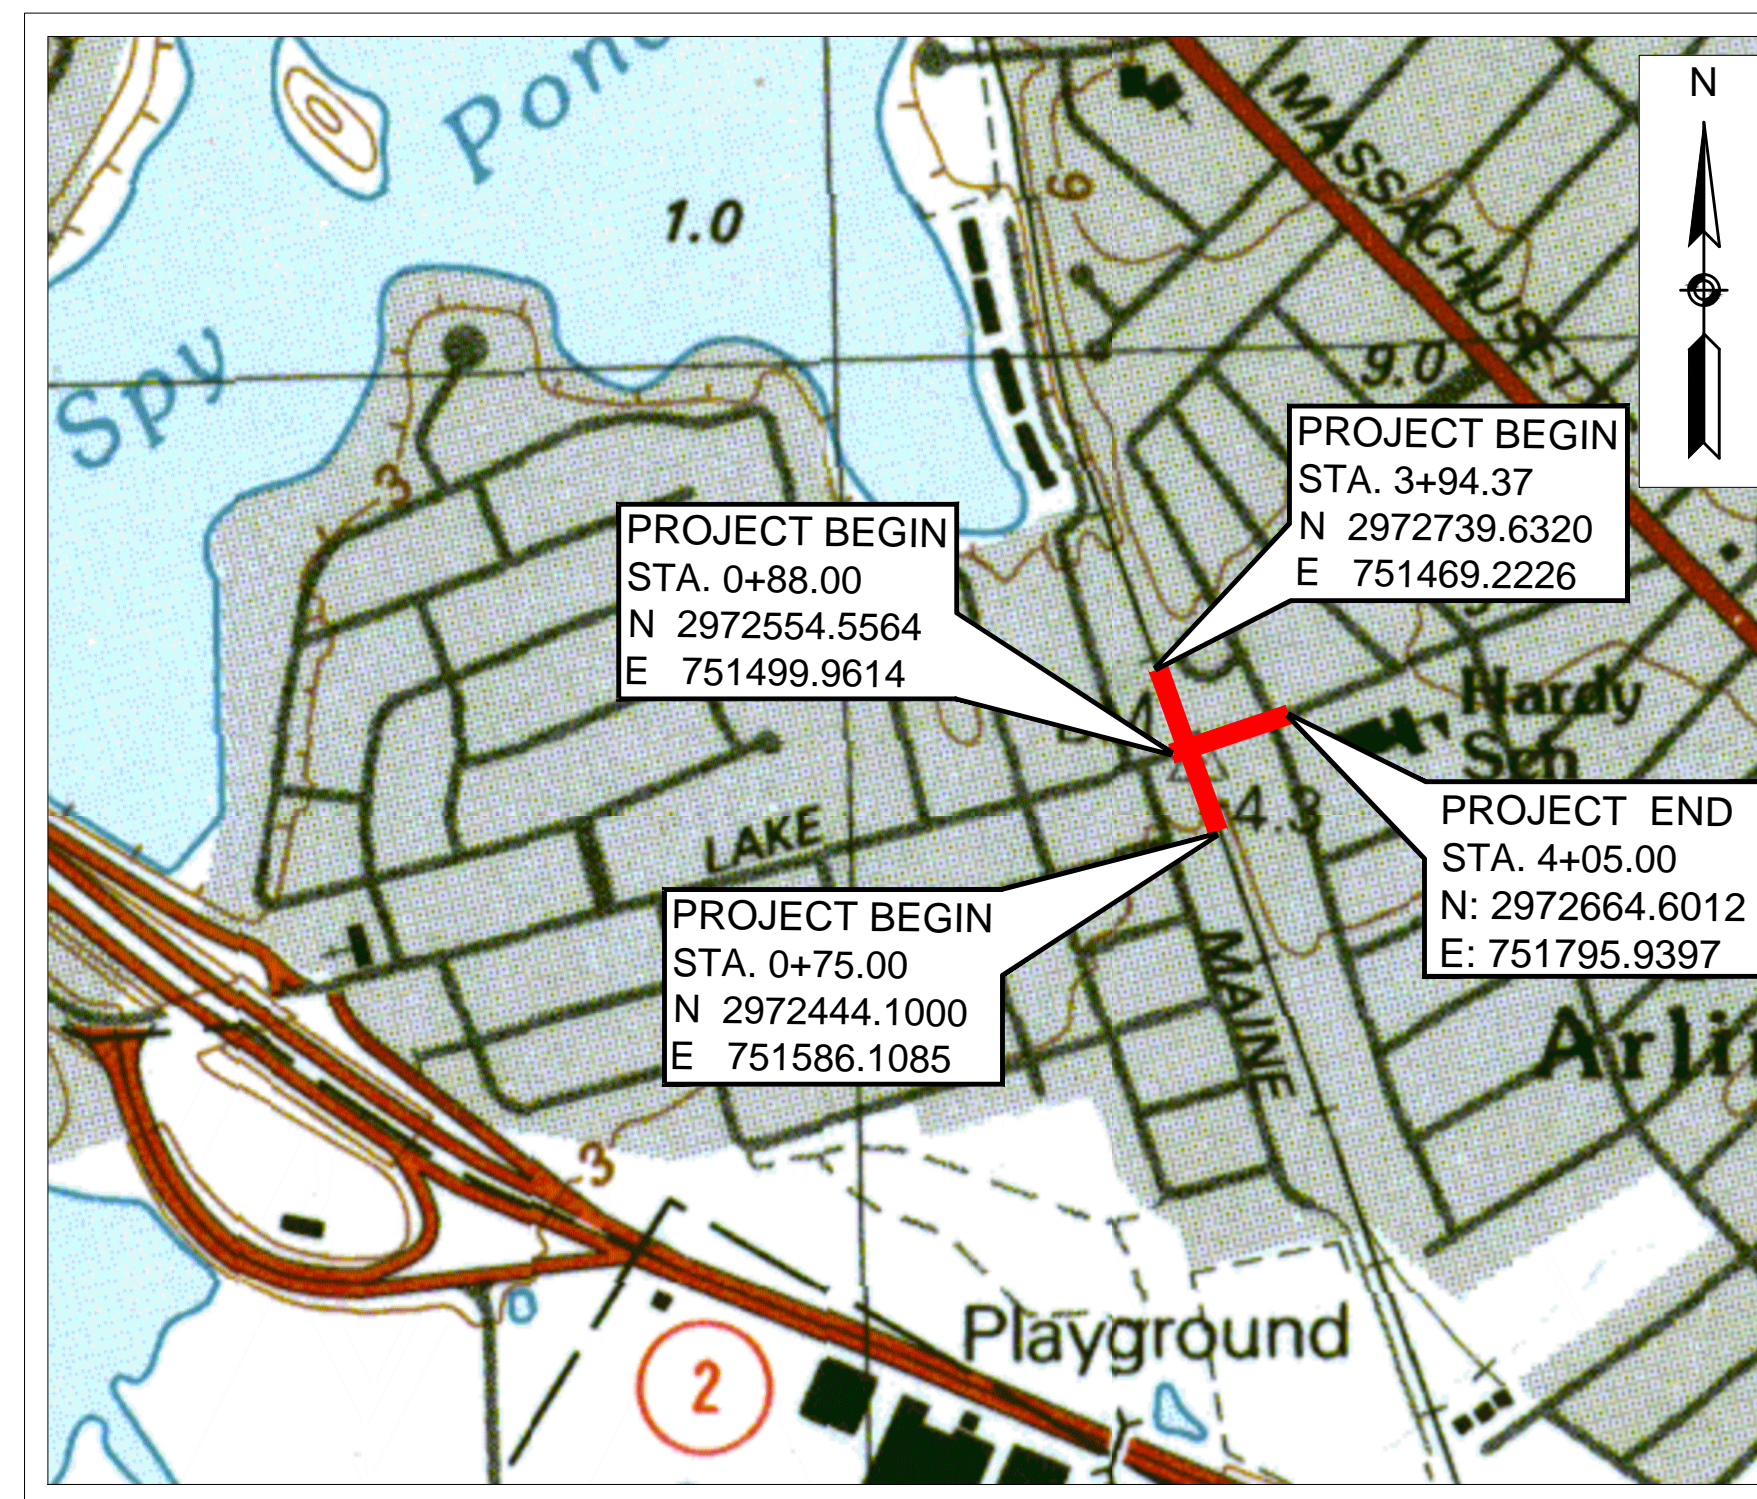

LOCATION PLAN

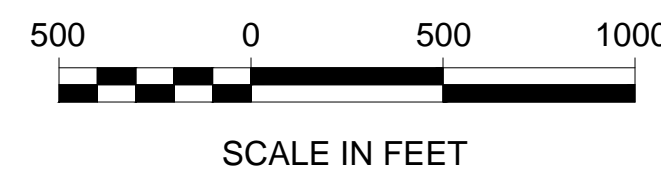

TOTAL LENGTH OF PROJECT = 699.37 FEET = 0.132 MILES

THE MASSACHUSETTS HIGHWAY DEPARTMENT STANDARD SPECIFICATIONS FOR HIGHWAYS AND BRIDGES DATED 1988, AS AMENDED, THE SUPPLEMENTAL SPECIFICATIONS DATED JULY 1, 2015, THE 2016 CONSTRUCTION STANDARD DETAILS, THE 1996 CONSTRUCTION AND TRAFFIC STANDARD DETAILS (AS RELATES TO TRAFFIC STANDARD DETAILS ONLY), THE 2015 OVERHEAD SIGNAL STRUCTURE AND FOUNDATION STANDARD DRAWINGS, THE 2009 MANUAL ON UNIFORM TRAFFIC CONTROL DEVICES FOR STREETS AND HIGHWAYS WITH MASSACHUSETTS AMENDMENTS, THE 1990 STANDARD DRAWINGS FOR SIGNS AND SUPPORTS, THE 1968 STANDARD DRAWINGS FOR TRAFFIC SIGNALS AND HIGHWAY LIGHTING AND THE LATEST EDITION OF THE AMERICAN STANDARD FOR NURSERY STOCK, WILL GOVERN.

PROJECT:	MINUTEMAN BIKEWAY IMPROVEMENTS AT LAKE STREET
DESIGN SUBMISSION:	DRAFT FINAL DESIGN
DRAWING TITLE:	TITLE SHEET

PREPARED FOR:	TOWN OF ARLINGTON ENGINEERING DIVISION 51 GROVE STREET ARLINGTON, MA 02476
---------------	---

PREPARED BY:	GREEN INTERNATIONAL AFFILIATES, INC. Civil and Structural Engineers (978) 923-0400 Westford, Massachusetts GreenIntl.com
--------------	--

SCALE: AS NOTED	DESIGNED BY: JG	SHEET NO. 01 OF 26
DATE: 09/15/2017	DRAWN BY: JG	
PROJECT NO. 17067.015	CHECKED BY: JS	

LIGHTING DESIGN SERVICES
LUMEN STUDIO, INC.

ELECTRICAL WIRING DESIGN SERVICES
ENGINEERING ADVANTAGE, INC.

NO.	DATE	REVISIONS

ABBREVIATIONS	
GENERAL	
AADT	ANNUAL AVERAGE DAILY TRAFFIC
ABAN	ABANDON
ADJ	ADJUST
APPROX.	APPROXIMATE
A.C.	ASPHALT CONCRETE
ACCM PIPE	ASPHALT COATED CORRUGATED METAL PIPE
BIT.	BITUMINOUS
BC	BOTTOM OF CURB
BD.	BOUND
BL	BASELINE
BLDG	BUILDING
BM	BENCHMARK
BO	BY OTHERS
BOS	BOTTOM OF SLOPE
BR.	BRIDGE
CB	CATCH BASIN
CBCI	CATCH BASIN WITH CURB INLET
CC	CEMENT CONCRETE
CCM	CEMENT CONCRETE MASONRY
CEM	CEMENT
CI	CURB INLET
CIP	CAST IRON PIPE
CLF	CHAIN LINK FENCE
CL	CENTERLINE
CMP	CORRUGATED METAL PIPE
CSP	CORRUGATED STEEL PIPE
CO.	COUNTY
CONC	CONCRETE
CONT	CONTINUOUS
CONST	CONSTRUCTION
CR GR	CROWN GRADE
DHV	DESIGN HOURLY VOLUME
DI	DROP INLET
DIA	DIAMETER
DIP	DUCTILE IRON PIPE
DW	STEADY DON'T WALK - PORTLAND ORANGE
DWY	DRIVEWAY
ELEV (or EL.)	ELEVATION
EMB	EMBANKMENT
EP	EDGE OF PAVEMENT
EXIST (or EX)	EXISTING
EXC	EXCAVATION
F&C	FRAME AND COVER
F&G	FRAME AND GRATE
FDN.	FOUNDATION
FLDSTN	FIELDSTONE
GAR	GARAGE
GD	GROUND
GG	GAS GATE
GI	GUTTER INLET
GIP	GALVANIZED IRON PIPE
GRAN	GRANITE
GRAV	GRAVEL
GRD	GUARD
HDW	HEADWALL
HMA	HOT MIX ASPHALT
HOR	HORIZONTAL
HYD	HYDRANT
INV	INVERT
JCT	JUNCTION
L	LENGTH OF CURVE
LB	LEACH BASIN
LP	LIGHT POLE
LT	LEFT
MAX	MAXIMUM
MB	MAILBOX
MH	MANHOLE
MHB	MASSACHUSETTS HIGHWAY BOUND
MIN	MINIMUM
NIC	NOT IN CONTRACT
NO.	NUMBER
PC	POINT OF CURVATURE
PCC	POINT OF COMPOUND CURVATURE
P.G.L.	PROFILE GRADE LINE
PI	POINT OF INTERSECTION
POC	POINT ON CURVE
POT	POINT ON TANGENT
PRC	POINT OF REVERSE CURVATURE
PROJ	PROJECT
PROP	PROPOSED
PSB	PLANTABLE SOIL BORROW
PT	POINT OF TANGENCY
PVC	POINT OF VERTICAL CURVATURE

ABBREVIATIONS (cont.)	
GENERAL	
PVI	POINT OF VERTICAL INTERSECTION
PVT	POINT OF VERTICAL TANGENCY
PVMT	PAVEMENT
PWW	PAVED WATER WAY
R	RADIUS OF CURVATURE
R&D	REMOVE AND DISPOSE
RCP	REINFORCED CONCRETE PIPE
RD	ROAD
RDWY	ROADWAY
REM	REMOVE
RET	RETAIN
RET WALL	RETAINING WALL
ROW	RIGHT OF WAY
RR	RAILROAD
R&R	REMOVE AND RESET
R&S	REMOVE AND STACK
RT	RIGHT
SB	STONE BOUND
SHLD	SHOULDER
SMH	SEWER MANHOLE
ST	STREET
STA	STATION
SSD	STOPPING SIGHT DISTANCE
SHLO	STATE HIGHWAY LAYOUT LINE
SW	SIDEWALK
T	TANGENT DISTANCE OF CURVE/TRUCK %
TAN	TANGENT
TEMP	TEMPORARY
TC	TOP OF CURB
TOS	TOP OF SEDIMENT
TOW	TOP OF WATER
TYP	TYPICAL
UD	UNDERGROUND DRAIN PIPE
UP	UTILITY POLE
VAR	VARIES
VERT	VERTICAL
VC	VERTICAL CURVE
VGC	VERTICAL GRANITE CURB
VLF	VINYL FENCE
WCR	WHEEL CHAIR RAMP
WDF	WOODEN FENCE
WG	WATER GATE
WIP	WROUGHT IRON PIPE
WM	WATER METER/WATER MAIN
X-SECT	CROSS SECTION

TRAFFIC SIGNAL	
CAB.	CABINET
CCVE	CLOSED CIRCUIT VIDEO EQUIPMENT
DW	STEADY DON'T WALK
FDW	FLASHING DON'T WALK
FR	FLASHING CIRCULAR RED
FRL	FLASHING RED LEFT ARROW
FRR	FLASHING RED RIGHT ARROW
FY	FLASHING CIRCULAR AMBER
FYL	FLASHING AMBER LEFT ARROW
FYR	FLASHING AMBER RIGHT ARROW
G	STEADY CIRCULAR GREEN
GL	STEADY GREEN LEFT ARROW
GR	STEADY GREEN RIGHT ARROW
GSL	STEADY GREEN SLASH LEFT ARROW
GSR	STEADY GREEN SLASH RIGHT ARROW
GV	STEADY GREEN VERTICAL ARROW
OL	OVERLAP
PED	PEDESTRIAN
PTZ	PAN, TILE, ZOOM
R	STEADY CIRCULAR RED
RL	STEADY RED LEFT ARROW
RR	STEADY RED RIGHT ARROW
TR SIG	TRAFFIC SIGNAL
TSC	TRAFFIC SIGNAL CONDUIT
W	STEADY WALK
Y	STEADY CIRCULAR AMBER
YL	STEADY AMBER LEFT ARROW

GENERAL SYMBOLS		
EXISTING	PROPOSED	DESCRIPTION
		JERSEY BARRIER ON BRIDGE OR JERSEY BARRIER
		CATCH BASIN
		CATCH BASIN CURB INLET
		FLAG POLE
		GAS PUMP
		MAIL BOX
		POST SQUARE
		POST CIRCULAR
		WELL
		ELECTRIC HANDHOLE
		FENCE GATE POST
		GAS GATE
		BORING HOLE
		MONITORING WELL
		TEST PIT
		HYDRANT
		LIGHT POLE
		COUNTY BOUND
		GPS POINT
		CABLE MANHOLE
		DRAINAGE MANHOLE
		ELECTRIC MANHOLE
		GAS MANHOLE
		MISC MANHOLE
		SEWER MANHOLE
		TELEPHONE MANHOLE
		WATER MANHOLE
		MASSACHUSETTS HIGHWAY BOUND
		MONUMENT
		STONE BOUND
		TOWN OR CITY BOUND
		TRAVERSE OR TRIANGULATION STATION
		TROLLEY POLE OR GUY POLE
		TRANSMISSION POLE
		UTILITY POLE W/ FIREBOX
		UTILITY POLE WITH DOUBLE LIGHT
		UTILITY POLE W / 1 LIGHT
		UTILITY POLE
		BUSH
		TREE
		STUMP
		SWAMP / MARSH
		WATER GATE
		PARKING METER
		SIGN AND POST
		SIGN AND POST (2 POSTS)
		OVERHEAD CABLE/WIRE
		CURBING
		CONTOURS
		UNDERGROUND DRAIN PIPE (DOUBLE LINE 24 INCH AND OVER)
		UNDERGROUND GAS DUCT (DOUBLE LINE 24 INCH AND OVER)
		UNDERGROUND SEWER MAIN (DOUBLE LINE 24 INCH AND OVER)
		UNDERGROUND TELEPHONE DUCT (DOUBLE LINE 24 INCH AND OVER)
		UNDERGROUND WATER MAIN (DOUBLE LINE 24 INCH AND OVER)
		BALANCE STONE WALL
		GUARD RAIL - STEEL POSTS
		GUARD RAIL - WOOD POSTS
		CHAIN LINK OR METAL FENCE
		WOOD FENCE
		HAY BALES/SILT FENCE
		TREE LINE OR LIMIT OF CLEARING AND GRUBBING
		SAWCUT LINE
		TOP OR BOTTOM OF SLOPE
		LIMIT OF EDGE OF PAVEMENT OR COLD PLANE AND OVERLAY
		BANK OF RIVER OR STREAM
		BORDER OF WETLAND
		100 FT WETLAND BUFFER
		200 FT RIVERFRONT BUFFER
		STATE HIGHWAY LAYOUT
		TOWN OR CITY LAYOUT
		COUNTY LAYOUT
		RAILROAD SIDELINE
		TOWN OR CITY BOUNDARY LINE
		PROPERTY LINE OR APPROXIMATE PROPERTY LINE
		EASEMENT

TRAFFIC SYMBOLS		
EXISTING	PROPOSED	DESCRIPTION
		CONTROLLER PHASE ACTUATED
		TRAFFIC SIGNAL HEAD (SIZE AS NOTED)
		WIRE LOOP DETECTOR (6' x 6' TYP UNLESS OTHERWISE SPECIFIED)
		VIDEO DETECTION CAMERA
		MICROWAVE DETECTOR
		PEDESTRIAN PUSH BUTTON, SIGN (DIRECTIONAL ARROW AS SHOWN) AND SADDLE
		EMERGENCY PREEMPTION CONFIRMATION STROBE LIGHT
		VEHICULAR SIGNAL HEAD
		VEHICULAR SIGNAL HEAD, OPTICALLY PROGRAMMED
		FLASHING BEACON
		PEDESTRIAN SIGNAL HEAD, (TYPE AS NOTED OR AS SPECIFIED)
		RAILROAD SIGNAL
		SIGNAL POST AND BASE (ALPHA-NUMERIC DESIGNATION NOTED)
		MAST ARM, SHAFT AND BASE (ARM LENGTH AS NOTED)
		HIGH MAST POLE OR TOWER
		MAST ARM WITH LUMINAIRE
		OPTICAL PRE-EMPTION DETECTOR
		CONTROL CABINET, GROUND MOUNTED
		CONTROL CABINET, POLE MOUNTED
		FLASHING BEACON CONTROL AND METER PEDESTAL
		LOAD CENTER ASSEMBLY
		PULL BOX 12"x12" (OR AS NOTED)
		ELECTRIC HANDHOLE 12"x24" (OR AS NOTED)
		TRAFFIC SIGNAL CONDUIT

PAVEMENT MARKINGS SYMBOLS		
EXISTING	PROPOSED	DESCRIPTION
		PAVEMENT ARROW - WHITE
		LEGEND "ONLY" - WHITE
		STOP LINE
		CROSSWALK
		SOLID WHITE LINE
		SOLID YELLOW LINE
		BROKEN WHITE LINE
		BROKEN YELLOW LINE
		DOTTED WHITE LINE
		DOTTED YELLOW LINE
		DOTTED WHITE LINE EXTENSION
		DOTTED YELLOW LINE EXTENSION
		DOUBLE WHITE LINE
		DOUBLE YELLOW LINE

PROJECT: **MINUTEMAN BIKEWAY IMPROVEMENTS AT LAKE STREET**

DESIGN SUBMISSION: **DRAFT FINAL DESIGN**

DRAWING TITLE: **PLAN SYMBOLS**

PREPARED FOR: **TOWN OF ARLINGTON ENGINEERING DIVISION**
51 GROVE STREET
ARLINGTON, MA 02476

PREPARED BY: **GREEN INTERNATIONAL AFFILIATES, INC.**
Civil and Structural Engineers
Westford, Massachusetts (978) 923-0400
GreenIntf.com

SCALE: AS NOTED DESIGNED BY: JG
DATE: 09/15/2017 DRAWN BY: JG
PROJECT NO. 17067.015 CHECKED BY: JS SHEET NO. 02 OF 26

NO.	DATE	REVISIONS

P:\Projects\2017\CONCURRENT DEFENSE PLAN SYMBOLS.dwg, Pinned, 09/20/2017 2:28 PM

GENERAL NOTES

1. THE WORK UNDER THIS PROJECT INCLUDES BUT IS NOT LIMITED TO FULL DEPTH BIKEWAY CONSTRUCTION, PAVEMENT RESURFACING, RECONSTRUCTION OF A HOT MIX ASPHALT SIDEWALK, INSTALLATION OF DRAINAGE STRUCTURES AND PIPES, PLACEMENT OF PAVEMENT MARKINGS, PROTECTION OF EXISTING UTILITIES TO REMAIN, GRADING, INSTALLATION OF TRAFFIC SIGNS, INSTALLATION OF NEW SIGNAL EQUIPMENT, AND TRAFFIC MAINTENANCE DURING CONSTRUCTION.
2. THE CONTRACTOR SHALL NOTIFY THE ENGINEER OF ALL CONFLICTS BETWEEN THE EXISTING UTILITIES AND PROPOSED WORK. THE ENGINEER RESERVES THE RIGHT TO MODIFY THE DESIGN TO REALIGN PIPING AND STRUCTURE LOCATIONS AND INVERTS TO SUIT ACTUAL FIELD CONDITIONS ENCOUNTERED.
3. ALL EXISTING STREET NAME, REGULATORY, GUIDE, AND WARNING SIGNS, INCLUDING POSTS, WITHIN THE LIMITS OF WORK ARE TO BE RETAINED UNLESS OTHERWISE NOTED.
4. THE CONTRACTOR SHALL RETAIN AND PROTECT ALL CURBS, FENCES, WALLS, TREES, SHRUBS, POSTS, LANDSCAPE FEATURES, AND OTHER MISCELLANEOUS ITEMS WITHIN ABUTTING PROPERTIES UNLESS OTHERWISE NOTED. WHEN RETAINING THOSE ITEMS IS NOT PRACTICAL IN THE OPINION OF THE ENGINEER, THE CONTRACTOR SHALL REMOVE, STOCKPILE, PROTECT AND RESET THE ITEMS. THE CONTRACTOR SHALL REPLACE ITEMS DAMAGED DURING REMOVAL, STOCKPILING, OR RESETTING DUE TO NEGLIGENCE, CARELESSNESS, OR MISHANDLING WITH EQUIVALENT NEW ITEMS AT NO COST TO THE TOWN.
5. THE CONTRACTOR SHALL PROVIDE ALL SAFETY CONTROL (SIGNS, REFLECTORIZED DRUMS, ETC) FOR CONSTRUCTION OPERATIONS IN ACCORDANCE WITH THE TRAFFIC MANAGEMENT PLANS INCLUDED HEREIN AND THE 2009 MANUAL ON UNIFORM TRAFFIC CONTROL DEVICES. PROVIDING SAFETY CONTROLS SHALL BE INCLUDED IN THE COST OF ITEM 852. SAFETY SIGNING FOR TRAFFIC MANAGEMENT, ITEM 859. REFLECTORIZED DRUM, AND ITEM 999.001 POLICE DETAIL.
6. ALL TREES SHALL BE RETAINED AND PROTECTED UNLESS OTHERWISE NOTED. THE COSTS FOR PROTECTION SHALL BE INCIDENTAL TO THE CONTRACT.
7. ALL GRATES, FRAMES AND COVERS OF STRUCTURES TO BE REMOVED OR ABANDONED SHALL BE DELIVERED BY THE CONTRACTOR TO THE TOWN OF ARLINGTON HIGHWAY DEPARTMENT AND STACKED AT A LOCATION DESIGNATED BY THE TOWN.
8. ALL UTILITIES AND THEIR APPURTENANCES SHALL BE RETAINED AND PROTECTED UNLESS OTHERWISE NOTED
9. ALL RCP SHALL BE CLASS III UNLESS OTHERWISE NOTED.

PLAN NOTES

1. THE BASE MAP IS COMPILED FROM AN ACTUAL-ON-THE-GROUND TOPOGRAPHIC SURVEY PERFORMED BY GREEN INTERNATIONAL AFFILIATES, INC. JULY, 2017
2. THIS DRAWING WAS PREPARED SOLELY FOR AND IS INTENDED FOR THE WORK ASSOCIATED WITH THIS PROJECT. THE USE OR REUSE OF THESE DRAWINGS FOR OTHER PURPOSES OR BY PARTIES NOT DIRECTLY CONTRACTED TO THIS PROJECT IS PROHIBITED WITHOUT PRIOR WRITTEN PERMISSION.
3. HORIZONTAL AND VERTICAL CONTROL WAS ESTABLISHED BY GREEN ON JULY 21, 2017 WITH STATIC GPS VECTORS CALCULATED BY NATIONAL GEODETIC SURVEY'S OPUS SERVICE. HORIZONTAL DATUM IS BASED ON THE MASSACHUSETTS STATE PLANE COORDINATE SYSTEM, NAD83 (2011) EPOCH 2010.0000, VERTICAL DATUM IS NAVD 88 (COMPUTED USING GEOID12B) CONVERTED TO ARLINGTON TOWN BASE.
4. THE RIGHT OF WAY LINES SHOWN ON THIS BASE MAP ARE THE DIRECT RESULT OF AN INSTRUMENT SURVEY PERFORMED ON THE GROUND BY GREEN AND FROM PLANS AND DEEDS OF RECORD. PRIVATE PROPERTY LINES HAVE NOT BEEN SURVEYED, THEY ARE COMPILED FROM GIS & RECORD PLAN INFORMATION AND SHOULD BE CONSIDERED APPROXIMATE.
5. UNDERGROUND UTILITIES SHOWN ARE BASED UPON FIELD OBSERVATIONS AND PLANS OF RECORD. THESE UTILITIES ARE NOT WARRANTED TO BE CORRECT NOR IS IT WARRANTED THAT ALL UNDERGROUND UTILITIES ARE SHOWN.

UTILITY NOTES

1. THE CONTRACTOR IS HEREBY MADE AWARE THAT EXISTING UTILITIES, INCLUDING BUT NOT LIMITED TO EXISTING WATER AND DRAIN PIPES; DRAINAGE AND SEWER STRUCTURES; GAS LINES, COMMUNICATION LINES AND UTILITY POLES, MAY NEED TO BE PROTECTED AND/OR SHORED UP DURING THE CONSTRUCTION OF THE PROPOSED IMPROVEMENTS UNDER THIS PROJECT. THE COST OF THE WORK REQUIRED FOR THE PROTECTION, MAINTENANCE AND SUPPORT OF THESE OR OTHER EXISTING ABOVEGROUND OR UNDERGROUND UTILITIES IN THE VICINITY OF THE PROPOSED WORK SHALL NOT BE PAID FOR SEPARATELY BUT SHALL BE CONSIDERED INCIDENTAL TO THE WORK UNDER THIS CONTRACT.
2. THIS PLAN WAS PREPARED IN CONFORMANCE WITH AMERICAN SOCIETY OF CIVIL ENGINEERS STANDARD CI/ASCE 38-02 "STANDARD GUIDELINE FOR THE COLLECTION AND DEPICTION OF EXISTING SUBSURFACE UTILITY DATA", QL"C". REFER TO UTILITY QUALITY LEVEL INFORMATION INDEX. ACCURACY OF UTILITY LOCATIONS IS NOT GUARANTEED.
3. BELOW GROUND STRUCTURES, UNLESS DIMENSIONED, ARE SYMBOLIC ONLY.
4. PRIOR TO THE START OF ANY WORK ON THE SITE, THE CONTRACTOR SHALL VERIFY THE ACTUAL LOCATION OF ALL UTILITIES, SHOWN OR NOT SHOWN ON THIS PLAN. CONTACT DIG-SAFE AT 1-888-344-7233 (1-888-DIG-SAFE) AT LEAST 72 HOURS PRIOR TO THE START OF EXCAVATION.
5. IF AN EXISTING PIPE TO BE REMOVED EXTENDS OUTSIDE THE PROPOSED ROADWAY LIMIT, IT SHALL BE CUT BEYOND THE ROADWAY AND CAPPED AT NO ADDITIONAL COST.

UTILITY QUALITY LEVEL INFORMATION INDEX (SEE ASCE/CI 38-02):

UTILITY QUALITY LEVEL A:
PRECISE HORIZONTAL AND VERTICAL LOCATION OF UTILITIES OBTAINED BY THE ACTUAL EXPOSURE (OR VERIFICATION OF PREVIOUSLY EXPOSED AND SURVEYED UTILITIES) AND SUBSEQUENT MEASUREMENT OF SUBSURFACE UTILITIES, USUALLY AT A SPECIFIC POINT. MINIMALLY INTRUSIVE EXCAVATION EQUIPMENT IS TYPICALLY USED TO MINIMIZE THE POTENTIAL FOR UTILITY DAMAGE. A PRECISE HORIZONTAL AND VERTICAL LOCATION, AS WELL AS OTHER UTILITY ATTRIBUTES, IS SHOWN ON PLAN DOCUMENTS. ACCURACY IS TYPICALLY SET TO 15-MM VERTICAL AND TO APPLICABLE HORIZONTAL SURVEY AND MAPPING ACCURACY AS DEFINED OR EXPECTED BY THE PROJECT OWNER. INFORMATION IS ONLY VALID WITHIN THE VISIBLE LIMITS OF THE TEST HOLE.

UTILITY QUALITY LEVEL B:
INFORMATION OBTAINED THROUGH THE APPLICATION OF APPROPRIATE SURFACE GEOPHYSICAL METHODS TO DETERMINE THE EXISTENCE AND APPROXIMATE HORIZONTAL POSITION OF SUBSURFACE UTILITIES. QUALITY LEVEL B DATA SHOULD BE REPRODUCIBLE BY SURFACE GEOPHYSICS AT ANY POINT OF THEIR DEPICTION. THIS INFORMATION IS SURVEYED TO APPLICABLE TOLERANCES DEFINED BY THE PROJECT AND REDUCED ONTO PLAN DOCUMENTS.


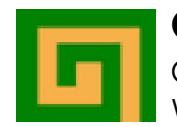
UTILITY QUALITY LEVEL C:
INFORMATION OBTAINED BY SURVEYING AND PLOTTING VISIBLE ABOVE-GROUND UTILITY FEATURES AND BY USING PROFESSIONAL JUDGMENT IN CORRELATING THIS INFORMATION TO QUALITY LEVEL D INFORMATION.




UTILITY QUALITY LEVEL D:
INFORMATION DERIVED FROM EXISTING RECORDS OR ORAL RECOLLECTIONS.

DRAINAGE NOTES

1. COMPACTED ¾" CRUSHED STONE SHALL BE PLACED TO A MINIMUM DEPTH OF 12" BENEATH ALL NEW MANHOLES AND CATCH BASINS.
2. COMPACTED ¾" CRUSHED STONE SHALL BE PLACED TO A MINIMUM DEPTH OF 6" BELOW THE INVERT OF ALL DRAINAGE PIPES UP TO THE SPRING LINE OF THE PROPOSED PIPE, AS SHOWN IN THE TYPICAL PIPE TRENCH DETAIL (SEE SHEET 19).
3. ALL OFFSETS TO THE CATCH BASINS ARE TO THE BACK CENTER OF THE GRATE. THE LOCATION AND ORIENTATION OF THE BELOW GRADE STRUCTURE SHALL BE FIELD COORDINATED BY THE CONTRACTOR TO AVOID CONFLICTS WITH EXISTING UTILITIES.
4. ALL STRUCTURES SHALL HAVE ECCENTRIC CONES UNLESS THEY ARE FLAT SLABS OR AS OTHERWISE REQUIRED BY THE ENGINEER.
5. ALL STRUCTURES SHALL MEET HS-25 LOADING.
6. ALL STRUCTURES TO BE MANUFACTURED TO MEET OR EXCEED ASTM C-478 AND AASHTO M199 SPECS.
7. ALL REINFORCING FOR EACH STRUCTURE SHALL CONFORM TO ASTM A-165 AND BE PLACED AS PER ASTM C-478.
8. ALL CONCRETE TO BE 4000 PSI (MINIMUM) CEMENT PER ASTM C-478.
9. BUTYL RUBBER JOINT SEALANT PER ASTM C-990 AND AASHTO M-198. WATERPROOFING PER CONTRACT SPECS.

P:\Projects\2017\17067\015\GENERAL NOTES.dwg Plot Date: 09/15/2017 12:36 PM

LIGHTING DESIGN SERVICES LUMEN STUDIO, INC.		PREPARED FOR:  TOWN OF ARLINGTON ENGINEERING DIVISION 51 GROVE STREET ARLINGTON, MA 02476	
ELETRICAL WIRING DESIGN SERVICES ENGINEERING ADVANTAGE, INC.		PREPARED BY:  GREEN INTERNATIONAL AFFILIATES, INC. Civil and Structural Engineers (978) 923-0400 Westford, Massachusetts GreenIntl.com	
NO.	DATE	REVISIONS	SCALE: AS NOTED DATE: 09/15/2017 PROJECT NO. 17067.015
			DESIGNED BY: JG DRAWN BY: JG CHECKED BY: JS
			SHEET NO. 03 OF 26

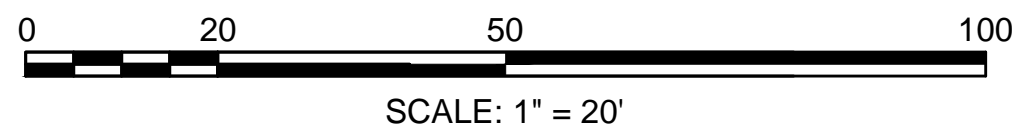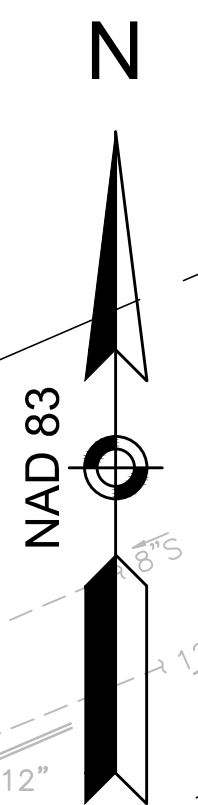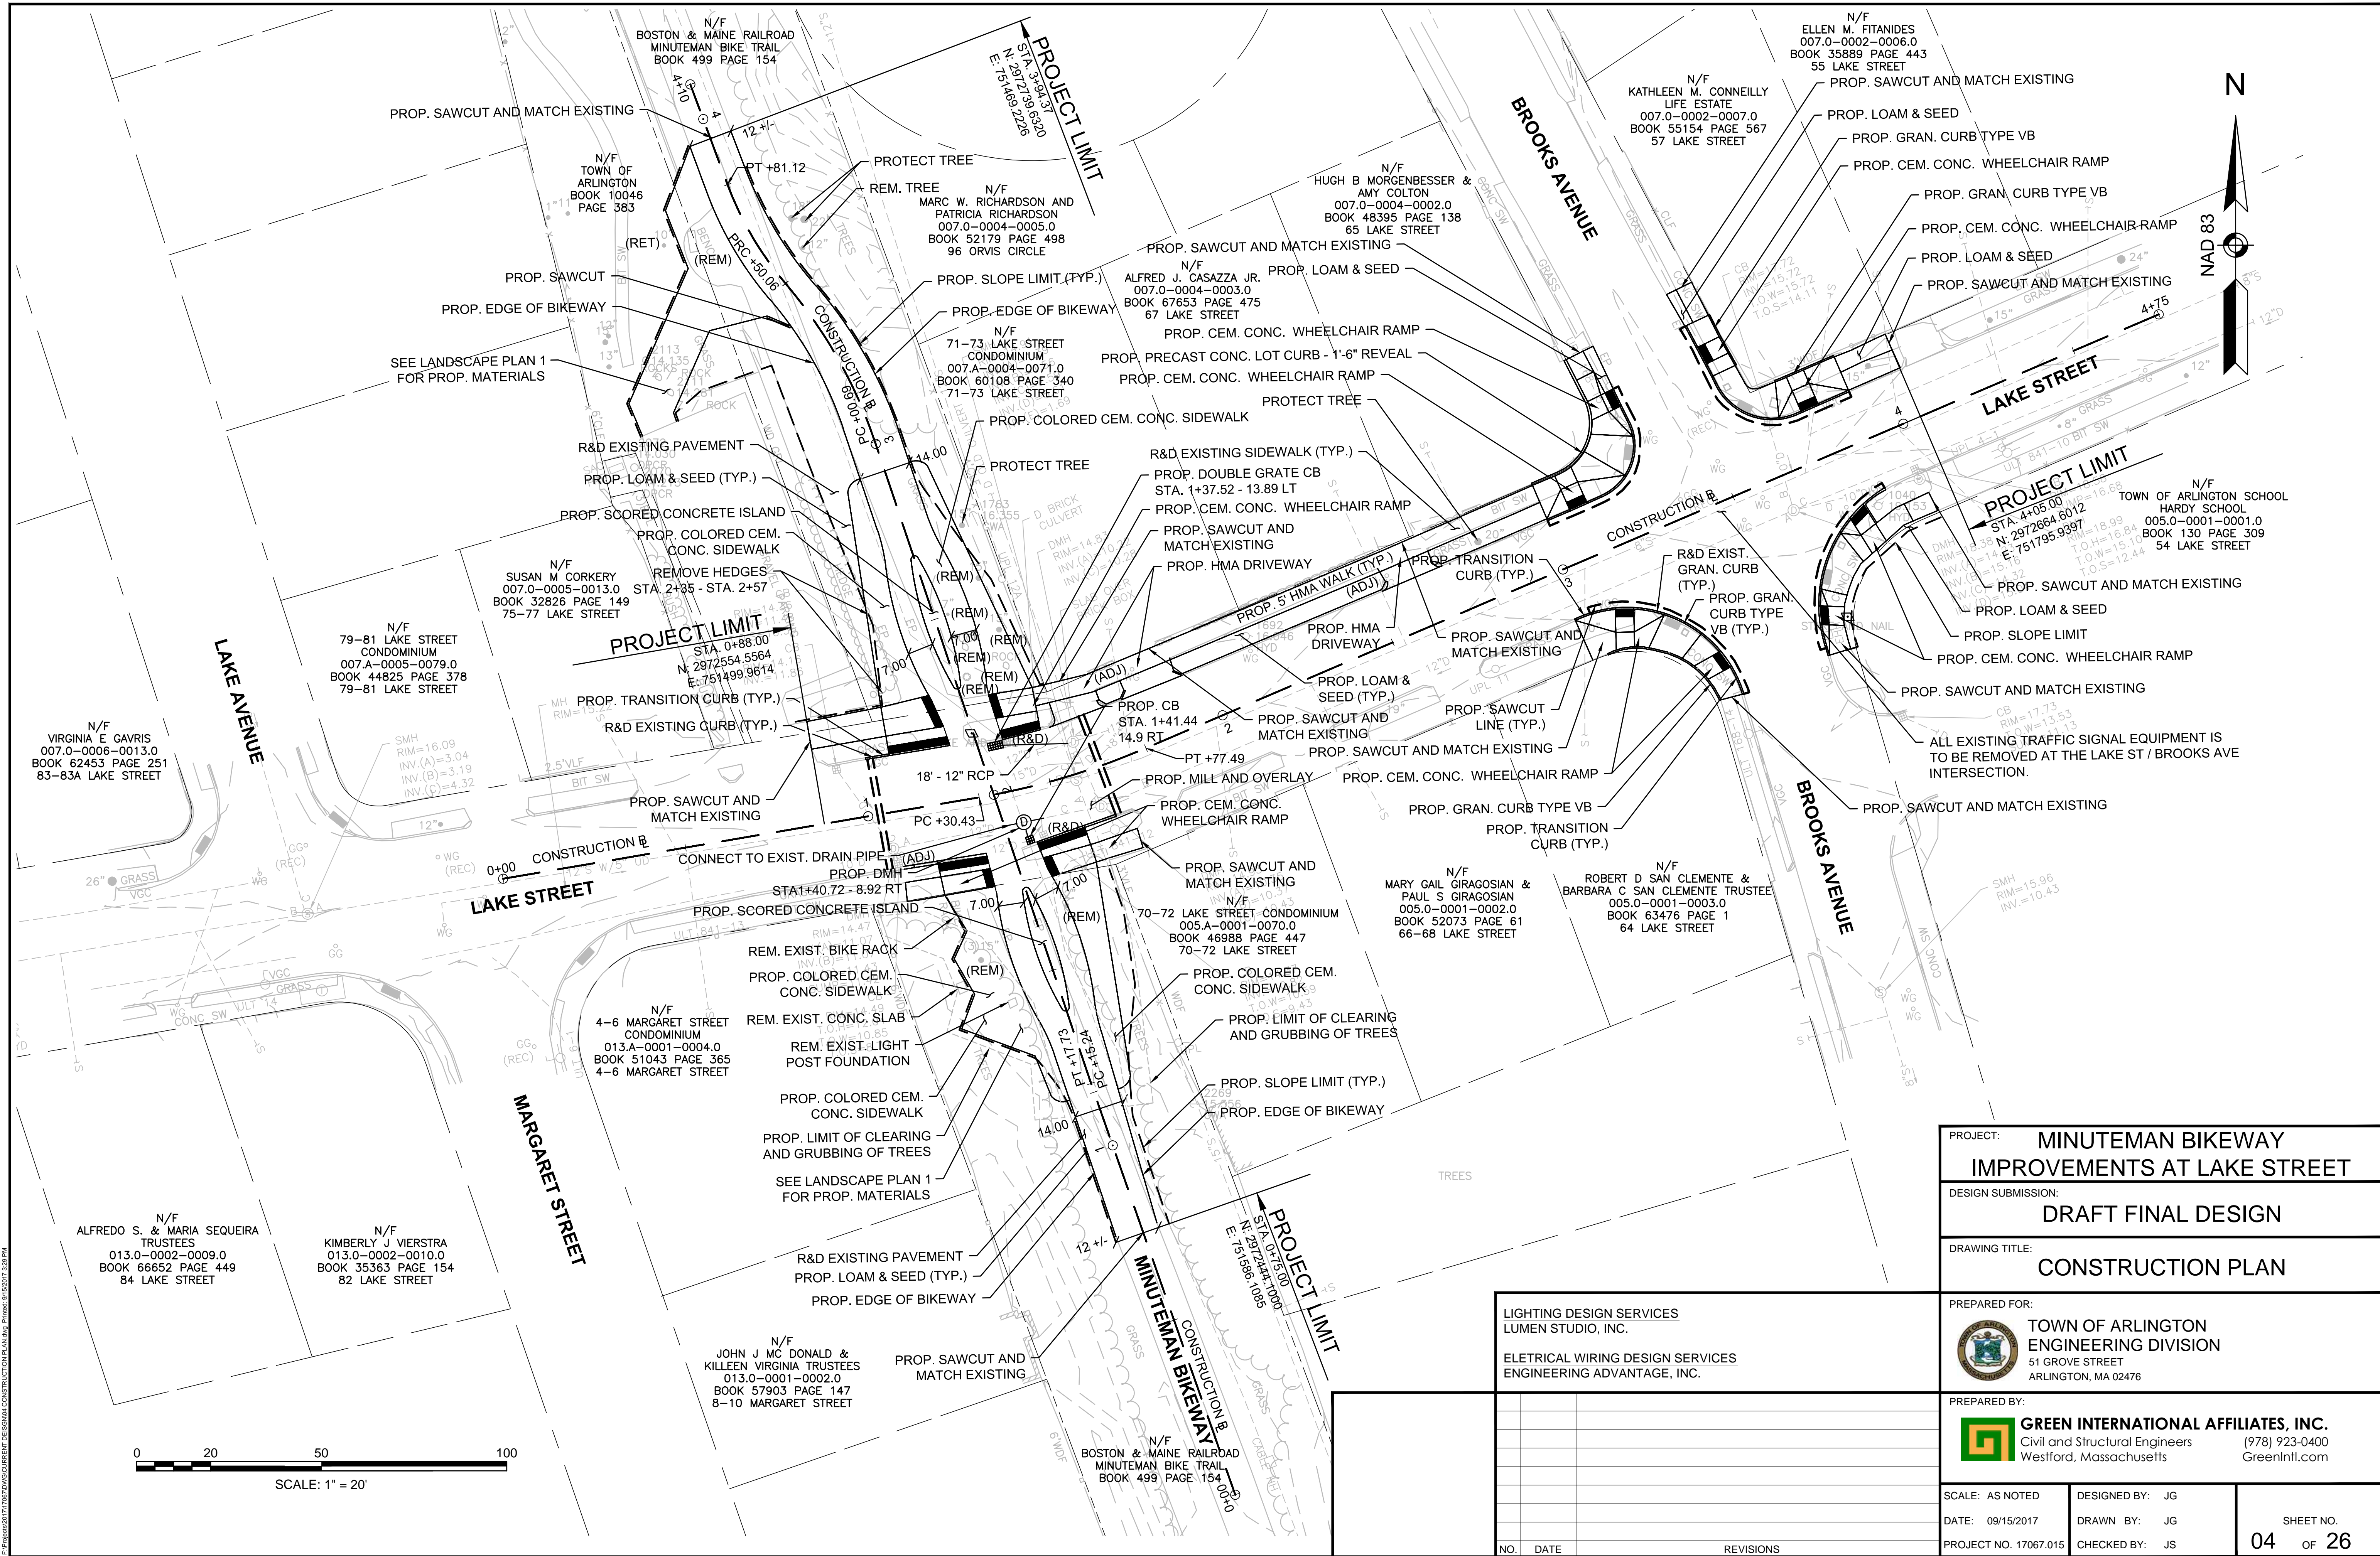

PROJECT: **MINUTEMAN BIKEWAY IMPROVEMENTS AT LAKE STREET**

DESIGN SUBMISSION: **DRAFT FINAL DESIGN**

DRAWING TITLE: **CONSTRUCTION PLAN**

PREPARED FOR:



**TOWN OF ARLINGTON
ENGINEERING DIVISION**
51 GROVE STREET
ARLINGTON, MA 02476

PREPARED BY:



GREEN INTERNATIONAL AFFILIATES, INC.
Civil and Structural Engineers
Westford, Massachusetts (978) 923-0400
GreenIntl.com


LIGHTING DESIGN SERVICES
LUMEN STUDIO, INC.

ELECTRICAL WIRING DESIGN SERVICES
ENGINEERING ADVANTAGE, INC.

SCALE: AS NOTED	DESIGNED BY: JG	SHEET NO. 04 OF 26
DATE: 09/15/2017	DRAWN BY: JG	
PROJECT NO. 17067.015	CHECKED BY: JS	


NO.	DATE	REVISIONS

© 2017 GREEN INTERNATIONAL AFFILIATES, INC. ALL RIGHTS RESERVED. THIS DRAWING IS THE PROPERTY OF GREEN INTERNATIONAL AFFILIATES, INC. AND IS NOT TO BE REPRODUCED OR TRANSMITTED IN ANY FORM OR BY ANY MEANS, ELECTRONIC OR MECHANICAL, WITHOUT PERMISSION IN WRITING FROM GREEN INTERNATIONAL AFFILIATES, INC.

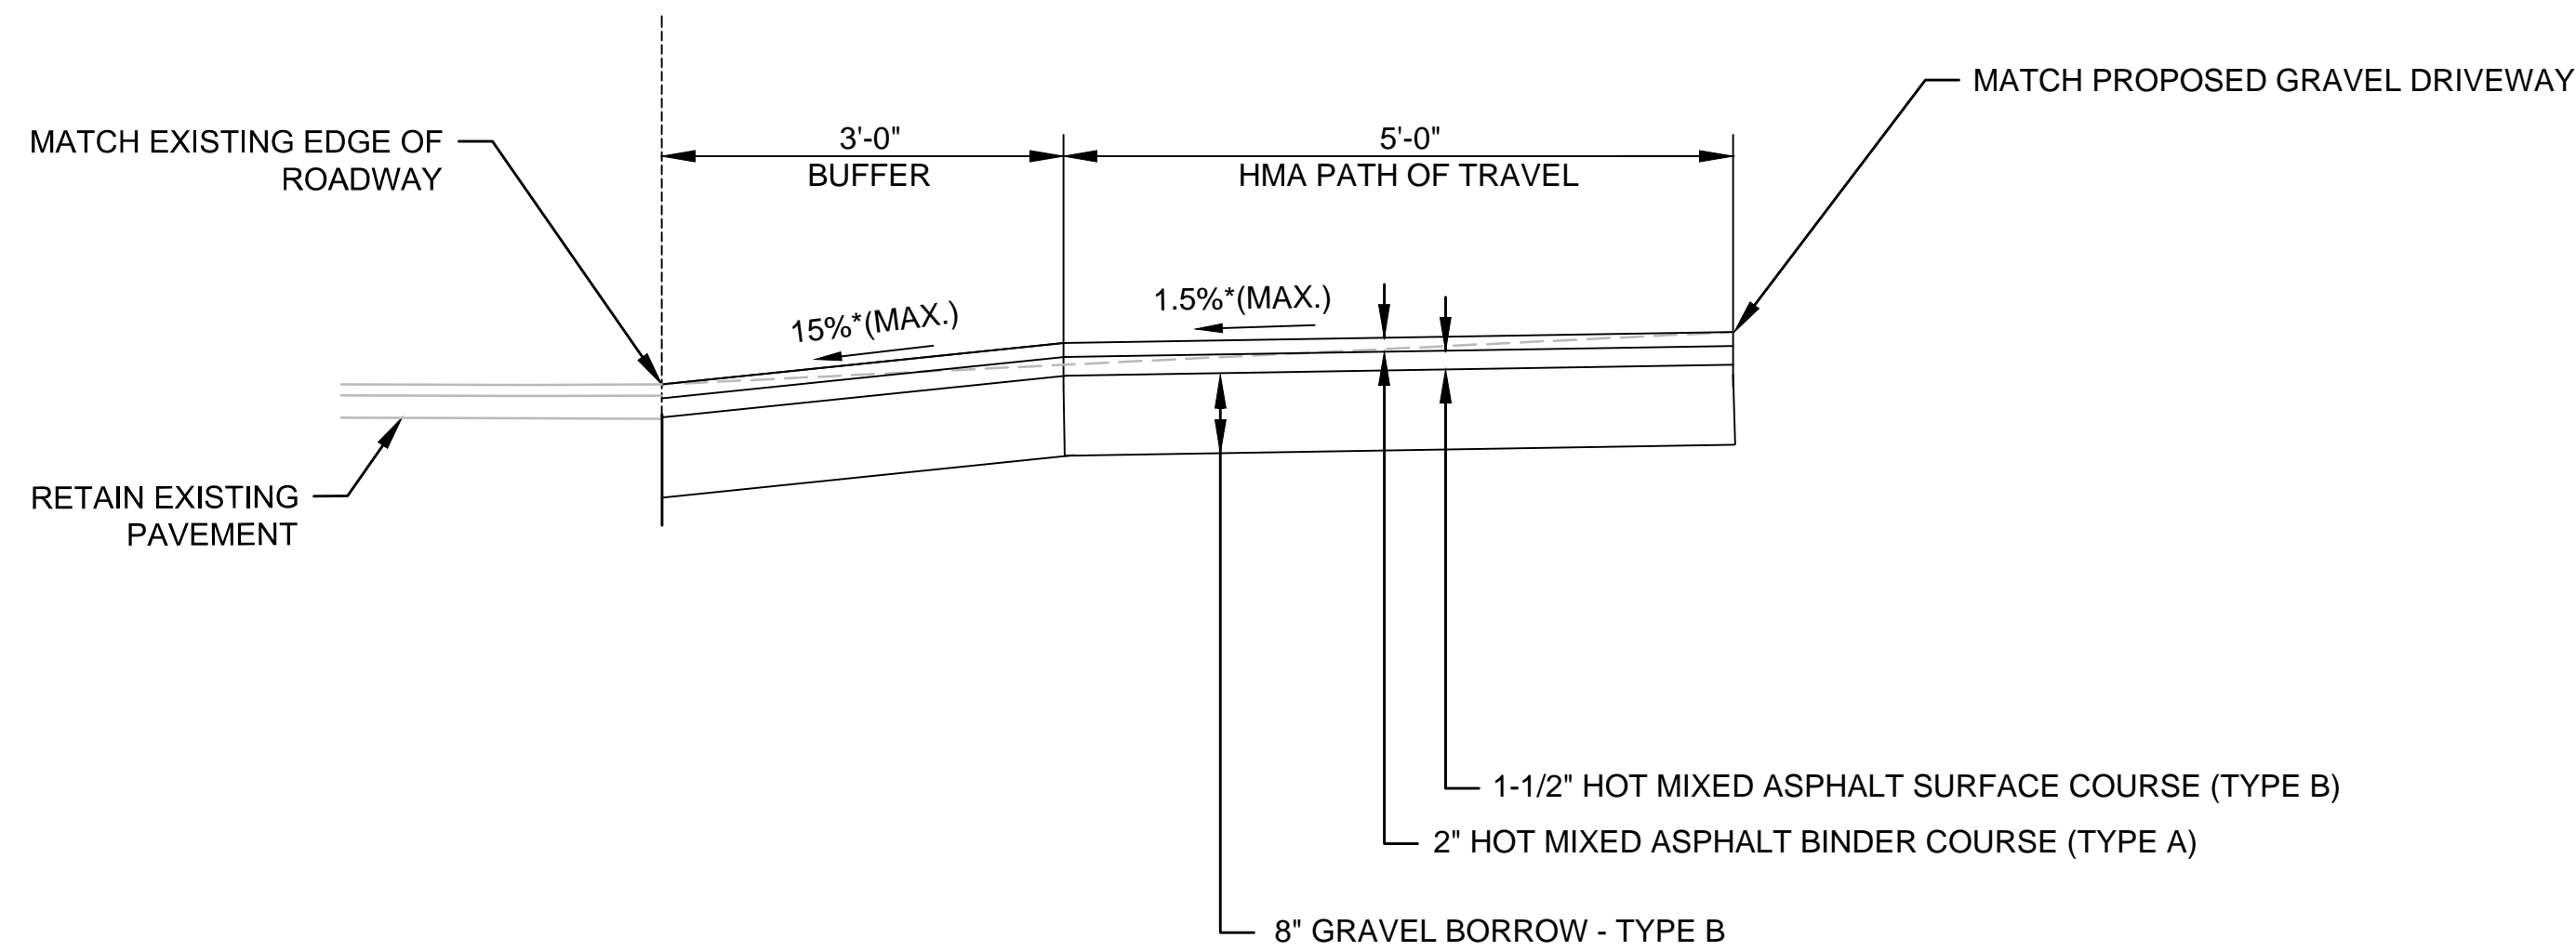

RESIDENTIAL DRIVEWAY DETAIL

NOT TO SCALE

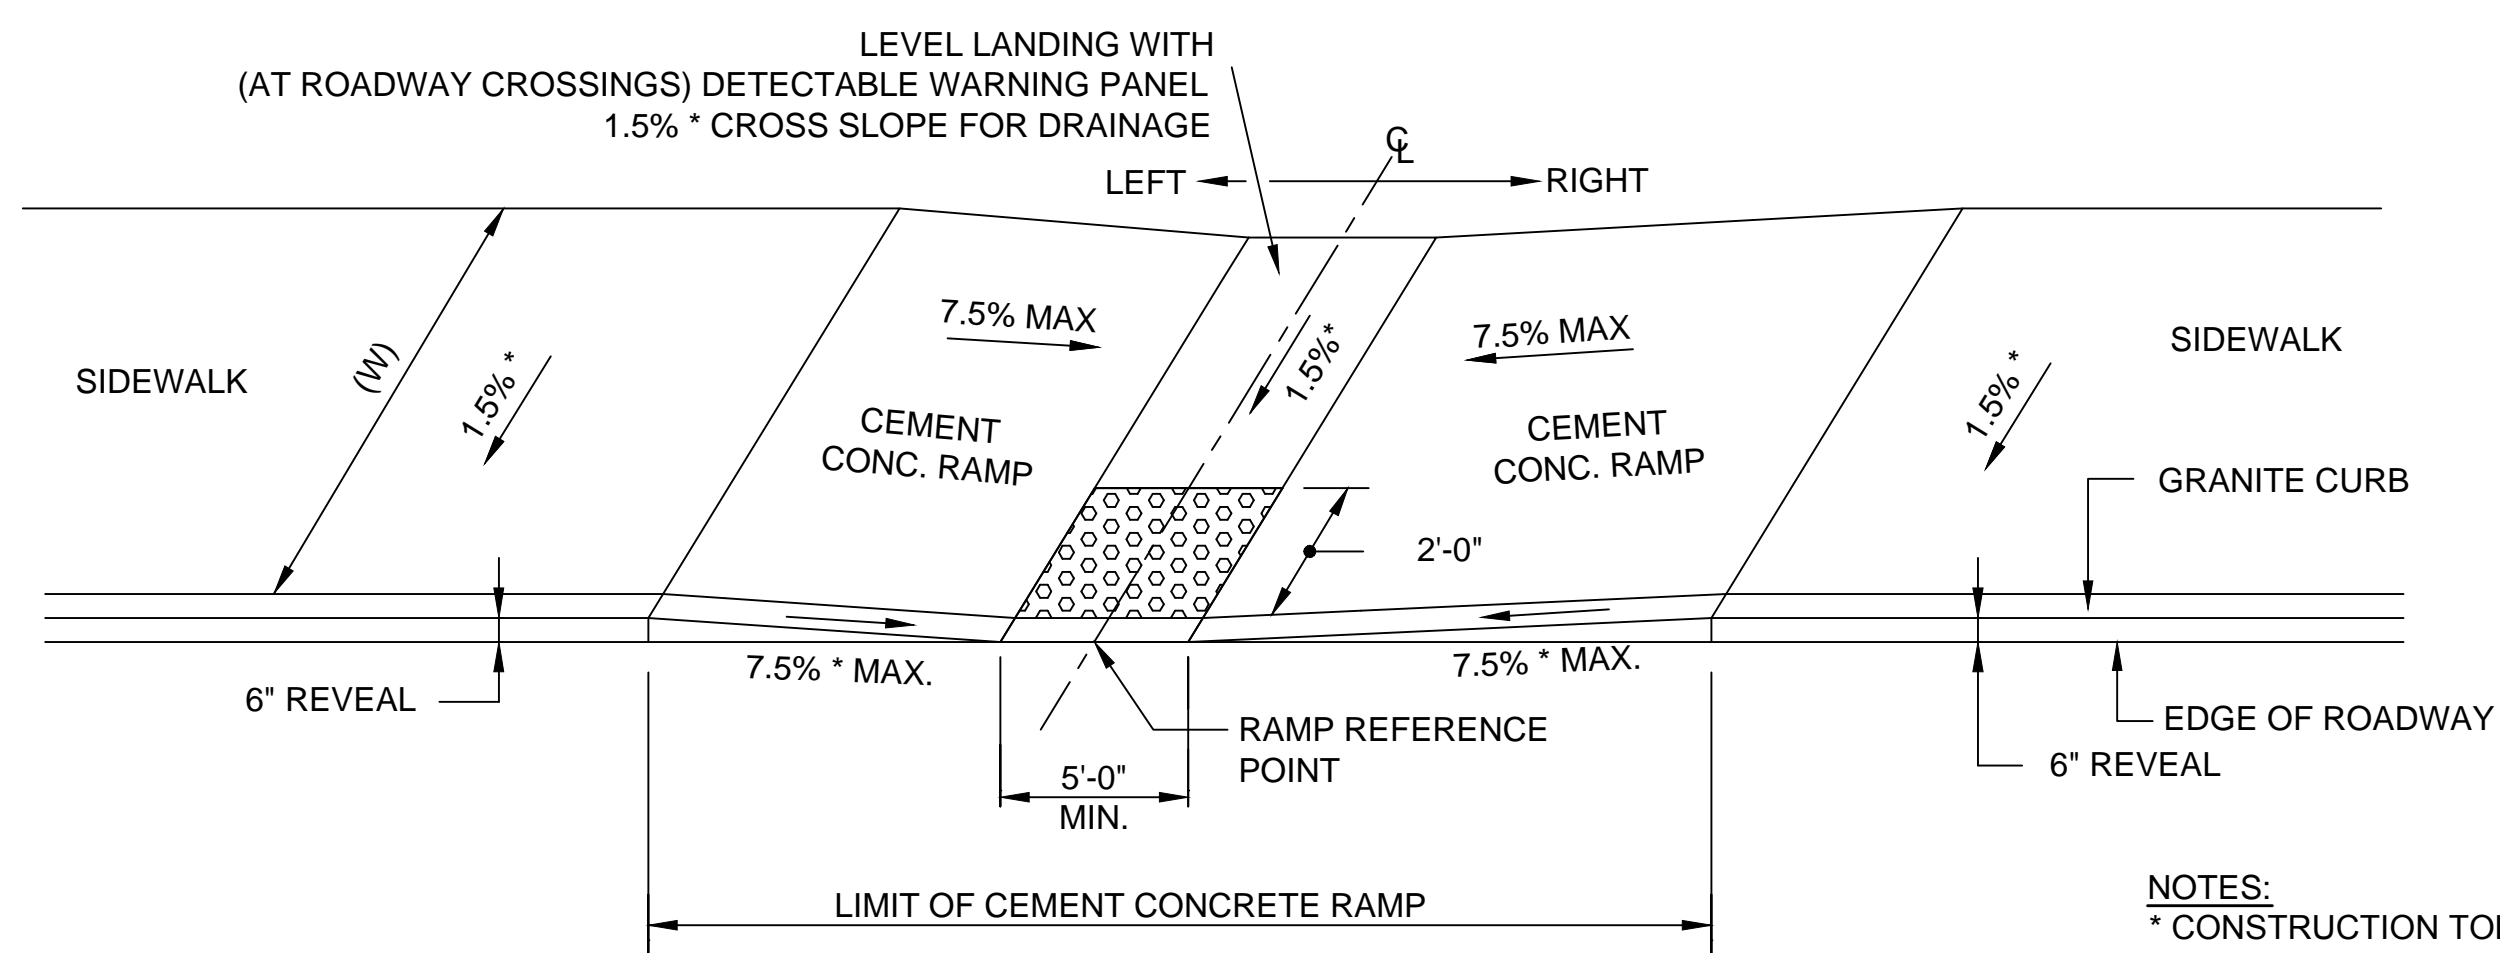

CURB CUT RAMP (NARROW SIDEWALK) DETAIL E 107.2.1

NOT TO SCALE

NOTES:
 * CONSTRUCTION TOLERANCE ± 0.5%
 - DETECTABLE WARNING PANELS SHALL BE INSTALLED IN ACCORDANCE WITH CONSTRUCTION STD E 107.6.5

WCR #	BASELINE	RAMP REFERENCE POINT		WIDTH OF RAMP (FT.)	WIDTH OF SIDEWALK (W) (FT.)	TRANSITION LENGTH		3" REVEAL	6" REVEAL
		STATION	OFFSET			LEFT SIDE	RIGHT SIDE		
7	LAKE ST	03+30.55	38.66 RT	5'-0"	6'-6"	6'-6"	3'-10"	RIGHT SIDE	LEFT SIDE
11	LAKE ST	03+57.09	38.32 LT	5'-0"	6'-6"	6'-6"	3'-10"	RIGHT SIDE	LEFT SIDE

PAVEMENT NOTES

PROPOSED BIKEWAY

SURFACE: 3 1/2" HOT MIX ASPHALT PAVEMENT PLACED IN TWO LAYERS
 1 3/4" TOP COURSE MATERIAL OVER 1 3/4" BINDER COURSE MATERIAL
SUBBASE: 8" GRAVEL BORROW (TYPE B)

PROPOSED PAVEMENT MILLING AND RESURFACING

SURFACE: 2" HOT MIX ASPHALT MODIFIED TOP COURSE
 ±2" PAVEMENT MILLING
 (VARIABLE DEPTH TO MEET PROPOSED GRADING)

NOTE:

ASPHALT EMULSION FOR TACK COAT (RS-1) SHALL BE APPLIED AT A RATE OF 0.05 GAL/SY OVER NEW AND SMOOTH INTERMEDIATE COURSES.
 ASPHALT EMULSION FOR TACK COAT (RS-1) SHALL BE APPLIED AT A RATE OF 0.07 GAL/SY OVER MILLED SURFACES.


PAVEMENT NOTES (CONT.)

PROPOSED HMA DRIVEWAY


SURFACE: 1-1/2" MODIFIED TOP COURSE OVER
 2" HOT MIX ASPHALT BINDER COURSE
BASE: 8" GRAVEL BORROW (TYPE B)

PROPOSED HMA SIDEWALK

SURFACE: 1" HOT MIX ASPHALT SURFACE COURSE
 1 1/2" HOT MIX ASPHALT BINDER COURSE
BASE: 8" GRAVEL BORROW (TYPE B)

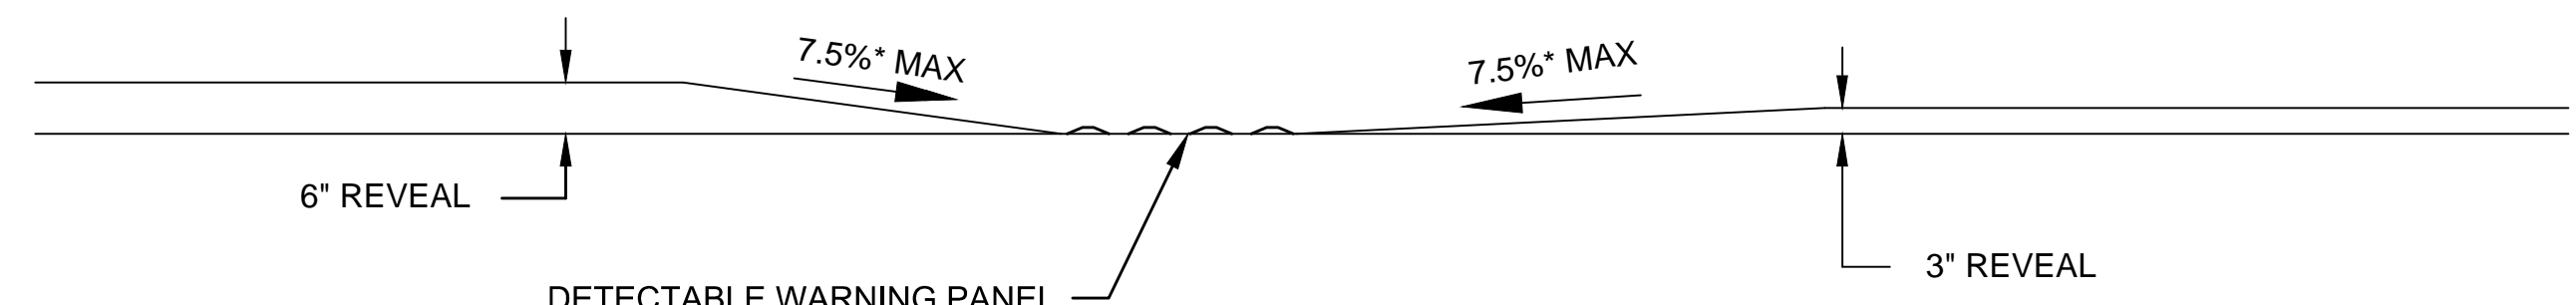

NOTE:
 SIDES OF TRANSITION WITH 6" REVEAL AND 3" REVEAL VARY.

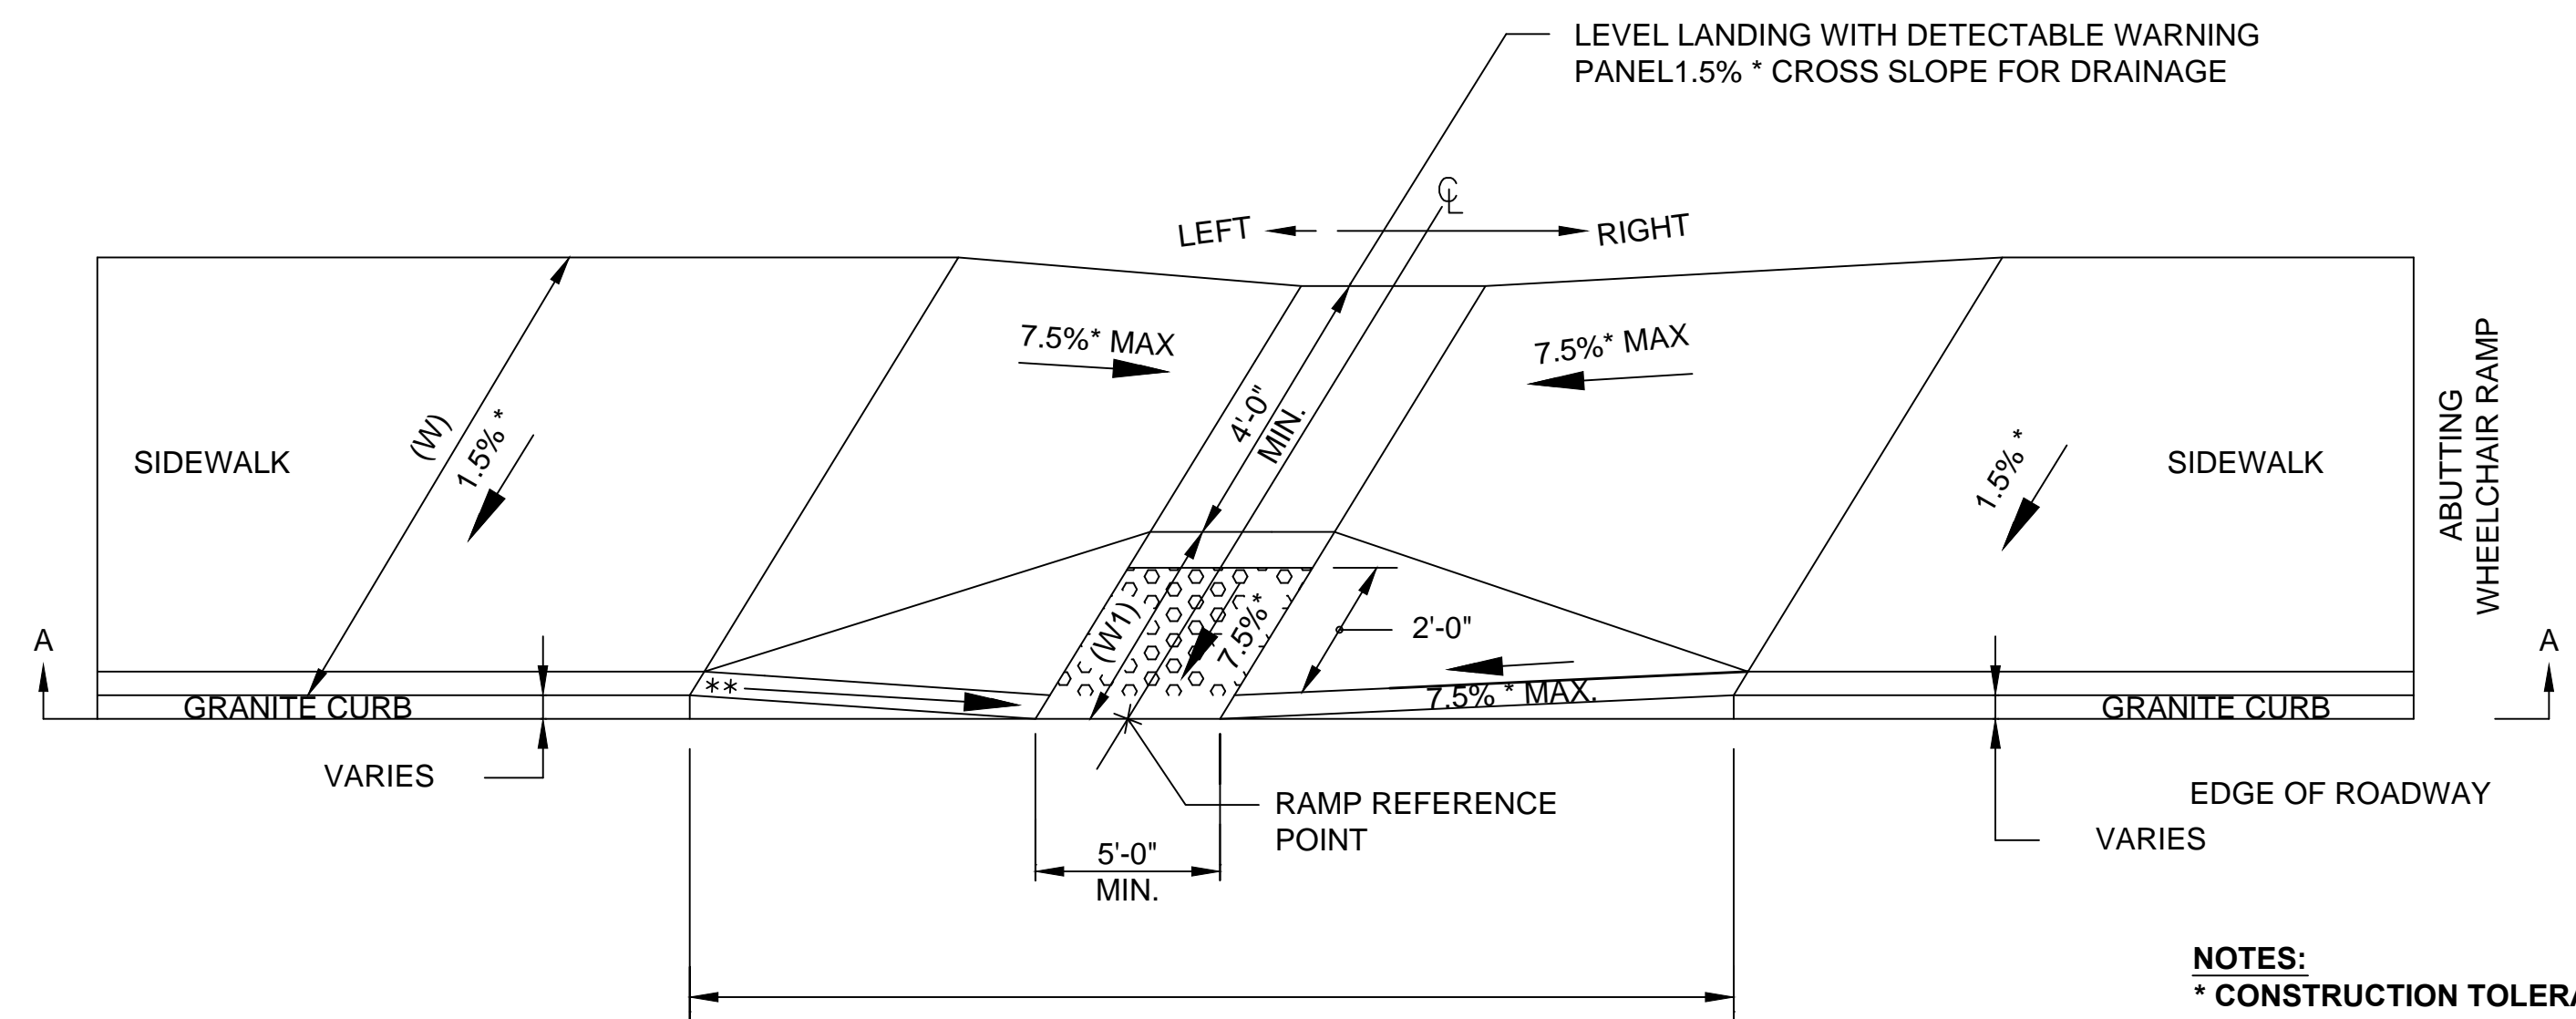

CURB CUT RAMP DETAIL

(LESS THAN 12'-4" SIDEWALK)

NOT TO SCALE

NOTES:
 * CONSTRUCTION TOLERANCE ± 0.5%
 - SEE CONSTRUCTION STANDARD E 107.2.0
 ** SEE CONSTRUCTION STANDARD E 107.9.0 - DETECTABLE WARNING PANELS SHALL BE INSTALLED IN ACCORDANCE WITH CONSTRUCTION STD E 107.6.5
 - CONTRACTOR IS ULTIMATELY RESPONSIBLE FOR CONSTRUCTING RAMPS COMPLIANT WITH ADA/AAB RULES, REGULATIONS AND STANDARDS.
 CONTRACTOR SHALL VERIFY RAMPS ARE ADA/AAB COMPLIANT BEFORE POURING CEMENT CONCRETE.

WCR #	BASELINE	RAMP REFERENCE POINT		WIDTH OF RAMP (FT.)	WIDTH OF SIDEWALK (W) (FT.)	TRANSITION LENGTH		3" REVEAL	6" REVEAL
		STATION	OFFSET			LEFT SIDE	RIGHT SIDE		
5	LAKE ST	03+10.56	13.79 LT	5'-0"	10'-0"	6'-6"	5'-6"	RIGHT SIDE	LEFT SIDE
6	LAKE ST	03+11.02	15.93 RT	5'-0"	11'-6"	6'-6"	3'-10"	LEFT SIDE	RIGHT SIDE
8	LAKE ST	03+59.16	38.70 RT	5'-0"	6'-0"	3'-3"	6'-6"	LEFT SIDE	RIGHT SIDE
9	LAKE ST	03+79.08	16.75 RT	5'-0"	11'-0"	9'-0"	3'-3"	RIGHT SIDE	LEFT SIDE
10	LAKE ST	03+78.42	13.63 LT	5'-0"	9'-9"	3'-3"	9'-0"	LEFT SIDE	RIGHT SIDE
12	LAKE ST	03+31.82	36.99 LT	5'-0"	9'-0"	3'-10"	6'-6"	LEFT SIDE	N/A

PROJECT: **MINUTEMAN BIKEWAY IMPROVEMENTS AT LAKE STREET**

DESIGN SUBMISSION: **DRAFT FINAL DESIGN**

DRAWING TITLE: **CONSTRUCTION DETAILS**

PREPARED FOR:
TOWN OF ARLINGTON ENGINEERING DIVISION
 51 GROVE STREET
 ARLINGTON, MA 02476

PREPARED BY:
GREEN INTERNATIONAL AFFILIATES, INC.
 Civil and Structural Engineers (978) 923-0400
 Westford, Massachusetts GreenIntl.com

SCALE: AS NOTED
 DATE: 09/15/2017
 PROJECT NO. 17067.015
 DESIGNED BY: JG
 DRAWN BY: JG
 CHECKED BY: JS
 SHEET NO. **05** OF **26**

LIGHTING DESIGN SERVICES
 LUMEN STUDIO, INC.
 ELECTRICAL WIRING DESIGN SERVICES
 ENGINEERING ADVANTAGE, INC.

NO.	DATE	REVISIONS


Curve Table				
Curve #	Radius	Length	Tangent	Delta
C1	4.00	5.46	3.255	78°16'11"
C2	50.00	9.90	4.967	11°20'43"
C3	50.00	10.20	5.120	11°41'36"
C4	88.00	35.84	18.170	23°19'57"
C5	81.00	33.72	17.110	23°51'20"
C6	81.00	33.72	17.110	23°51'20"
C7	88.00	36.34	18.435	23°39'49"
C8	35.00	2.01	1.007	3°17'42"
C9	35.00	3.28	1.643	5°22'32"
C10	95.00	38.88	19.718	23°27'07"
C11	88.00	36.49	18.510	23°45'27"
C12	88.00	36.49	18.510	23°45'27"
C13	95.00	38.88	19.718	23°27'07"
C14	50.00	9.95	4.993	11°24'17"
C15	50.00	9.95	4.993	11°24'17"
C16	4.00	5.46	3.255	78°16'11"
C17	4.00	5.46	3.255	78°16'11"
C18	117.00	45.56	23.071	22°18'36"
C19	105.00	40.31	20.408	21°59'53"
C20	107.00	37.30	18.843	19°58'29"
C21	95.00	33.76	17.059	20°21'37"

Line Table	
Line #	Length
L1	52.63
L2	58.17
L3	7.85
L4	34.25
L5	11.31
L6	12.70
L7	5.58
L8	7.35
L9	66.09
L10	23.54
L11	58.44
L12	28.97
L13	50.66
L14	13.18
L15	14.17
L16	17.78
L17	9.85
L18	16.04

Curve Table				
Curve #	Radius	Length	Tangent	Delta
C22	33.00	56.06	37.520	97°20'05"
C23	37.00	49.24	29.036	76°14'45"
C24	17.00	25.97	16.284	87°32'12"
C25	15.00	24.10	15.550	92°05'43"

LAKE ST CONSTRUCTION BASELINE DATA									
NUMBER	STARTING STATION	NORTHING	EASTING	CURVE DATA	LINE DATA	ENDING STATION	NORTHING	EASTING	
L200	0+00.00	2972539.715	751413.222		N80°17'27"E 130.43'	1+30.43	2972561.712	751541.782	
C200	1+30.43	2972561.712	751541.782	R=200.00' Δ=13°28'55" L=47.06' T=23.64'		1+77.49	2972575.008	751586.812	
L201	1+77.49	2972575.008	751586.812		N66°48'32"E 297.51'	4+75.00	2972692.169	751860.287	

MINUTEMAN BIKEWAY CONSTRUCTION BASELINE DATA								
NUMBER	STARTING STATION	NORTHING	EASTING	CURVE DATA	LINE DATA	ENDING STATION	NORTHING	EASTING
L100	0+00.00	2972373.323	751610.920		N19°19'06"W 115.24'	1+15.24	2972482.073	751572.797
C100	1+15.24	2972482.073	751572.797	R=200.00' Δ=0°42'48" L=2.49' T=1.25'		1+17.73	2972484.428	751571.988
L101	1+17.73	2972484.428	751571.988		N18°36'18"W 182.96'	3+00.69	2972657.824	751513.617
C101	3+00.69	2972657.824	751513.617	R=130.00' Δ=21°45'43" L=49.38' T=24.99'		3+50.06	2972700.546	751489.459
C102	3+50.06	2972700.546	751489.459	R=89.00' Δ=19°59'43" L=31.06' T=15.69'		4+10.00	2972754.279	751463.784
L102	4+10.00	2972754.279	751463.784		N20°22'18"W 28.88'			

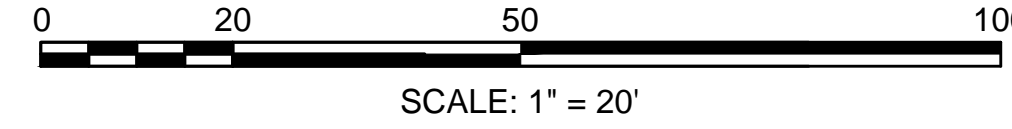

PROJECT: **MINUTEMAN BIKEWAY IMPROVEMENTS AT LAKE STREET**

DESIGN SUBMISSION: **DRAFT FINAL DESIGN**

DRAWING TITLE: **CURB TIE & LAYOUT PLAN**

PREPARED FOR:

TOWN OF ARLINGTON ENGINEERING DIVISION
51 GROVE STREET
ARLINGTON, MA 02476

PREPARED BY:

GREEN INTERNATIONAL AFFILIATES, INC.
Civil and Structural Engineers
Westford, Massachusetts (978) 923-0400
Greenintl.com


LIGHTING DESIGN SERVICES
LUMEN STUDIO, INC.

ELECTRICAL WIRING DESIGN SERVICES
ENGINEERING ADVANTAGE, INC.

SCALE: AS NOTED	DESIGNED BY: JG	SHEET NO. 06 OF 26
DATE: 09/15/2017	DRAWN BY: JG	
PROJECT NO. 17067.015	CHECKED BY: JS	



NO. DATE REVISIONS

P:\Projects\2017\CONCURRENT DESIGN\CONCUR.CURB TIE & LAYOUT PLAN.dwg, Printed: 09/15/2017 2:38 PM

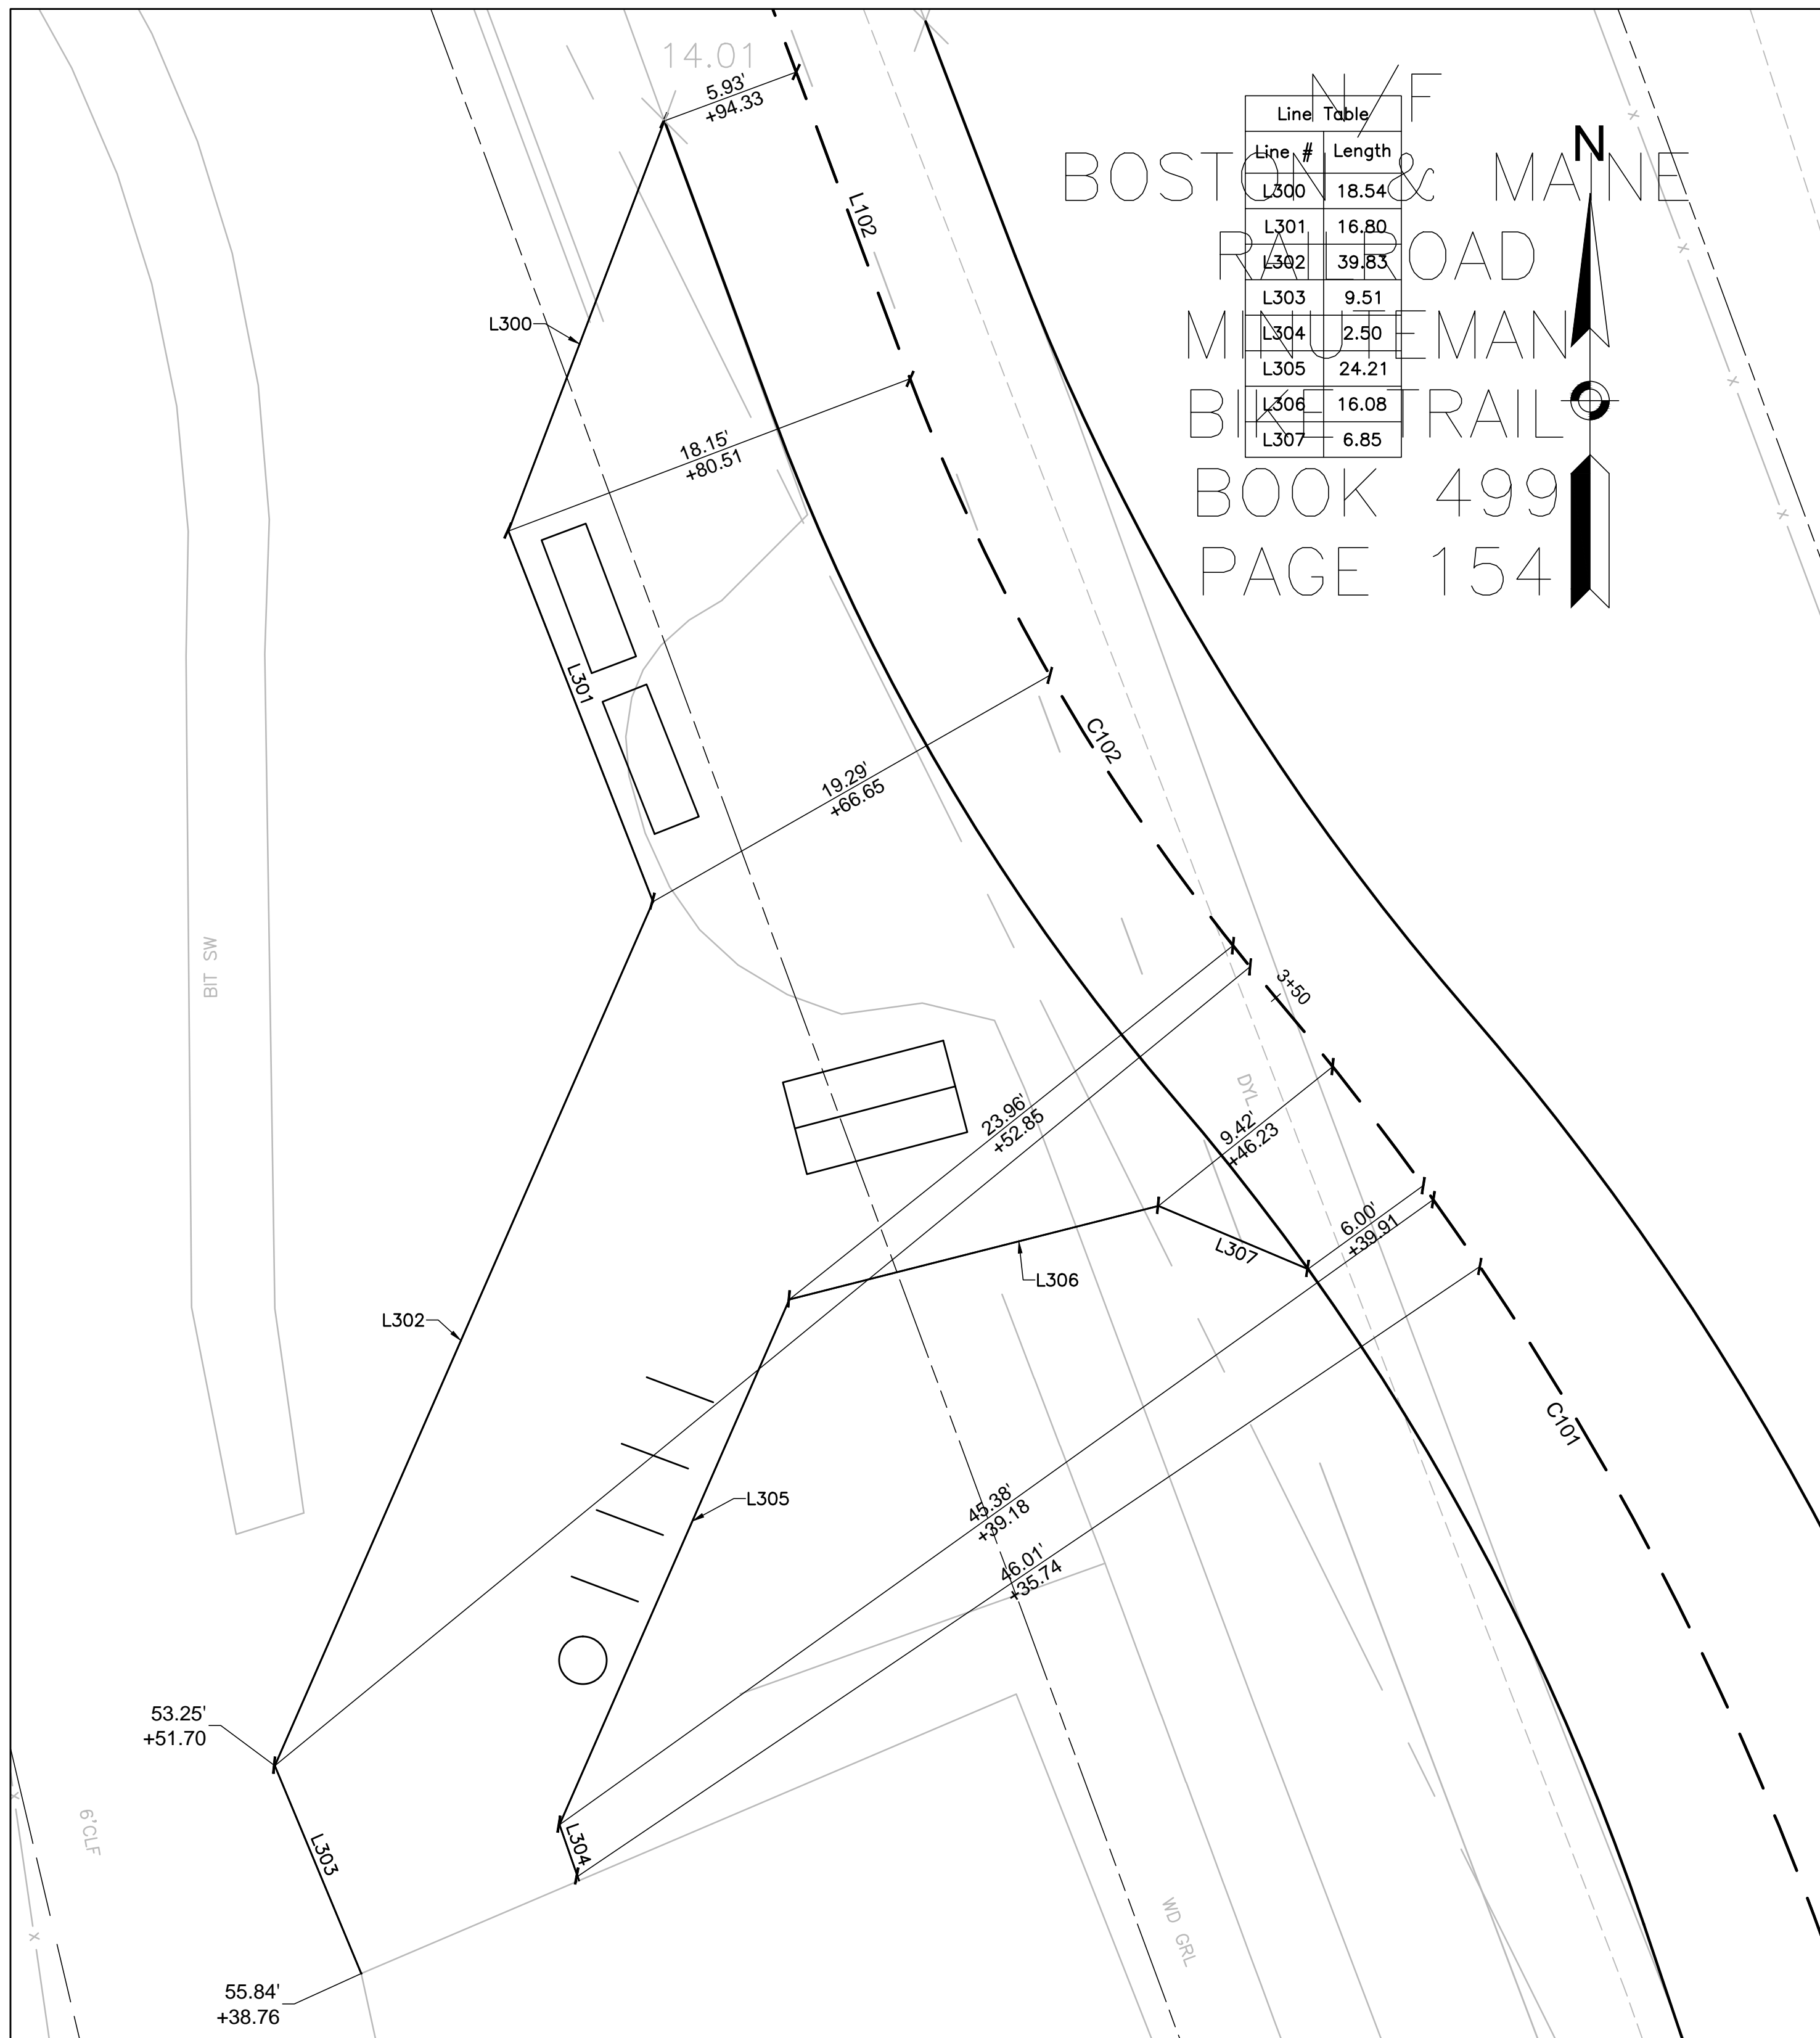

Line #	Length
L300	18.54
L301	16.80
L302	39.83
L303	9.51
L304	2.50
L305	24.21
L306	16.08
L307	6.85

PLAZA LAYOUT PLAN 1

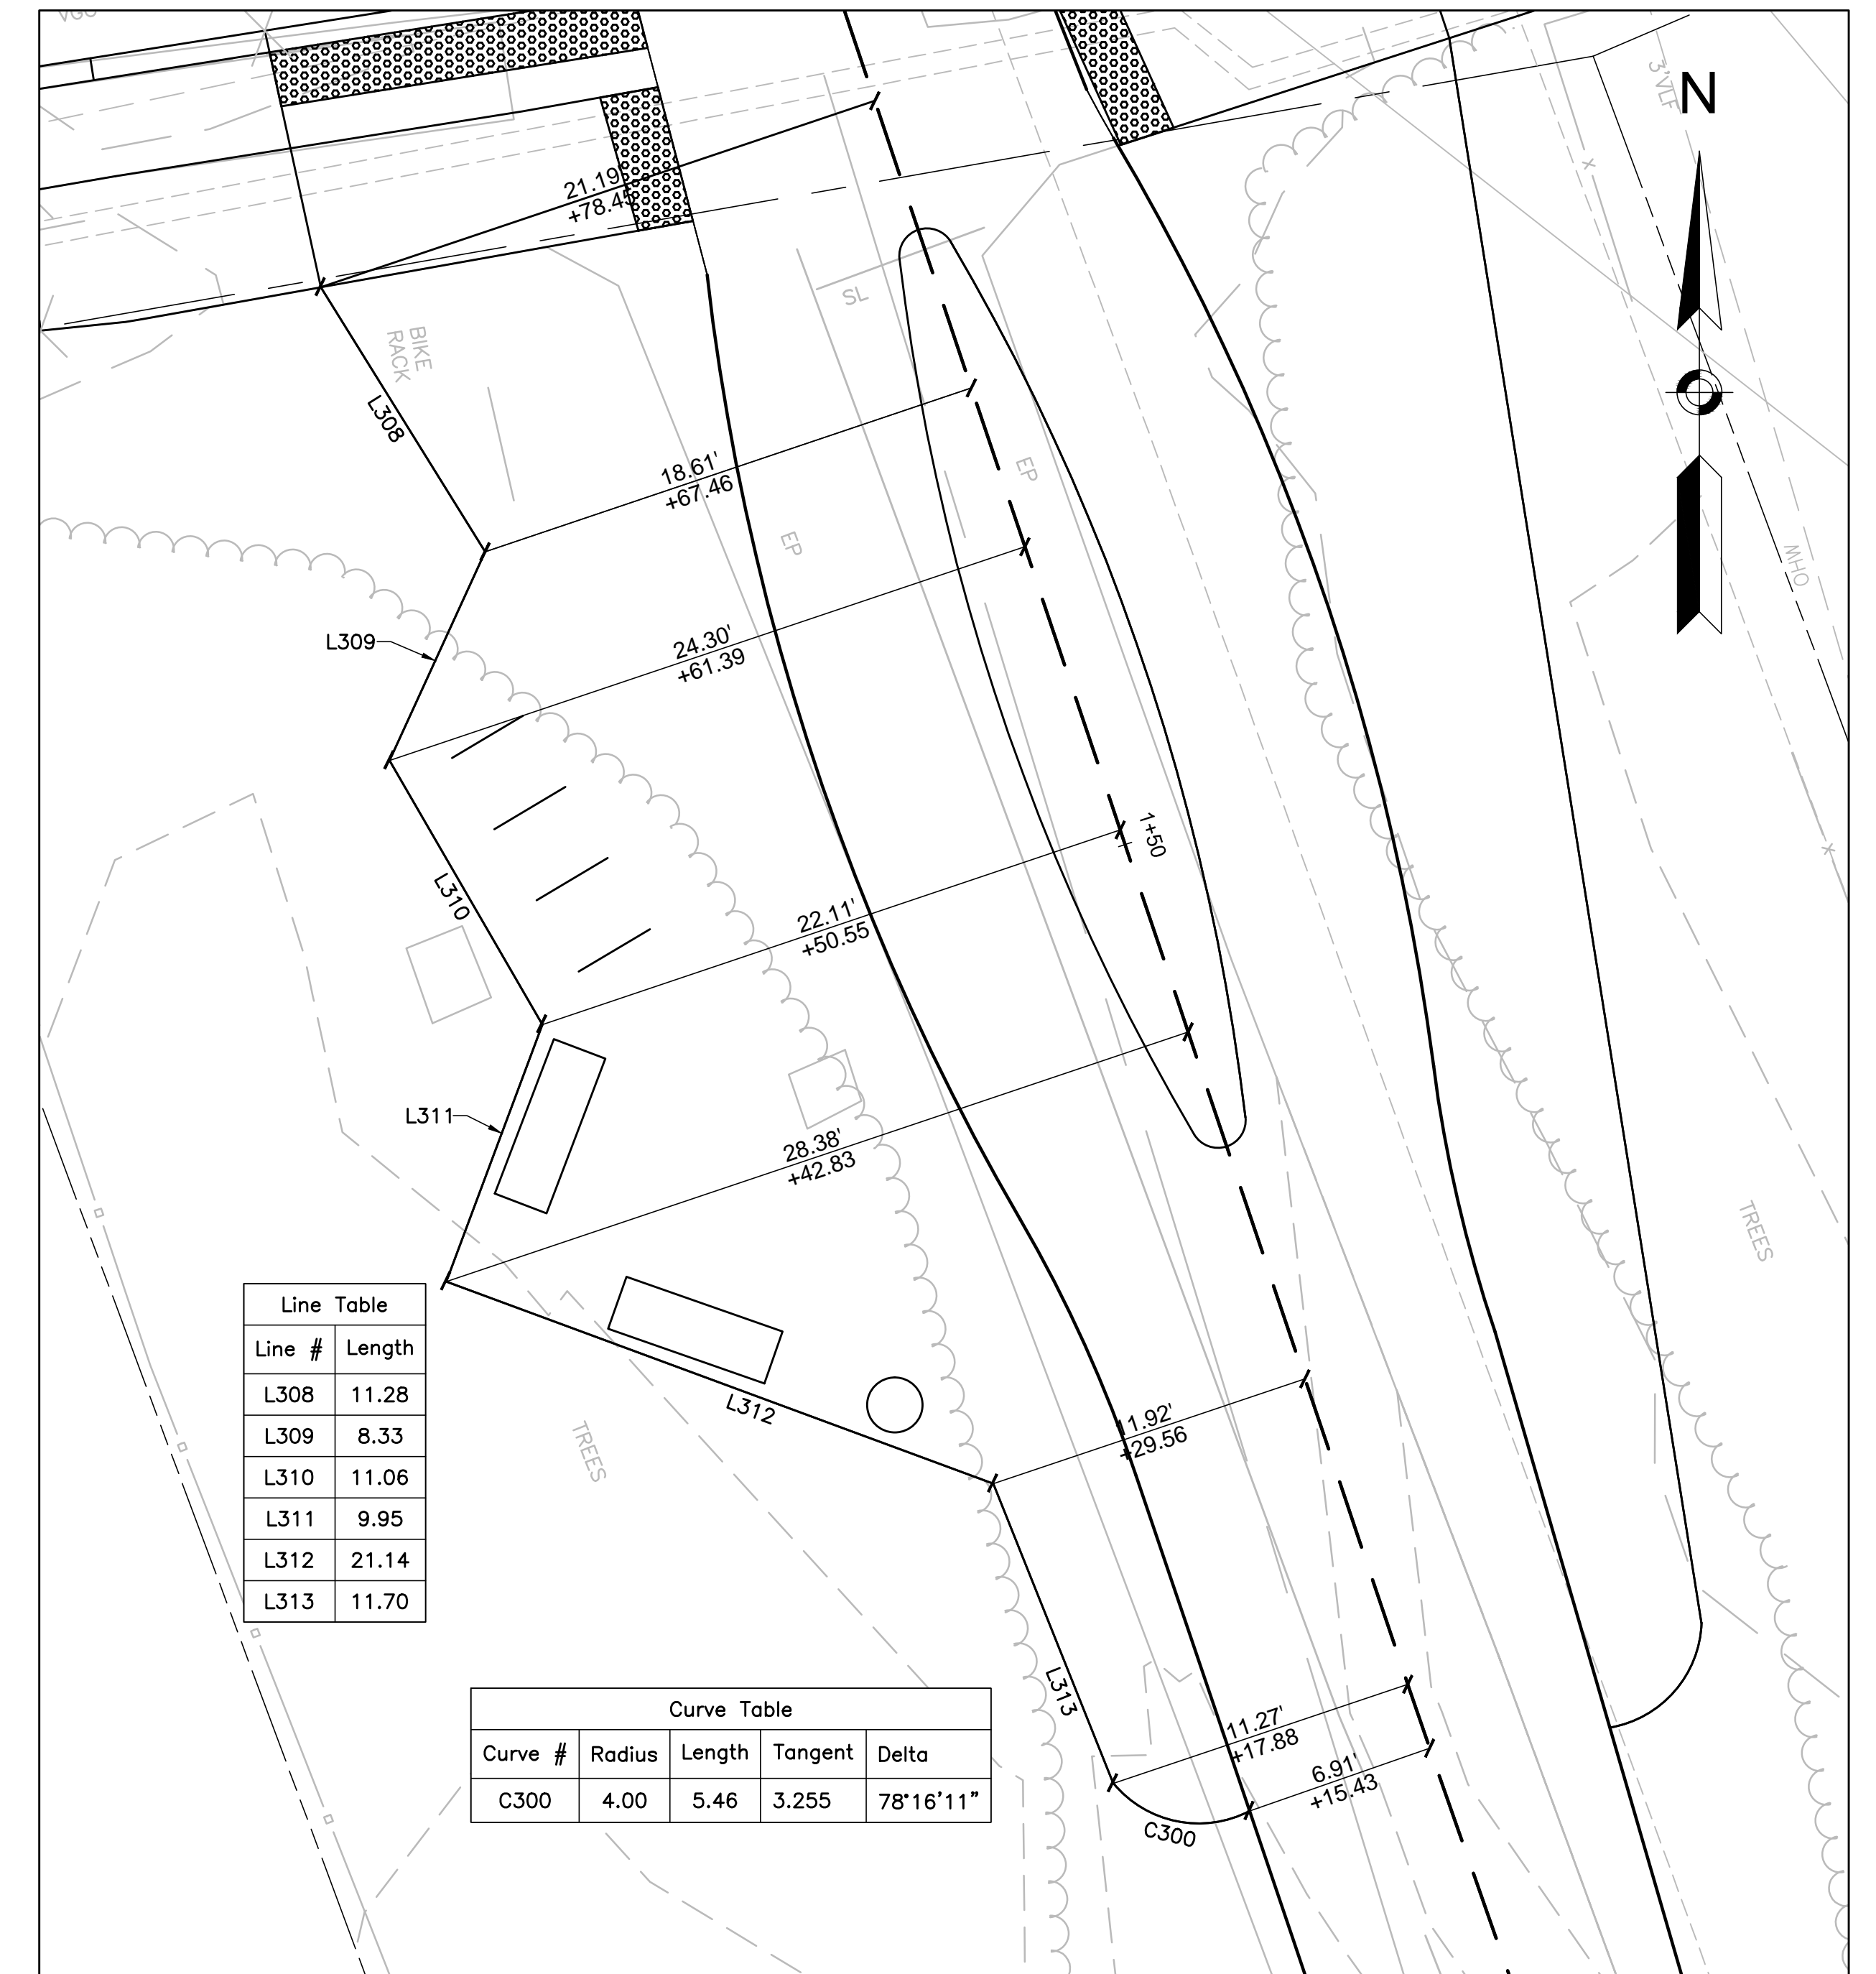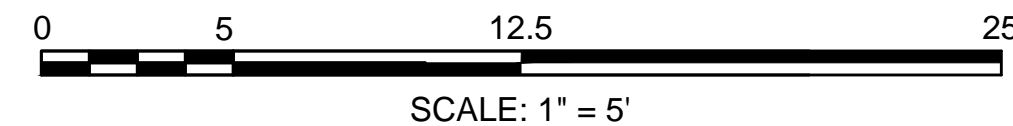

Line #	Length
L308	11.28
L309	8.33
L310	11.06
L311	9.95
L312	21.14
L313	11.70

Curve #	Radius	Length	Tangent	Delta
C300	4.00	5.46	3.255	78°16'11"

PLAZA LAYOUT PLAN 2



PROJECT: **MINUTEMAN BIKEWAY IMPROVEMENTS AT LAKE STREET**

DESIGN SUBMISSION: **DRAFT FINAL DESIGN**

DRAWING TITLE: **PLAZA LAYOUT PLAN**

PREPARED FOR:
 **TOWN OF ARLINGTON**
 ENGINEERING DIVISION
 51 GROVE STREET
 ARLINGTON, MA 02476



PREPARED BY:
 **GREEN INTERNATIONAL AFFILIATES, INC.**
 Civil and Structural Engineers
 Westford, Massachusetts
 (978) 923-0400
 GreenIntl.com

SCALE: AS NOTED	DESIGNED BY: JG	SHEET NO. 07 OF 26
DATE: 09/15/2017	DRAWN BY: JG	
PROJECT NO. 17067.015	CHECKED BY: JS	

LIGHTING DESIGN SERVICES
 LUMEN STUDIO, INC.
 ELECTRICAL WIRING DESIGN SERVICES
 ENGINEERING ADVANTAGE, INC.

NO.	DATE	REVISIONS

P:\Projects\2017\CONCURRENT_DOCUMENTS\BOSTON & MAINE RAILROAD\BOSTON & MAINE RAILROAD\MINUTEMAN BIKEWAY\PLAZA LAYOUT PLAN 2.dwg, Printed: 09/15/2017 2:38 PM

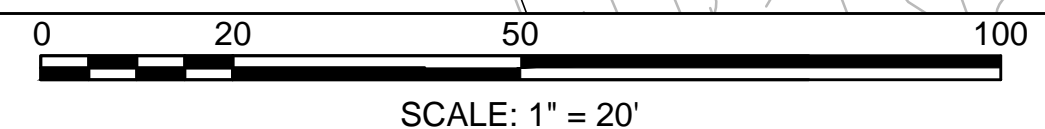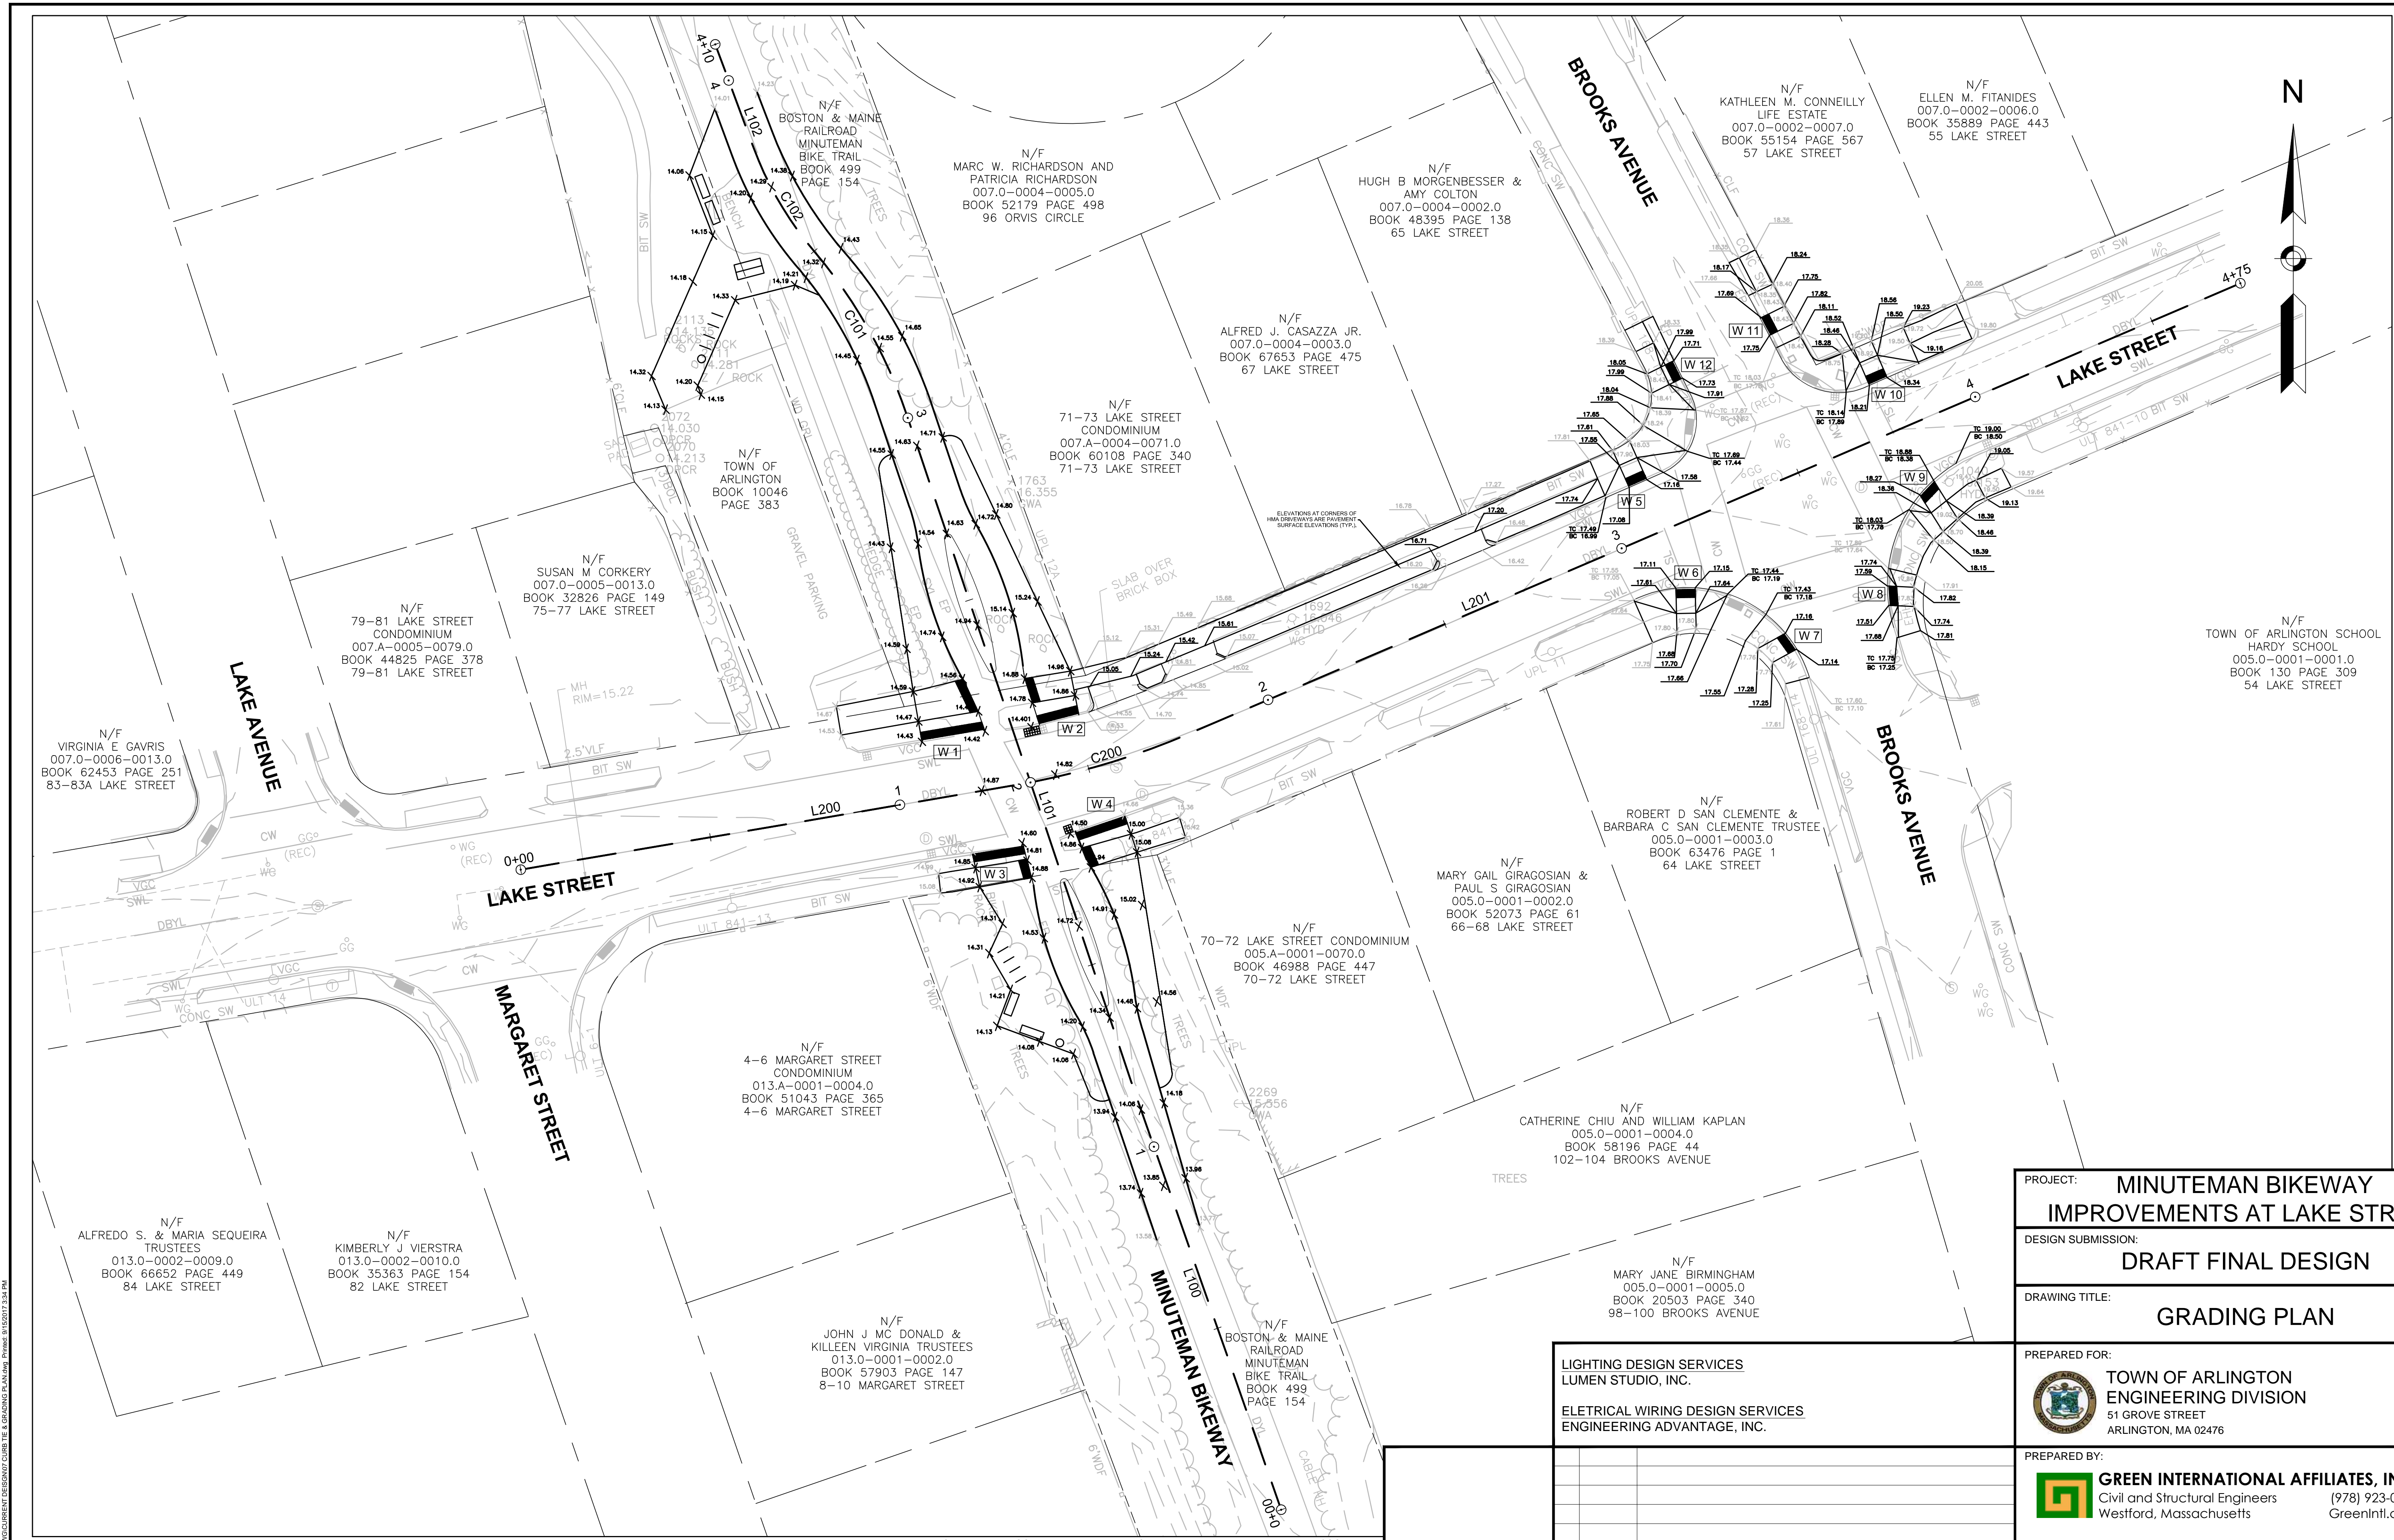


PROJECT: MINUTEMAN BIKEWAY IMPROVEMENTS AT LAKE STREET	
DESIGN SUBMISSION: DRAFT FINAL DESIGN	
DRAWING TITLE: GRADING PLAN	
PREPARED FOR:  TOWN OF ARLINGTON ENGINEERING DIVISION 51 GROVE STREET ARLINGTON, MA 02476	
PREPARED BY:  GREEN INTERNATIONAL AFFILIATES, INC. Civil and Structural Engineers (978) 923-0400 Westford, Massachusetts GreenIntl.com	
SCALE: AS NOTED	DESIGNED BY: JG
DATE: 09/15/2017	DRAWN BY: JG
PROJECT NO. 17067.015	CHECKED BY: JS
SHEET NO. 08 OF 26	

LIGHTING DESIGN SERVICES
LUMEN STUDIO, INC.

ELECTRICAL WIRING DESIGN SERVICES
ENGINEERING ADVANTAGE, INC.

NO.	DATE	REVISIONS

17067.015.DWG CONCURRENT DESIGN COURTESY OF L. GRADIANO CONSULTING ENGINEERS, INC.

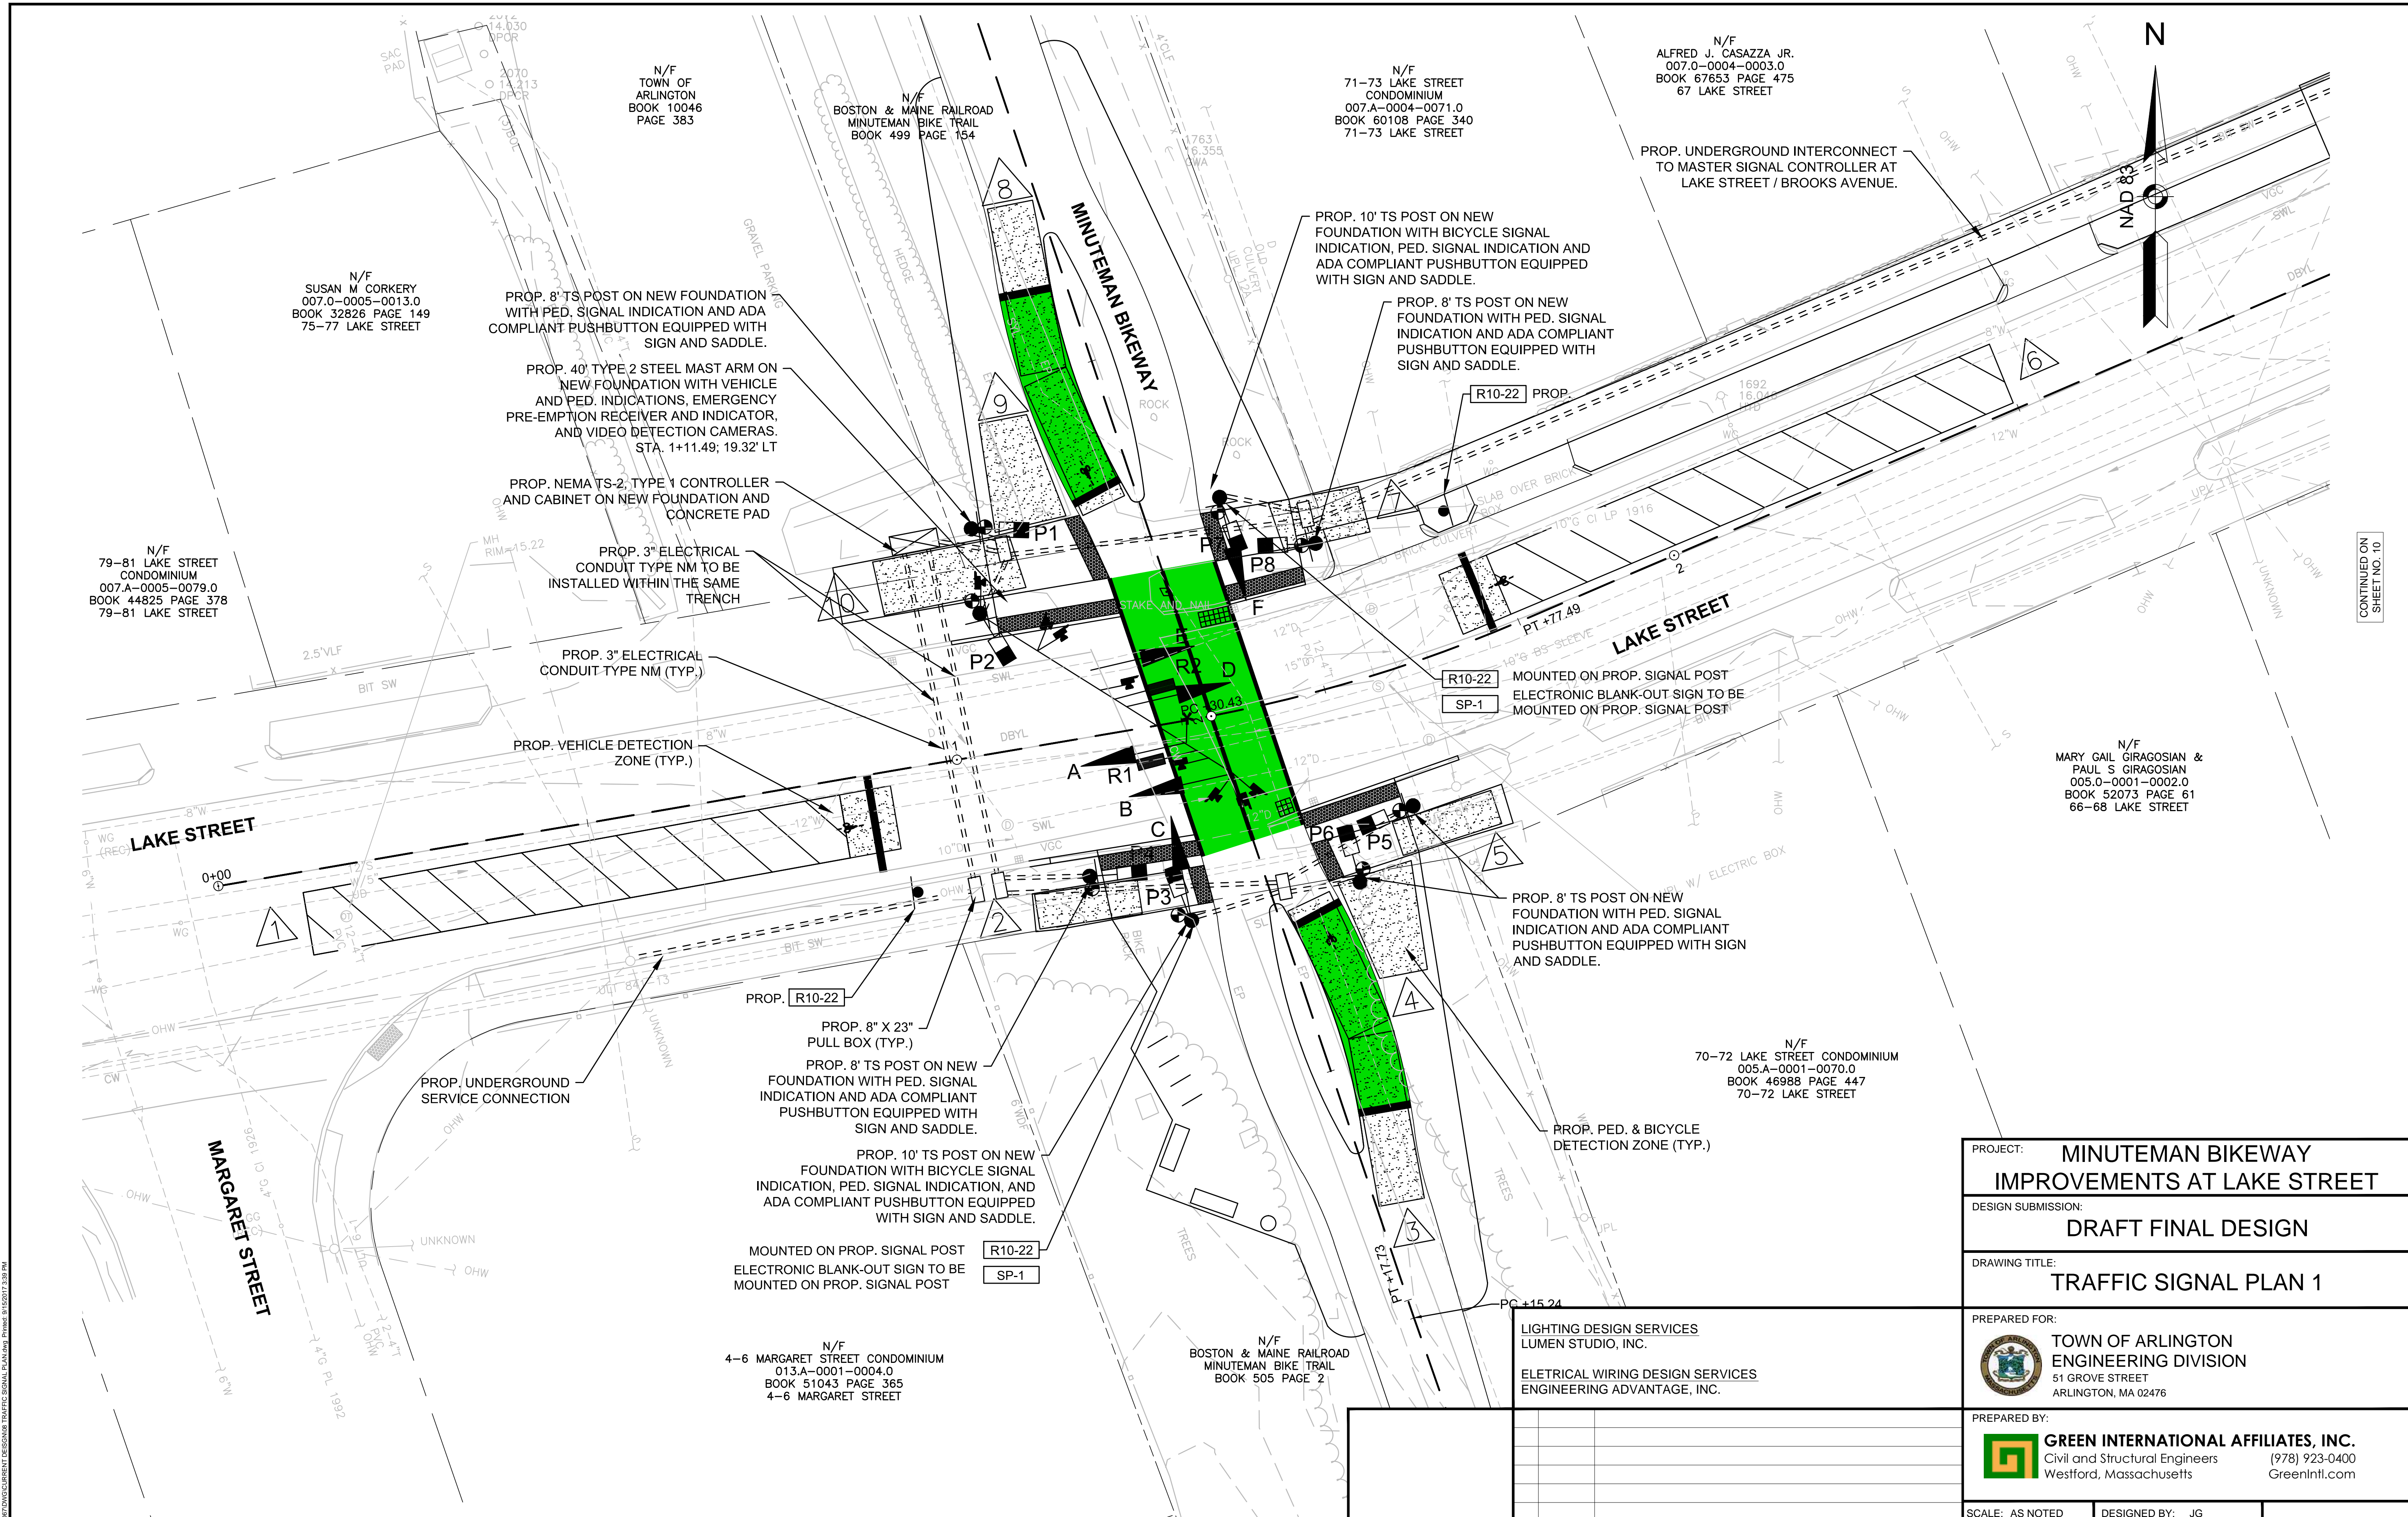

N/F
SUSAN M CORKERY
007.0-0005-0013.0
BOOK 32826 PAGE 149
75-77 LAKE STREET

PROP. 8' TS POST ON NEW FOUNDATION WITH PED. SIGNAL INDICATION AND ADA COMPLIANT PUSHBUTTON EQUIPPED WITH SIGN AND SADDLE.

PROP. 40' TYPE 2 STEEL MAST ARM ON NEW FOUNDATION WITH VEHICLE AND PED. INDICATIONS, EMERGENCY PRE-EMPTION RECEIVER AND INDICATOR, AND VIDEO DETECTION CAMERAS. STA. 1+11.49; 19.32' LT

PROP. NEMA TS-2, TYPE 1 CONTROLLER AND CABINET ON NEW FOUNDATION AND CONCRETE PAD

PROP. 3" ELECTRICAL CONDUIT TYPE NM TO BE INSTALLED WITHIN THE SAME TRENCH

PROP. 3" ELECTRICAL CONDUIT-TYPE NM (TYP.)

PROP. VEHICLE DETECTION ZONE (TYP.)

PROP. R10-22
PROP. 8" X 23" PULL BOX (TYP.)

PROP. 8' TS POST ON NEW FOUNDATION WITH PED. SIGNAL INDICATION AND ADA COMPLIANT PUSHBUTTON EQUIPPED WITH SIGN AND SADDLE.

PROP. 10' TS POST ON NEW FOUNDATION WITH BICYCLE SIGNAL INDICATION, PED. SIGNAL INDICATION, AND ADA COMPLIANT PUSHBUTTON EQUIPPED WITH SIGN AND SADDLE.

MOUNTED ON PROP. SIGNAL POST
ELECTRONIC BLANK-OUT SIGN TO BE MOUNTED ON PROP. SIGNAL POST

N/F
4-6 MARGARET STREET CONDOMINIUM
013.A-0001-0004.0
BOOK 51043 PAGE 365
4-6 MARGARET STREET

N/F
BOSTON & MAINE RAILROAD
MINUTEMAN BIKE TRAIL
BOOK 505 PAGE 2

N/F
71-73 LAKE STREET CONDOMINIUM
007.A-0004-0071.0
BOOK 60108 PAGE 340
71-73 LAKE STREET

PROP. 10' TS POST ON NEW FOUNDATION WITH BICYCLE SIGNAL INDICATION, PED. SIGNAL INDICATION AND ADA COMPLIANT PUSHBUTTON EQUIPPED WITH SIGN AND SADDLE.

PROP. 8' TS POST ON NEW FOUNDATION WITH PED. SIGNAL INDICATION AND ADA COMPLIANT PUSHBUTTON EQUIPPED WITH SIGN AND SADDLE.

R10-22 PROP.

R10-22 MOUNTED ON PROP. SIGNAL POST
ELECTRONIC BLANK-OUT SIGN TO BE MOUNTED ON PROP. SIGNAL POST

SP-1

PROP. 8' TS POST ON NEW FOUNDATION WITH PED. SIGNAL INDICATION AND ADA COMPLIANT PUSHBUTTON EQUIPPED WITH SIGN AND SADDLE.

PROP. PED. & BICYCLE DETECTION ZONE (TYP.)

N/F
70-72 LAKE STREET CONDOMINIUM
005.A-0001-0070.0
BOOK 46988 PAGE 447
70-72 LAKE STREET

PROP. UNDERGROUND INTERCONNECT TO MASTER SIGNAL CONTROLLER AT LAKE STREET / BROOKS AVENUE.

PROJECT: **MINUTEMAN BIKEWAY IMPROVEMENTS AT LAKE STREET**

DESIGN SUBMISSION: **DRAFT FINAL DESIGN**

DRAWING TITLE: **TRAFFIC SIGNAL PLAN 1**

PREPARED FOR:
TOWN OF ARLINGTON ENGINEERING DIVISION
51 GROVE STREET
ARLINGTON, MA 02476


PREPARED BY:
GREEN INTERNATIONAL AFFILIATES, INC.
Civil and Structural Engineers
Westford, Massachusetts
(978) 923-0400
GreenIntl.com

SCALE: AS NOTED
DATE: 09/15/2017
PROJECT NO. 17067.015

DESIGNED BY: JG
DRAWN BY: JG
CHECKED BY: JS

SHEET NO. **09** OF **26**

NOTE: SEE SHEET 17 FOR ALL PAVEMENT MARKINGS AND SIGNING.

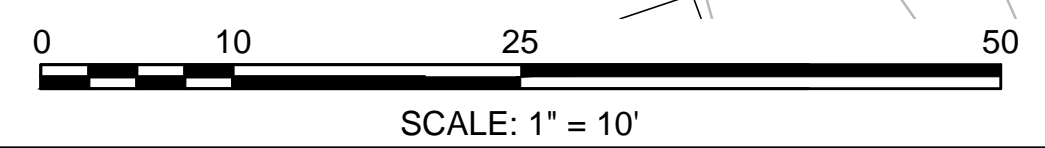



LIGHTING DESIGN SERVICES
LUMEN STUDIO, INC.

ELECTRICAL WIRING DESIGN SERVICES
ENGINEERING ADVANTAGE, INC.

NO. DATE REVISIONS

CONTINUED ON SHEET NO. 10

P:\Projects\2017\CONCURRENT DESIGN\TRAFFIC SIGNAL PLAN.dwg, Printed: 04/05/2017 2:39 PM

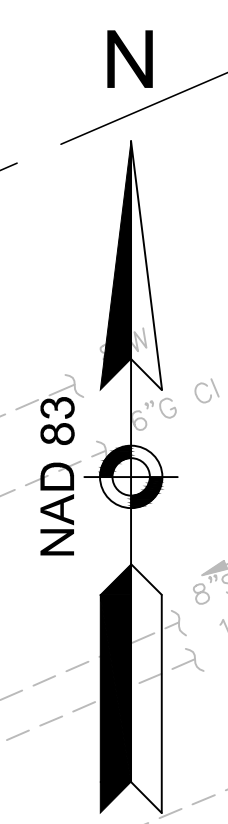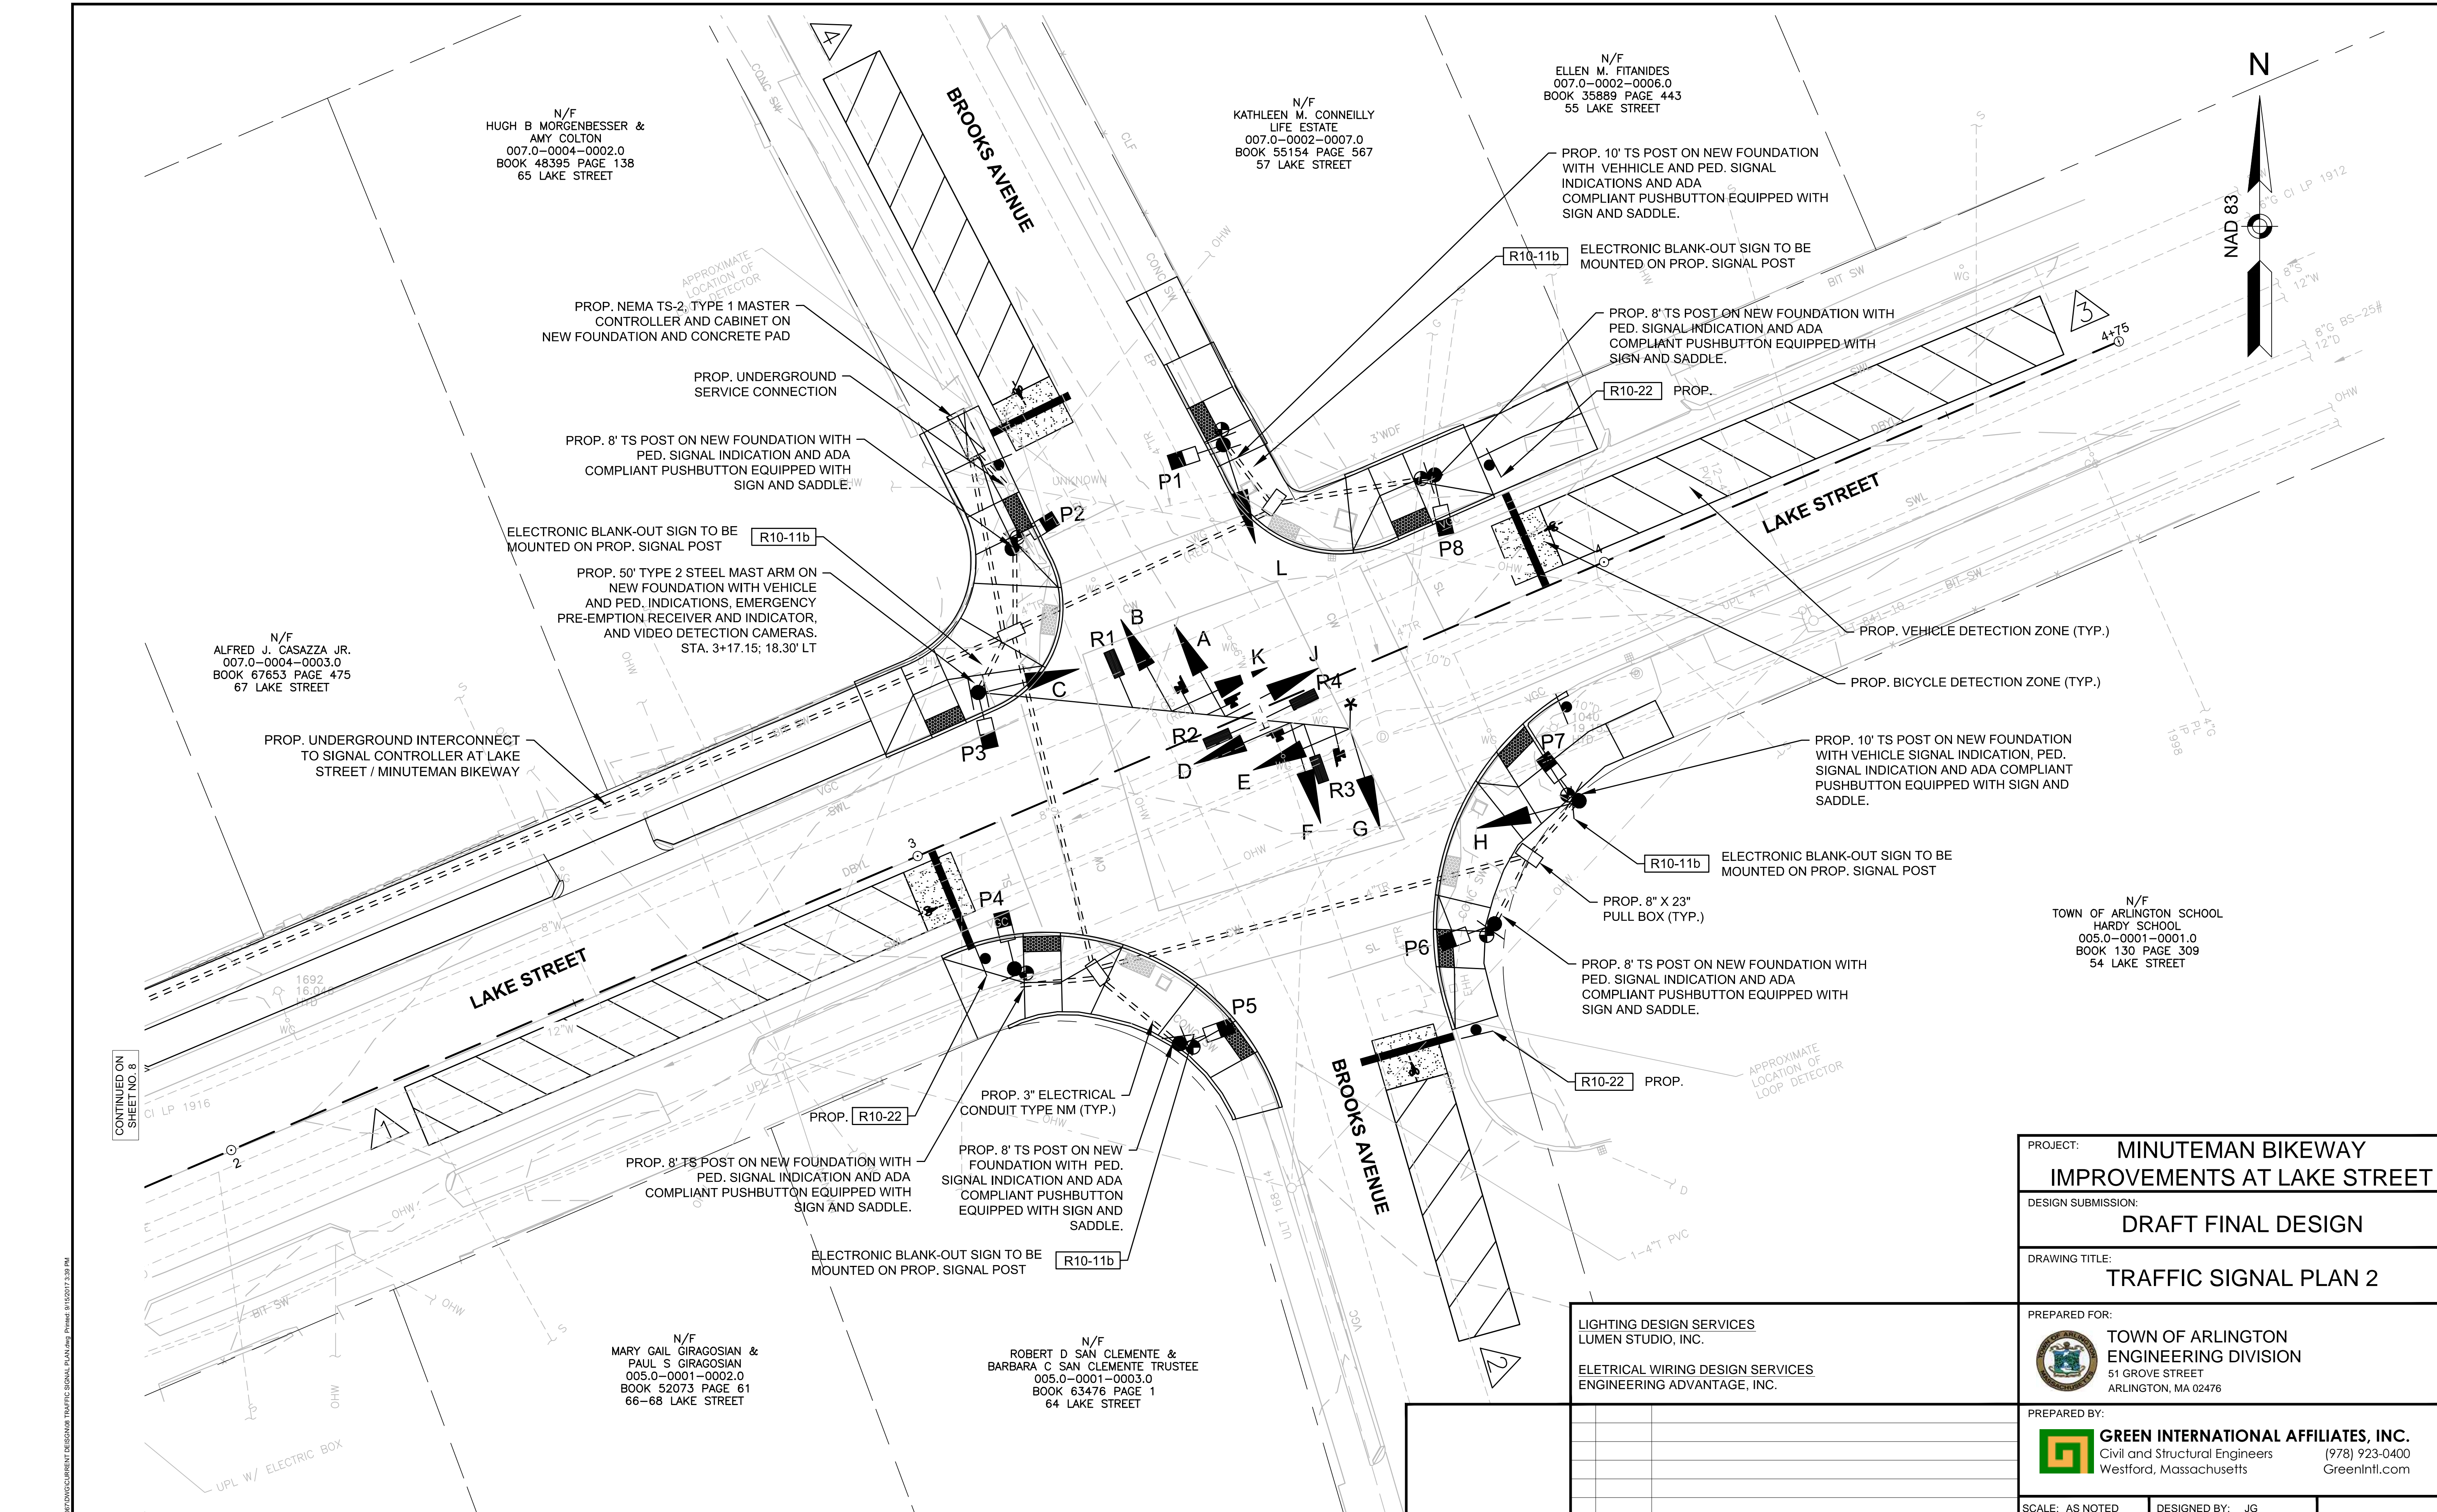

N/F
HUGH B MORGENBESSER &
AMY COLTON
007.0-0004-0002.0
BOOK 48395 PAGE 138
65 LAKE STREET

N/F
KATHLEEN M. CONNELLY
LIFE ESTATE
007.0-0002-0007.0
BOOK 55154 PAGE 567
57 LAKE STREET

N/F
ELLEN M. FITANIDES
007.0-0002-0006.0
BOOK 35889 PAGE 443
55 LAKE STREET

N/F
ALFRED J. CASAZZA JR.
007.0-0004-0003.0
BOOK 67653 PAGE 475
67 LAKE STREET


N/F
TOWN OF ARLINGTON SCHOOL
HARDY SCHOOL
005.0-0001-0001.0
BOOK 130 PAGE 309
54 LAKE STREET

N/F
MARY GAIL GIRAGOSIAN &
PAUL S. GIRAGOSIAN
005.0-0001-0002.0
BOOK 52073 PAGE 61
66-68 LAKE STREET

N/F
ROBERT D SAN CLEMENTE &
BARBARA C SAN CLEMENTE TRUSTEE
005.0-0001-0003.0
BOOK 63476 PAGE 1
64 LAKE STREET

CONTINUED ON SHEET NO. 8

NOTE: SEE SHEET 16 FOR ALL PAVEMENT MARKINGS AND SIGNING.

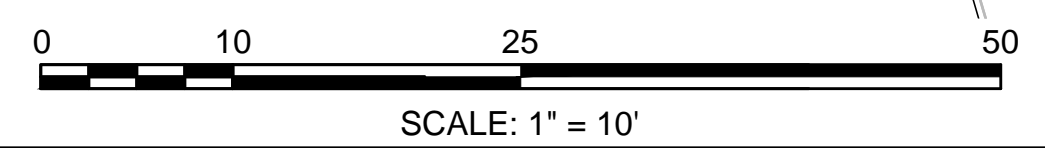

PROJECT:	MINUTEMAN BIKEWAY IMPROVEMENTS AT LAKE STREET
DESIGN SUBMISSION:	DRAFT FINAL DESIGN
DRAWING TITLE:	TRAFFIC SIGNAL PLAN 2

PREPARED FOR:	 TOWN OF ARLINGTON ENGINEERING DIVISION 51 GROVE STREET ARLINGTON, MA 02476
---------------	--

PREPARED BY:	 GREEN INTERNATIONAL AFFILIATES, INC. Civil and Structural Engineers Westford, Massachusetts (978) 923-0400 GreenIntl.com
--------------	---

LIGHTING DESIGN SERVICES
LUMEN STUDIO, INC.

ELETRICAL WIRING DESIGN SERVICES
ENGINEERING ADVANTAGE, INC.


SCALE: AS NOTED	DESIGNED BY: JG	SHEET NO. 10 OF 26
DATE: 09/15/2017	DRAWN BY: JG	
PROJECT NO. 17067.015	CHECKED BY: JS	

NO.	DATE	REVISIONS

LOCATION 1														FLASHING OPERATION		
SEQUENCE & TIMING FOR FULL ACTUATED CONTROL (COORDINATED) LAKE STREET AT MINUTEMAN BIKEWAY																
APPROX. NORTH																
INTERVALS																
APPROACH	DIRECTION	HOUSINGS	1	2	3	4	5	6	7	8	9	10	11	12		
LAKE STREET	EB	A,B	G	Y	R	R	R	R	R	R	R	R	R	R	FY	
LAKE STREET	WB	D,E	R	R	R	R	R	R	R	G	Y	R	R	R	FY	
MINUTEMAN BIKEWAY	NB	C	R	R	R	G	Y	R	R	R	R	R	R	R	FR	
MINUTEMAN BIKEWAY	SB	F	R	R	R	R	R	R	R	R	R	G	Y	R	FR	
PEDESTRIAN	EB-WB	P1,P4,P5,P8	W	FDW	DW	DW	DW	DW	DW	W	FDW	DW	DW	DW	OFF	
PEDESTRIAN	NB-SB	P2,P3,P6,P7	DW	DW	DW	W	FDW	DW	DW	DW	W	FDW	DW	DW	OFF	
TIMING IN SECONDS														EMERGENCY ONLY		
MINIMUM GREEN (INITIAL)			5			11.5			5			11.5				
MAX GREEN 1			42.5			13.5			42.5			13.5				
VEHICLE EXTENSION			3			3			3			3				
YELLOW CLEARANCE				3.5			3.5			3.5			3.5			
RED CLEARANCE					1			6			1				6	
PED WALK INTERVAL			7	3	3	7	11	3	7	3	3	7	11		3	
PED CLEARANCE INTERVAL																
RECALL				SOFT			NONE			SOFT			NONE			
DETECTION (MEMORY)				NON-LOCK			NON-LOCK			NON-LOCK			NON-LOCK			
COORDINATION DATA			COORDINATION PHASE TIMING (SEC.)													
TIMING PLAN	CYCLE LENGTH (SEC.)	REF/OFFSET (SEC.)	ø 2		ø 4		ø 6		ø 8							
COORDINATION PLAN 1 M-F (6AM-9AM)	70	16	47		23		47		23							
COORDINATION PLAN 2 M-F (3PM-7PM)	70	4	47		23		47		23							


- NOTES:**
- STANDARD NEMA CLEARANCES SHALL APPLY.
 - SIGNAL SHALL OPERATE UNDER "COORDINATED" MODE DURING THE TIMES NOTED ABOVE. THE SIGNAL SHALL OPERATE IN "FREE" MODE DURING ALL OTHER TIMES.

LAKE STREET AT MINUTEMAN BIKEWAY MAJOR ITEMS LIST	
1	SERVICE CONNECTION (UNDERGROUND)
1	CONTROLLER NEMA 8 PHASE TS-2 (TYPE-1), CAB. & FDN
1	40 FT TYPE II, GALV. STEEL MAST ARM ASSEMBLY, BASE & FDN
5	SIGNAL POLE AND BASE STANDARD, 8 FT. W / FOUNDATION
2	SIGNAL POLE AND BASE STANDARD, 10 FT. W / FOUNDATION
4	12 INCH 1 WAY 3-SECTION LED VEHICLE SIGNAL INDICATION
2	12 INCH 1 WAY 3-SECTION LED BICYCLE SIGNAL INDICATION
8	16 INCH LED PEDESTRIAN INDICATION WITH COUNTDOWN
8	PED. PUSH BUTTON W/ SIGN AND SADDLE (ADA COMPLIANT)
1	VEHICLE VIDEO DETECTION SYSTEM
2	VIDEO DETECTION CAMERA
4	PEDESTRIAN VIDEO DETECTION CAMERA
2	BICYCLE VIDEO DETECTION CAMERA
5	8" X 23" PULLBOX
1	PRE-EMPTION PHASE SELECTOR MODULE FOUR-CHANNEL
1	PRE-EMPTION CARD RACK
1	PRE-EMPTION INDICATOR (STROBE) LIGHT
2	PRE-EMPTION RECEIVER (DETECTOR) ONE-WAY
ALL CABLE, LABOR, MISCELLANEOUS MATERIALS AND EQUIPMENT NECESSARY TO COMPLETE THE INSTALLATION OF A FULLY OPERATIONAL SIGNAL SYSTEM AS INTENDED ON TRAFFIC SIGNAL PLAN (SHEET 09).	

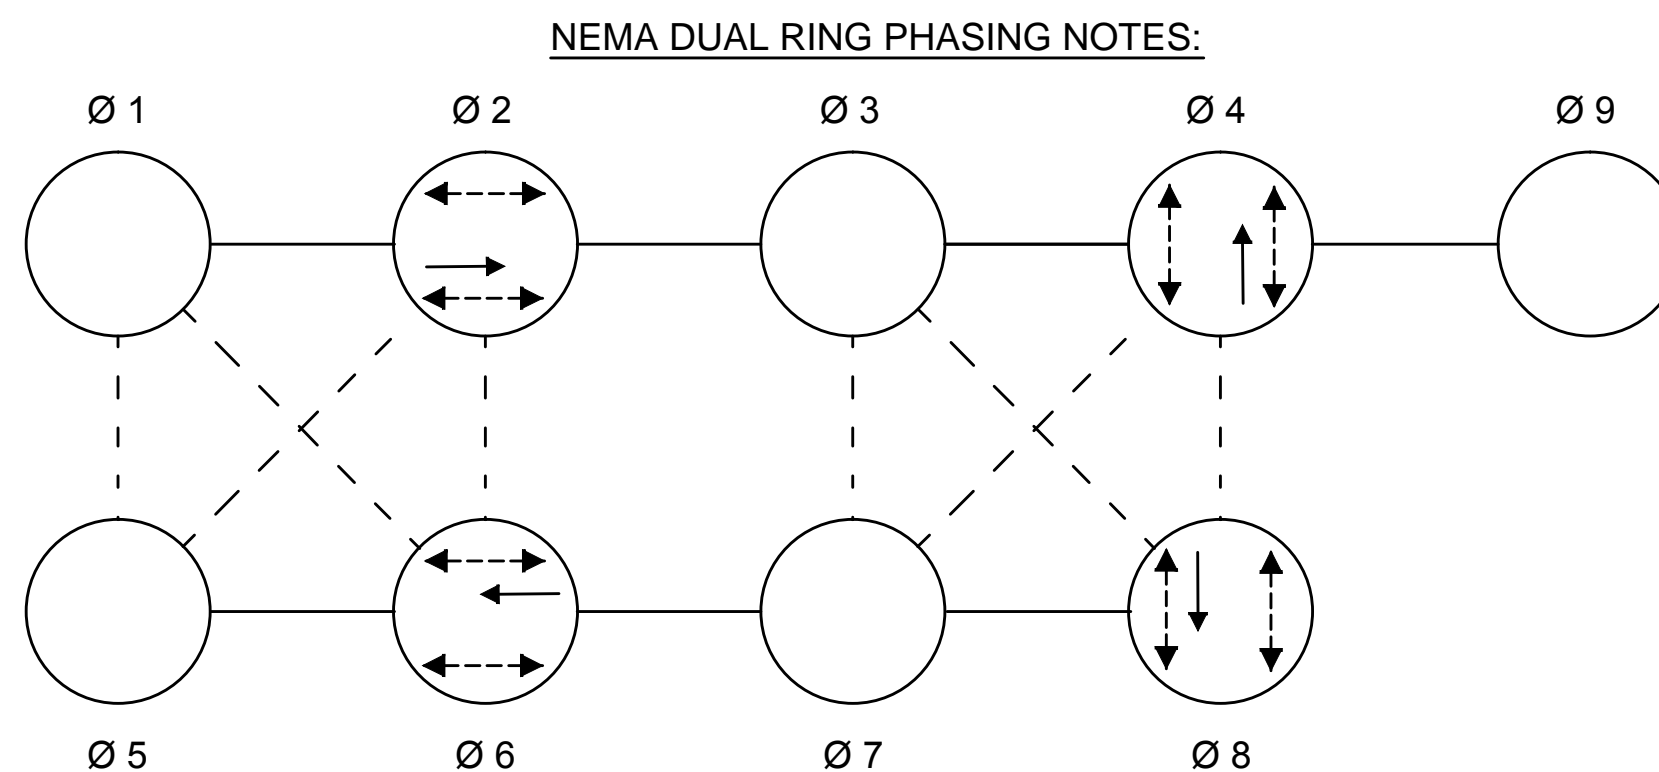


- NOTES:**
- PHASES ASSOCIATED BY A SOLID LINE SHALL NOT OPERATE CONCURRENTLY.
 - PHASES ASSOCIATED BY A DASHED LINE MAY OPERATE CONCURRENTLY.
 - THROUGH MOVEMENTS MAY INCLUDE RIGHT TURNS. IF THE ASSIGNED RIGHT OF WAY FOR ANY TRAFFIC MOVEMENT IS TO REMAIN IN EFFECT DURING THE NEXT CALLED PHASE, THE SIGNAL INDICATIONS FOR THAT TRAFFIC MOVEMENT SHALL NOT CHANGE DURING THE CHANGE INTERVAL(S) UNLESS OTHERWISE NOTED.

VIDEO DETECTION DATA					
DETECTOR NO.	PHASE CALLED	PHASE EXT.	OPERATIONS	DELAY TIME	EXT. TIME
1	ø2	ø2	PRESENCE	-	-
2	ø2	ø2	PRESENCE	-	-
3	ø4	ø4	PRESENCE	-	-
4	ø4	ø4	PRESENCE	-	-
5	ø6	ø6	PRESENCE	-	-
6	ø6	ø6	PRESENCE	-	-
7	ø6	ø6	PRESENCE	-	-
8	ø8	ø8	PRESENCE	-	-
9	ø8	ø8	PRESENCE	-	-
10	ø2	ø2	PRESENCE	-	-

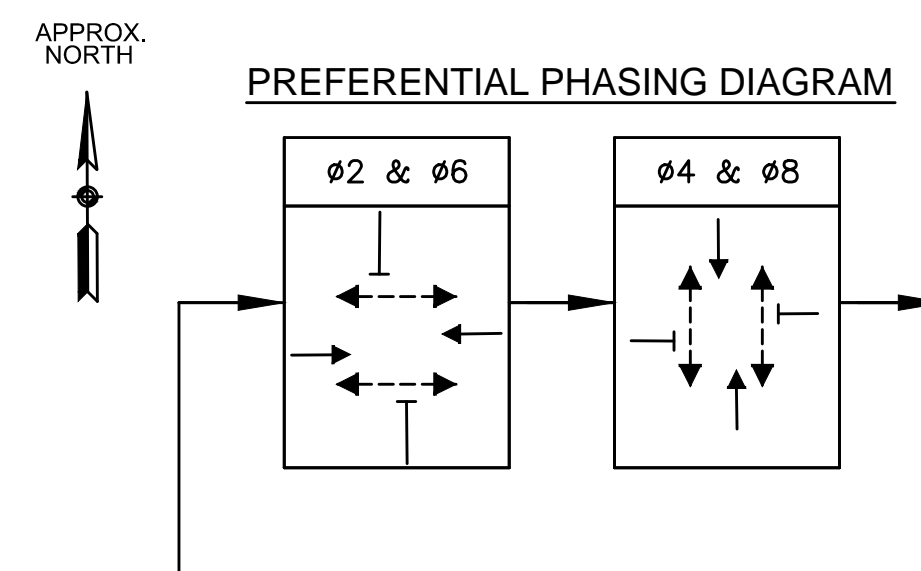

SIGNAL IDENTIFICATION

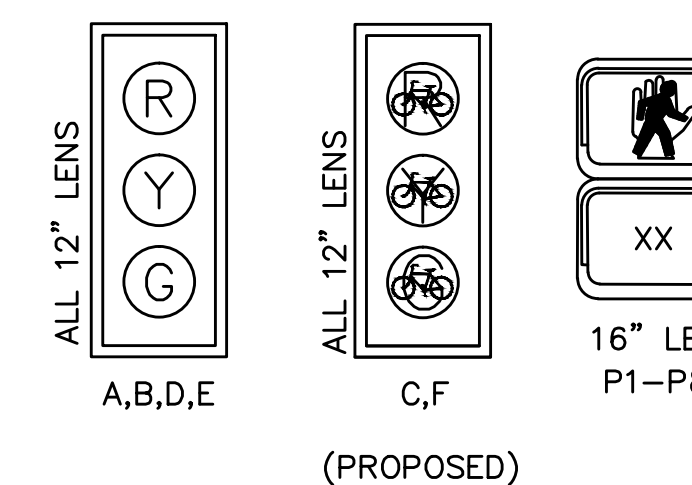

- NOTES:**
- ALL VEHICLE AND BICYCLE LENSES SHALL BE LED TYPE.
 - ALL VEHICLE AND BICYCLE SIGNAL HEADS SHALL BE 12 INCHES.
 - ALL HOUSINGS TO BE PROVIDED WITH TUNNEL VISORS AND 5-INCH NON-LOUVERED BACKPLATES WITH 3-INCH RETROREFLECTIVE BORDER.
 - ALL HOUSINGS TO BE FIXED MOUNTED.
 - ALL SIGNALHEAD BACKPLATES SHALL BE NON-LOUVERED.
 - SIGNAL HEADS D & E SHALL HAVE DISTANCE-LIMITING LOUVERS TO LIMIT THEIR VISIBILITY TO WITHIN 160 FT. UPSTREAM OF THE PROPOSED STOP LINE.


PROJECT:	MINUTEMAN BIKEWAY IMPROVEMENTS AT LAKE STREET
DESIGN SUBMISSION:	DRAFT FINAL DESIGN
DRAWING TITLE:	SEQUENCE AND TIMING PLAN 1

LIGHTING DESIGN SERVICES LUMEN STUDIO, INC. ELECTRICAL WIRING DESIGN SERVICES ENGINEERING ADVANTAGE, INC.	PREPARED FOR: TOWN OF ARLINGTON ENGINEERING DIVISION 51 GROVE STREET ARLINGTON, MA 02476
	PREPARED BY: GREEN INTERNATIONAL AFFILIATES, INC. Civil and Structural Engineers (978) 923-0400 Westford, Massachusetts GreenIntl.com
SCALE: AS NOTED DATE: 09/15/2017 PROJECT NO. 17067.015	DESIGNED BY: JG DRAWN BY: JG CHECKED BY: JS
NO. DATE REVISIONS	SHEET NO. 11 OF 26

LOCATION 2			SEQUENCE & TIMING FOR FULL ACTUATED CONTROL (COORDINATED) LAKE STREET AT BROOKS AVENUE																		
			Ø 2			Ø 4			Ø 6			Ø 7			Ø 8			Ø 9			FLASHING OPERATION
			INTERVALS																		
APPROACH	DIRECTION	HOUSINGS	1	2	3	4	5	6	7	8	9	10	11	12	13	14	15	16	17	18	
LAKE STREET	EB	D,E,H	G	Y	R	R	R	R	R	R	R	R	R	R	R	R	R	R	R	R	FY
LAKE STREET	WB	C,J,K	R	R	R	R	R	R	R	G	Y	R	R	R	R	R	R	R	R	R	FY
BROOKS AVENUE	NB	F	R	R	R	FY	SY	R	R	R	R	G	Y	R	R	R	R	R	R	R	FR
BROOKS AVENUE	NB	G,L	R	R	R	G	Y	R	R	R	R	G	Y	R	R	R	R	R	R	R	FR
BROOKS AVENUE	SB	A,B	R	R	R	R	R	R	R	R	R	G	Y	R	R	G	Y	R	R	R	FR
PEDESTRIAN	ALL	P1-P8	DW	DW	DW	DW	DW	DW	DW	DW	DW	DW	DW	DW	DW	DW	DW	W	FDW	DW	OUT
			TIMING IN SECONDS																		
MINIMUM GREEN (INITIAL)			5			5			5			5			5						
MAX GREEN 1			22.5			18.5			22.5			5.5			8.5						
MAX GREEN 2			31.5			9.5			31.5			-			9.5						
VEHICLE EXTENSION			3			3			3			3			3						
YELLOW CLEARANCE				3.5			3			3.5			3			3					
RED CLEARANCE					1			1.5			1			1.5			1.5				
PED WALK INTERVAL																		7			
PED CLEARANCE INTERVAL																			10	3	
RECALL					SOFT			NONE			SOFT			NONE			NONE			NONE	
DETECTION (MEMORY)					NON-LOCK			NON-LOCK			NON-LOCK			NON-LOCK			NON-LOCK			LOCK	
COORDINATION DATA			COORDINATION PHASE TIMING (SEC.)																		
TIMING PLAN	CYCLE LENGTH (SEC.)	REF/OFFSET (SEC.)	Ø 2	Ø 4	Ø 6	Ø 7	Ø 8	Ø 9													
COORDINATION PLAN 1 M-F (6AM-9AM)	70	0	27	23	27	10	13	20													
COORDINATION PLAN 2 M-F (3PM-7PM);	70	0	36	14	36	-	14	20													


- NOTES:
- STANDARD NEMA CLEARANCES SHALL APPLY.
 - MAXIMUM GREEN 1 SHALL BE IN EFFECT ON WEEKDAYS FROM 6:00AM TO 9:00AM.
 - MAXIMUM GREEN 2 SHALL BE IN EFFECT DURING ALL TIMES EXCEPT AS NOTED ABOVE.
 - SIGNAL SHALL OPERATE UNDER "COORDINATED MODE" DURING THE TIMES NOTED ABOVE. THE SIGNAL SHALL OPERATE IN "FREE" MODE DURING ALL OTHER TIMES.

NEMA DUAL RING PHASING NOTES:

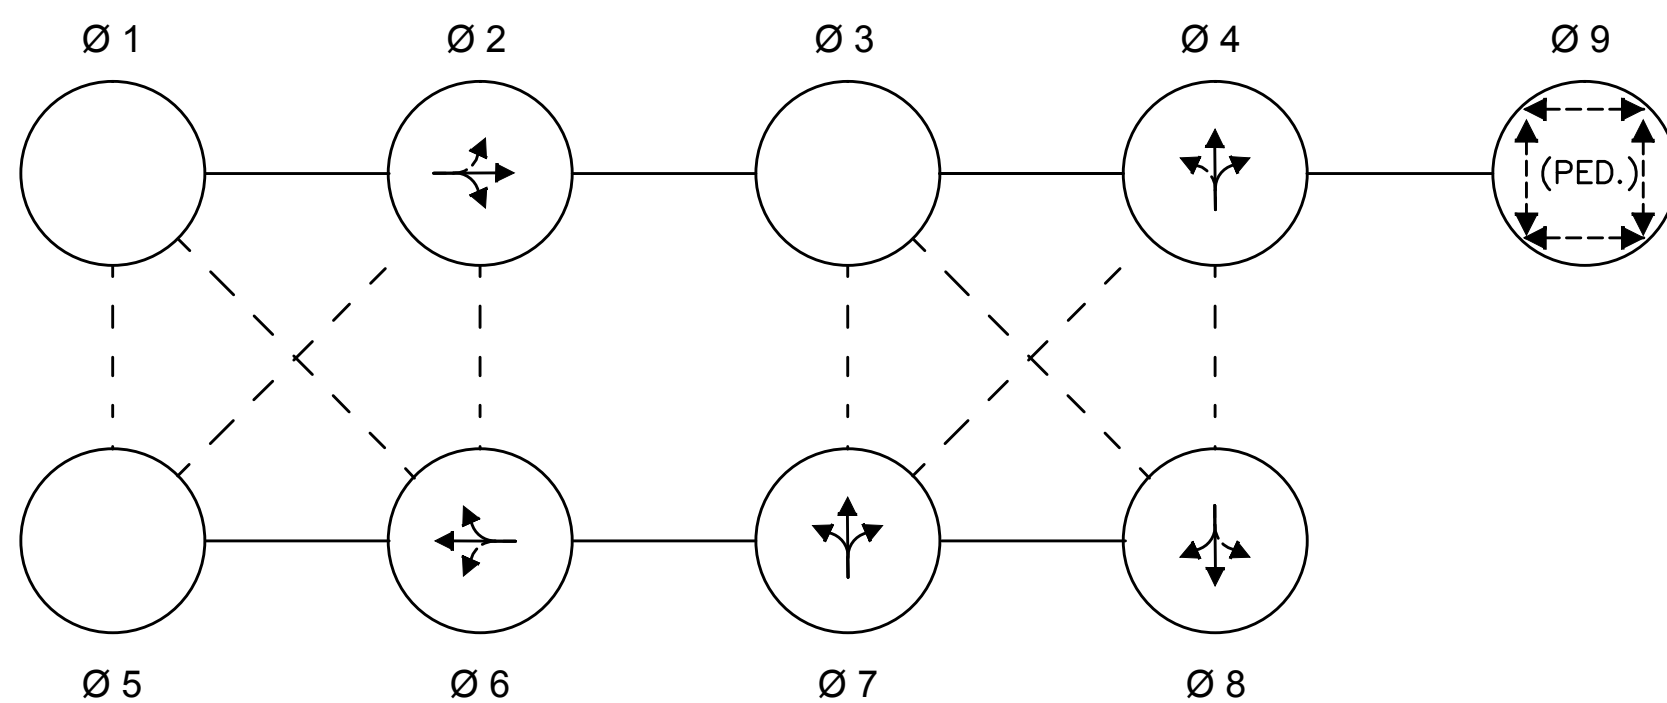

- NOTES:
- PHASES ASSOCIATED BY A SOLID LINE SHALL NOT OPERATE CONCURRENTLY.
 - PHASES ASSOCIATED BY A DASHED LINE MAY OPERATE CONCURRENTLY.
 - THROUGH MOVEMENTS MAY INCLUDE RIGHT TURNS.
 - IF THE ASSIGNED RIGHT OF WAY FOR ANY TRAFFIC MOVEMENT IS TO REMAIN IN EFFECT DURING THE NEXT CALLED PHASE, THE SIGNAL INDICATIONS FOR THAT TRAFFIC MOVEMENT SHALL NOT CHANGE DURING THE CHANGE INTERVAL(S) UNLESS OTHERWISE NOTED.

SIGNAL IDENTIFICATION

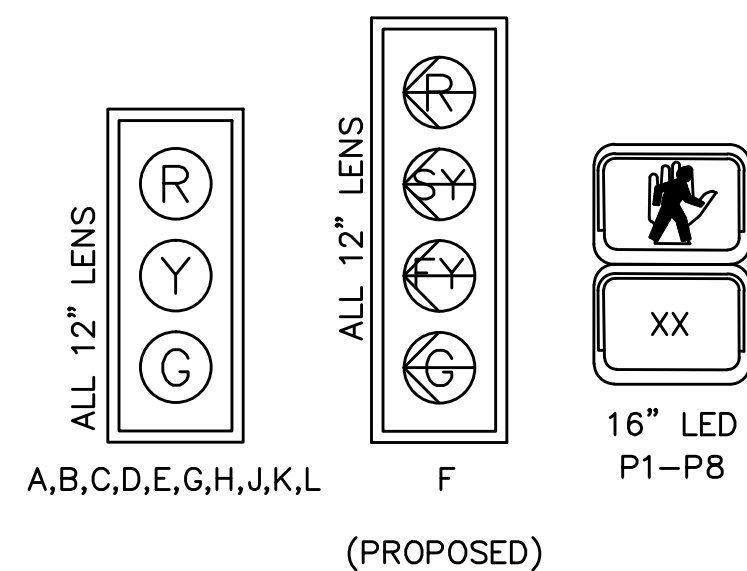

- NOTES:
- ALL VEHICLE AND BICYCLE LENSES SHALL BE LED TYPE.
 - ALL VEHICLE AND BICYCLE SIGNAL HEADS SHALL BE 12 INCHES.
 - ALL HOUSINGS TO BE PROVIDED WITH TUNNEL VISORS AND 5-INCH NON-LOUVERED BACKPLATES WITH 3-INCH RETROREFLECTIVE BORDER.
 - ALL HOUSINGS TO BE FIXED MOUNTED.
 - ALL SIGNALHEAD BACKPLATES SHALL BE NON-LOUVERED.
 - SIGNAL HEADS D & E SHALL HAVE DISTANCE-LIMITING LOUVERS TO LIMIT THEIR VISIBILITY TO WITHIN 160 FT. UPSTREAM OF THE PROPOSED STOP LINE.


VIDEO DETECTION DATA					
DETECTOR NO.	PHASE CALLED	PHASE EXT.	OPERATIONS	DELAY TIME	EXT. TIME
1	Ø 2	Ø 2	PRESENCE	-	-
2	Ø 4	Ø 4	PRESENCE	-	-
3	Ø 6	Ø 6	PRESENCE	-	-
4	Ø 8	Ø 8	PRESENCE	-	-

LAKE STREET AT BROOKS AVENUE MAJOR ITEMS LIST


1	SERVICE CONNECTION (UNDERGROUND)
1	MASTER SIGNAL CONTROLLER NEMA 8 PHASE TS-2 (TYPE-1), CAB. & FDN
1	50 FT TYPE II, GALV. STEEL MAST ARM ASSEMBLY, BASE & FDN
5	SIGNAL POLE AND BASE STANDARD, 8 FT. W / FOUNDATION
2	SIGNAL POLE AND BASE STANDARD, 10 FT. W / FOUNDATION
10	12 INCH 1 WAY 3-SECTION LED VEHICLE SIGNAL INDICATION
1	12 INCH 1 WAY 4-SECTION LED VEHICLE SIGNAL INDICATION (ALL ARROWS)
8	16 INCH LED PEDESTRIAN INDICATION WITH COUNTDOWN
8	PED. PUSH BUTTON W/ SIGN AND SADDLE (ADA COMPLIANT)
1	VIDEO DETECTION SYSTEM
4	VIDEO DETECTION CAMERA
4	8" X 23" PULLBOX
1	PRE-EMPTION PHASE SELECTOR MODULE FOUR-CHANNEL
1	PRE-EMPTION CARD RACK
1	PRE-EMPTION INDICATOR (STROBE) LIGHT
4	PRE-EMPTION RECEIVER (DETECTOR) ONE-WAY

ALL CABLE, LABOR, MISCELLANEOUS MATERIALS AND EQUIPMENT NECESSARY TO COMPLETE THE INSTALLATION OF A FULLY OPERATIONAL SIGNAL SYSTEM AS INTENDED ON TRAFFIC SIGNAL PLAN (SHEET 10).

PREFERENTIAL PHASING SEQUENCE - MAX GREEN 1

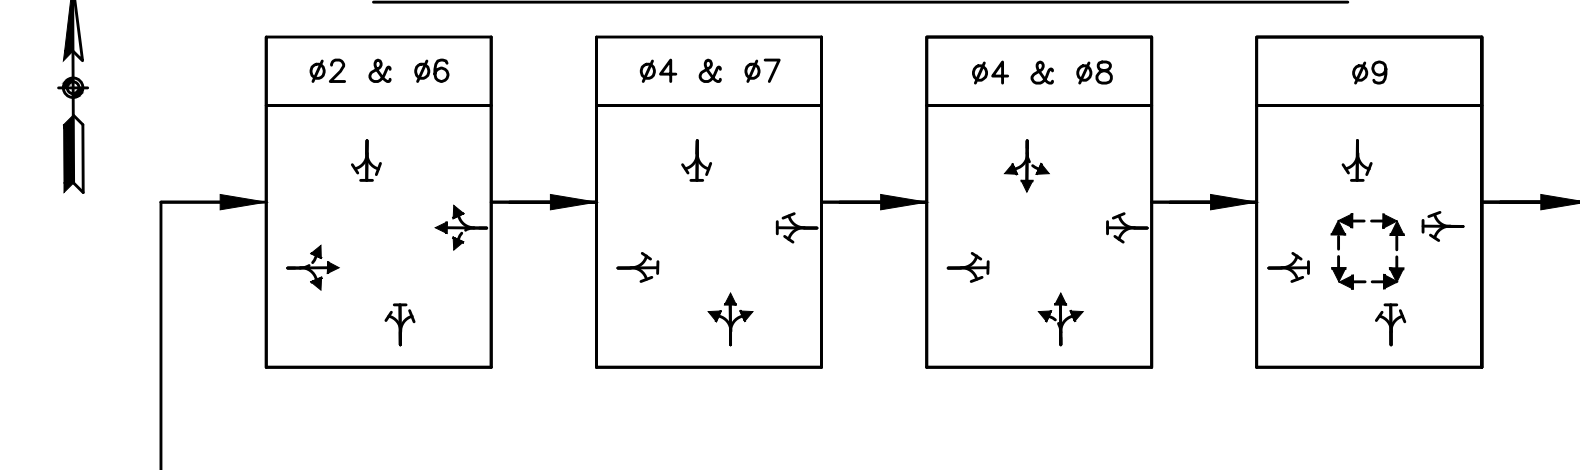

PREFERENTIAL PHASING SEQUENCE - MAX GREEN 2

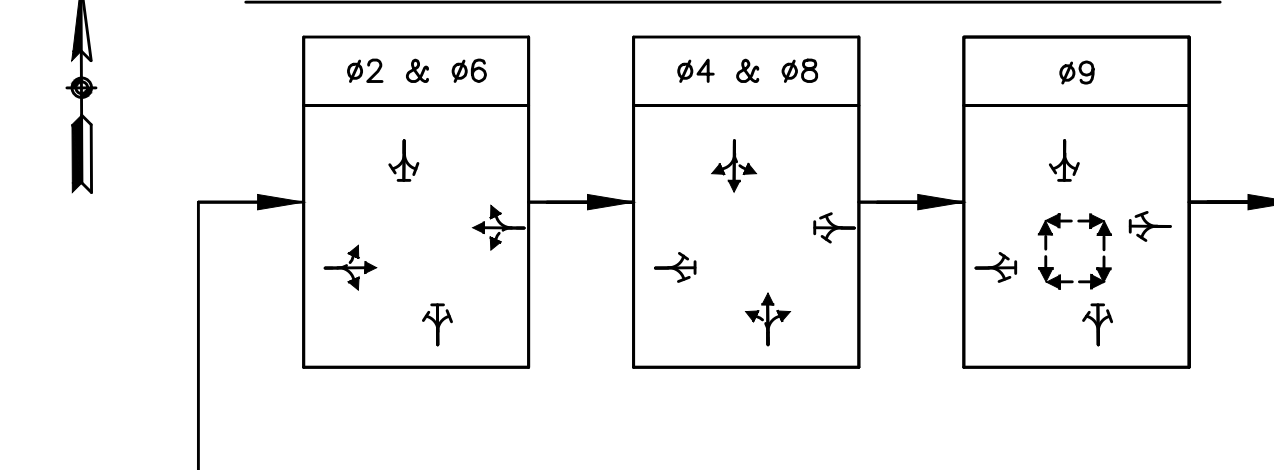

LIGHTING DESIGN SERVICES
LUMEN STUDIO, INC.
ELECTRICAL WIRING DESIGN SERVICES
ENGINEERING ADVANTAGE, INC.

PROJECT: MINUTEMAN BIKEWAY IMPROVEMENTS AT LAKE STREET

DESIGN SUBMISSION: DRAFT FINAL DESIGN

DRAWING TITLE: SEQUENCE AND TIMING PLAN 2

PREPARED FOR: TOWN OF ARLINGTON ENGINEERING DIVISION
51 GROVE STREET
ARLINGTON, MA 02476

PREPARED BY: GREEN INTERNATIONAL AFFILIATES, INC.
Civil and Structural Engineers
Westford, Massachusetts (978) 923-0400
GreenIntl.com


SCALE: AS NOTED DESIGNED BY: JG

DATE: 09/15/2017 DRAWN BY: JG

PROJECT NO. 17067.015 CHECKED BY: JS

SHEET NO. 12 OF 26

NO. DATE REVISIONS

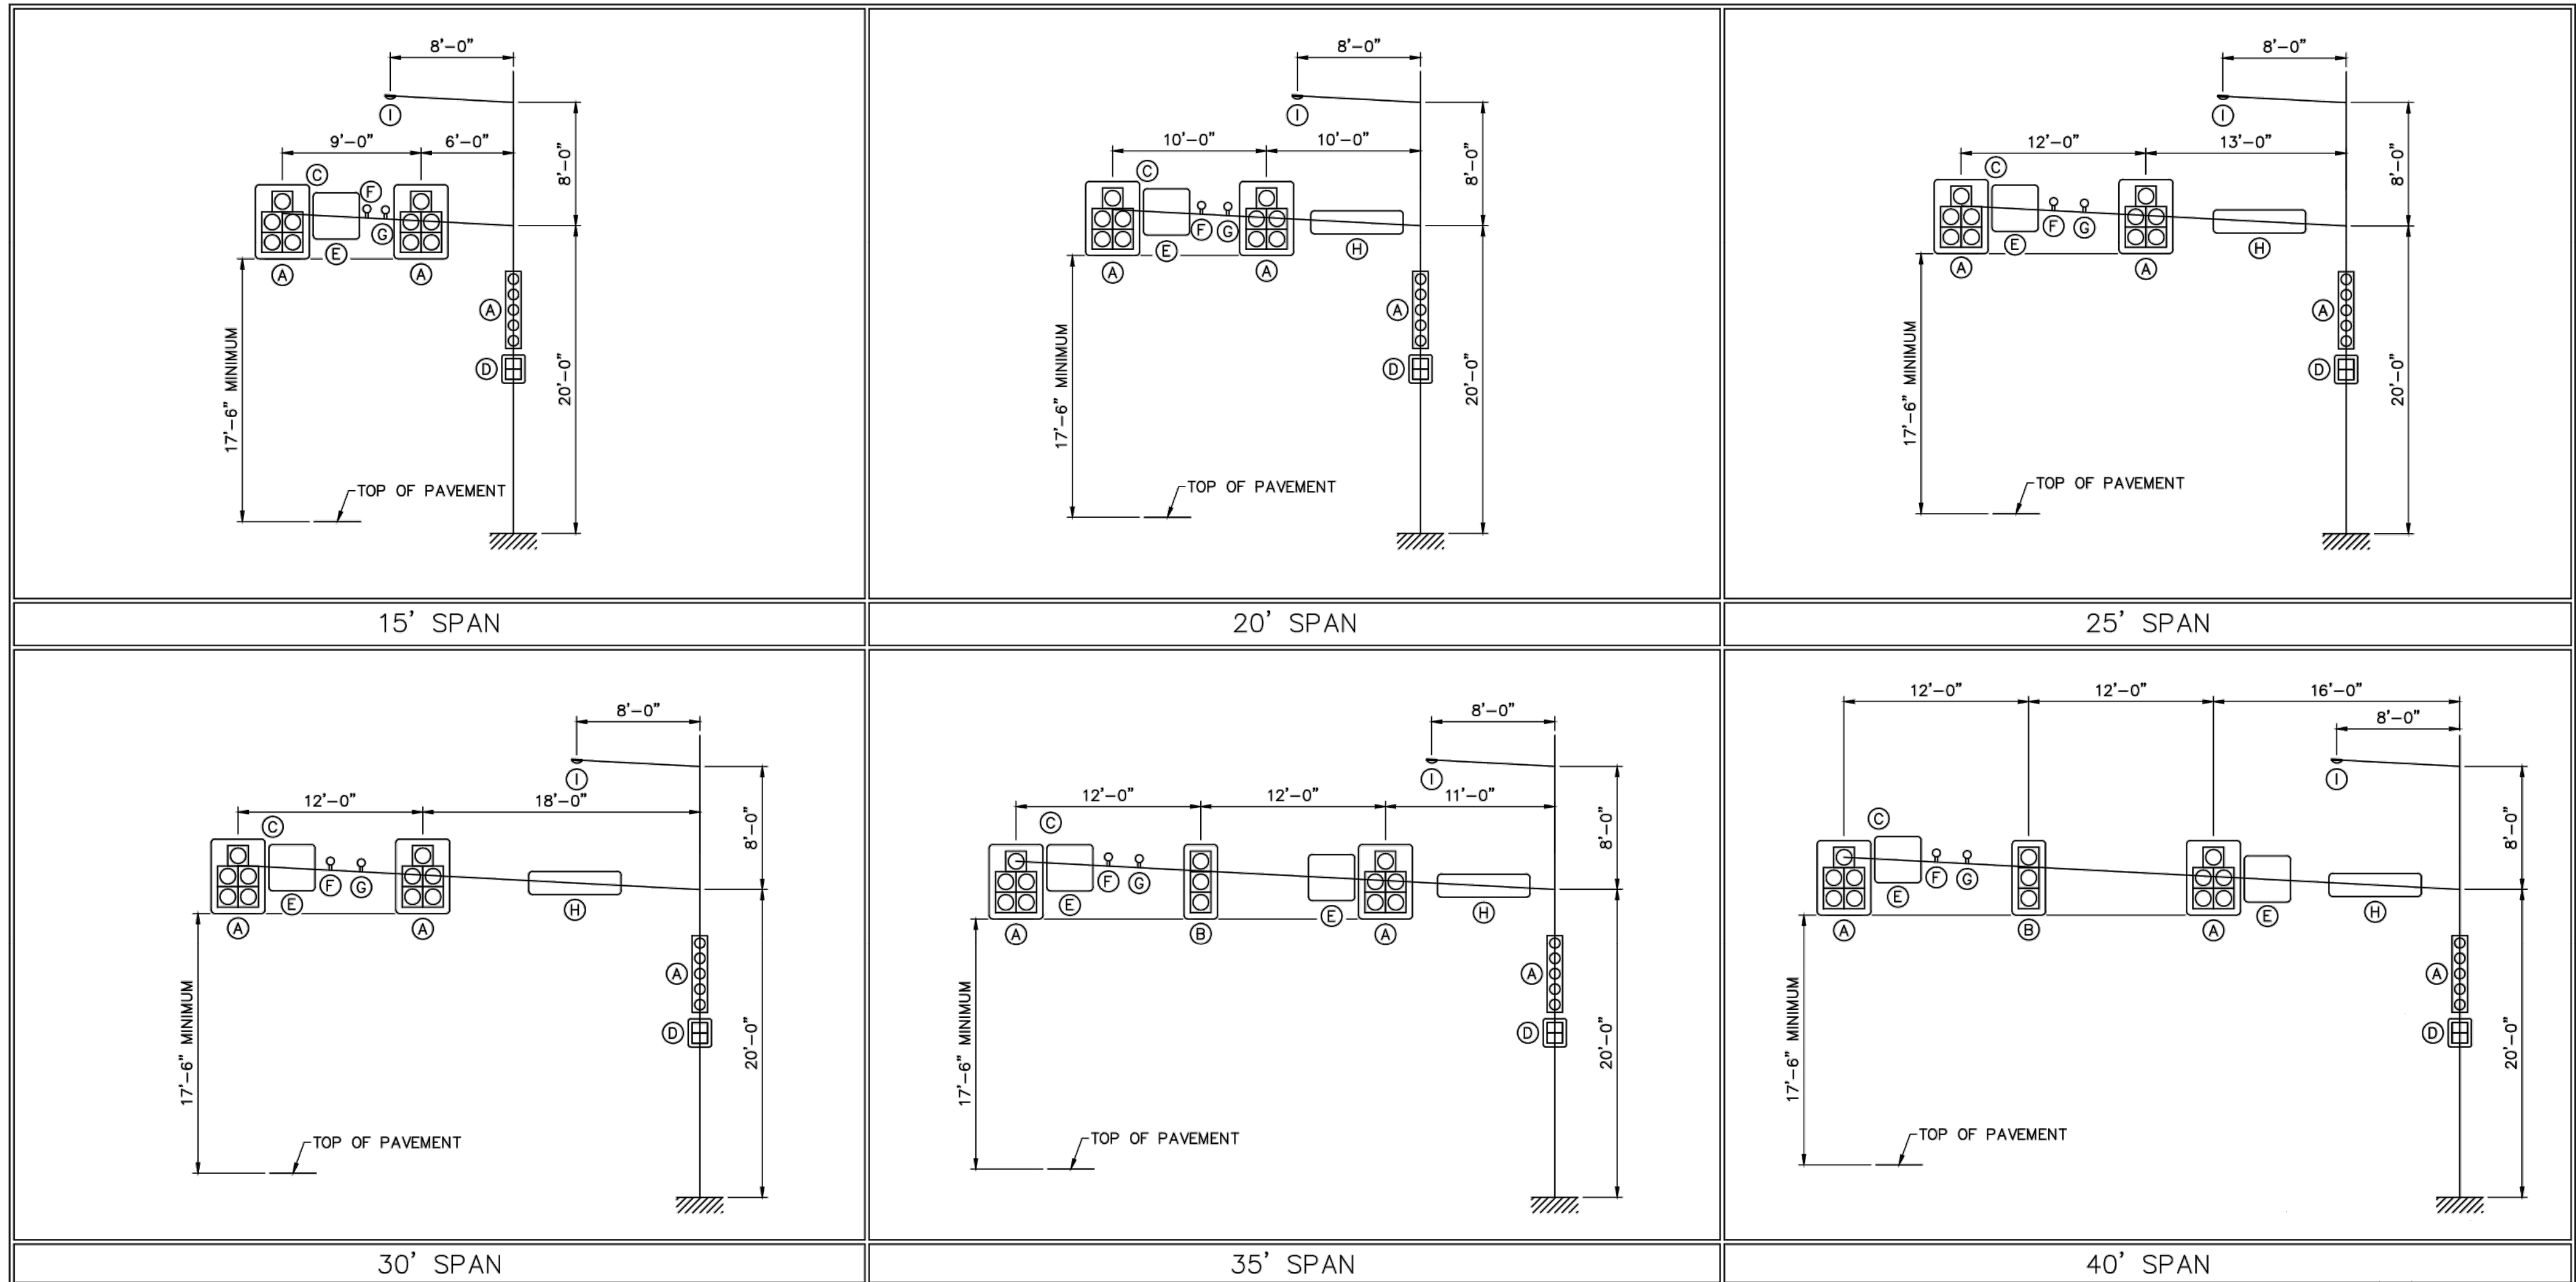

NOTE:
 DETAILS FROM MASSDOT STANDARD DRAWINGS (2015)

DESIGN LOADING							
DEVICE	DESCRIPTION	PROJ. AREA (FT ²)	WEIGHT (LBS)	DEVICE	DESCRIPTION	PROJ. AREA (FT ²)	WEIGHT (LBS)
(A)	5 SECTION, 1 WAY SIGNAL	13.33	110	(F)	DETECTOR	1.00	10
(B)	3 SECTION, 1 WAY SIGNAL	8.67	74	(G)	STROBE	1.00	10
(C)	DAMPENER PLATE (NOT SHOWN)	0.00	9	(H)	72" X 18" STREET NAME SIGN	9.00	12
(D)	DUAL PEDESTRIAN SIGNAL	8.00	80	(I)	OPTIONAL LUMINAIRE	3.30	75
(E)	36" X 36" REGULATORY SIGN	9.00	12				

NOTE: ALL SIGNALS HAVE 5.0" NON-LOUVERED BACKPLATES WITH REFLECTIVE BORDERS

massDOT
 Highway Division
 STANDARD DRAWINGS
 OVERHEAD SIGNAL STRUCTURE & FOUNDATION
 15' - 40' ARM
 LOAD DIAGRAMS
 MASSACHUSETTS DEPARTMENT OF TRANSPORTATION
 HIGHWAY DIVISION
 10 PARK PLAZA BOSTON, MASS
 DECEMBER, 2015

PROJECT: **MINUTEMAN BIKEWAY IMPROVEMENTS AT LAKE STREET**
 DESIGN SUBMISSION: **DRAFT FINAL DESIGN**
 DRAWING TITLE: **TRAFFIC SIGNAL DETAILS 1**

LIGHTING DESIGN SERVICES LUMEN STUDIO, INC.	
ELETRICAL WIRING DESIGN SERVICES ENGINEERING ADVANTAGE, INC.	
NO.	DATE
	REVISIONS


PREPARED FOR:
TOWN OF ARLINGTON
 ENGINEERING DIVISION
 51 GROVE STREET
 ARLINGTON, MA 02476

PREPARED BY:
GREEN INTERNATIONAL AFFILIATES, INC.
 Civil and Structural Engineers (978) 923-0400
 Westford, Massachusetts GreenIntl.com


SCALE: AS NOTED DESIGNED BY: JG
 DATE: 09/15/2017 DRAWN BY: JG
 PROJECT NO. 17067.015 CHECKED BY: JS

SHEET NO.
13 OF **26**


P:\Projects\2017\17067\CONCURRENT DESIGN\TRAFFIC SIGNAL DETAILS.dwg Printed: 11/15/2017 2:44 PM

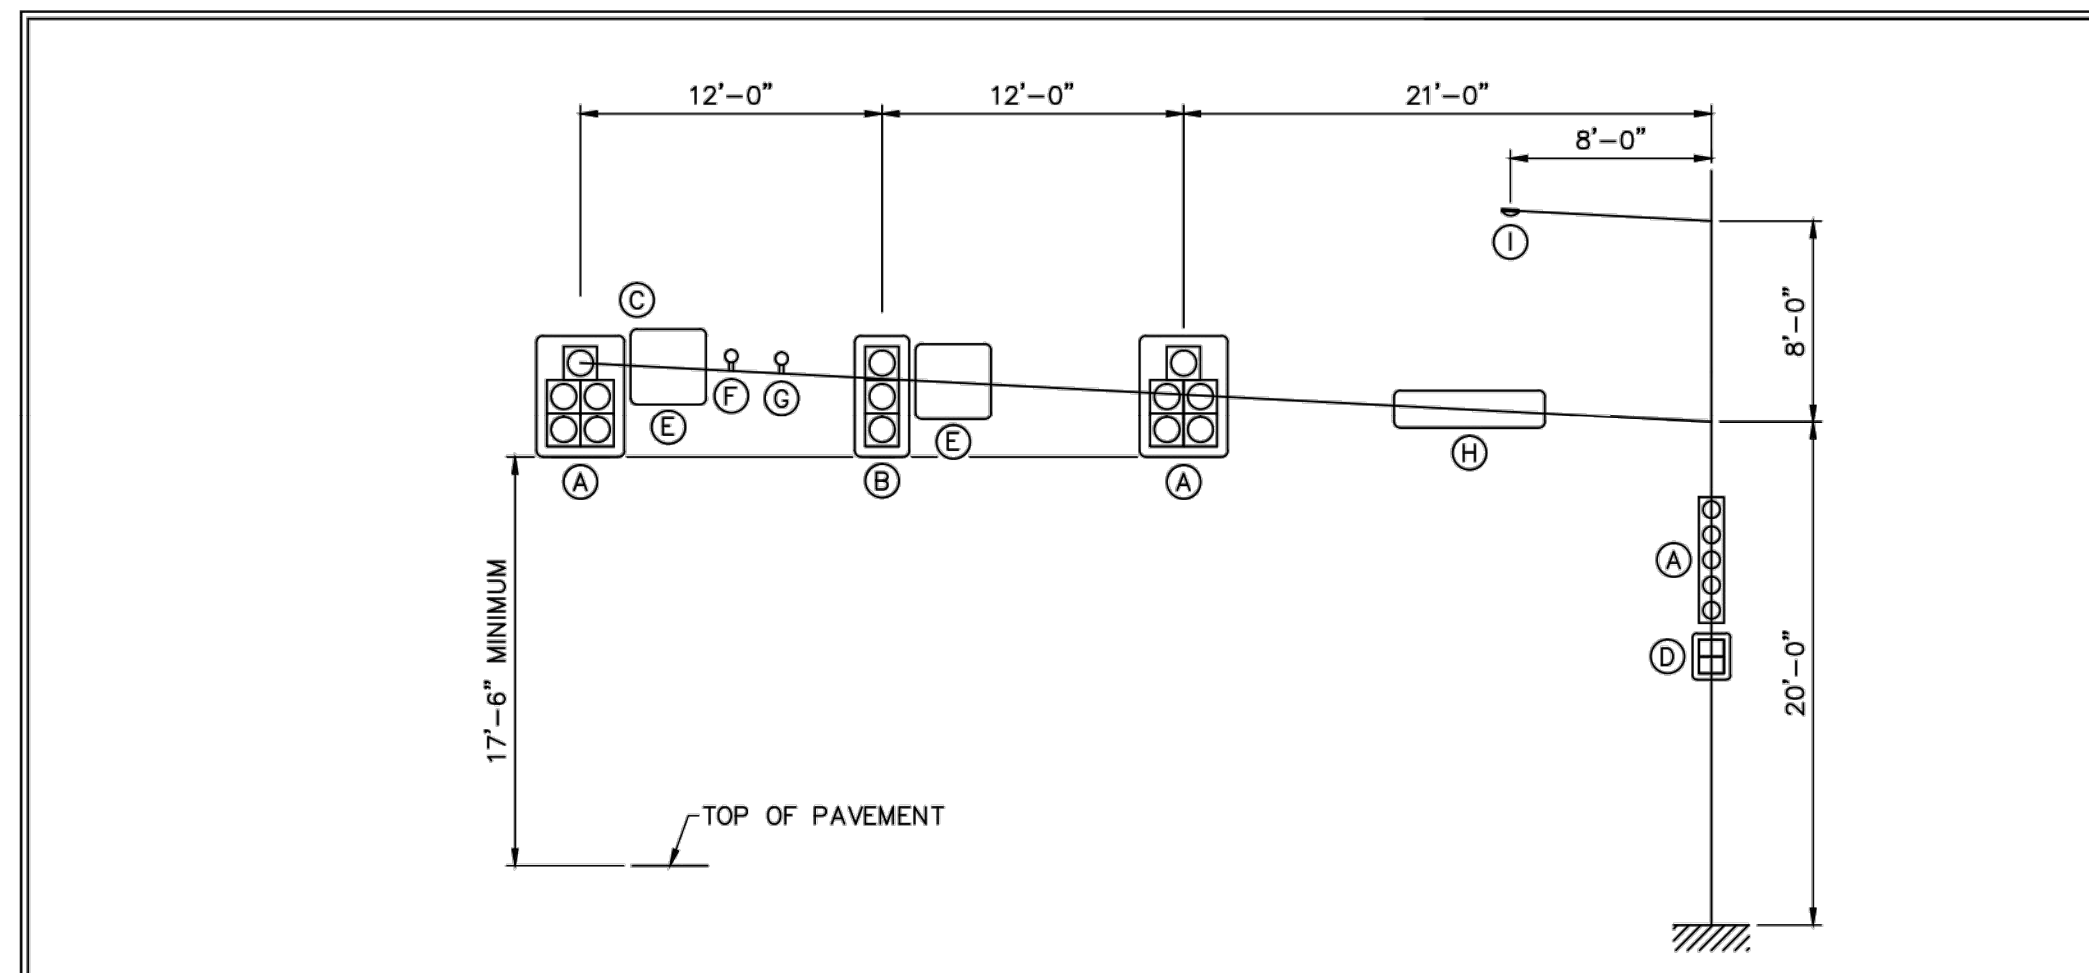


45' SPAN

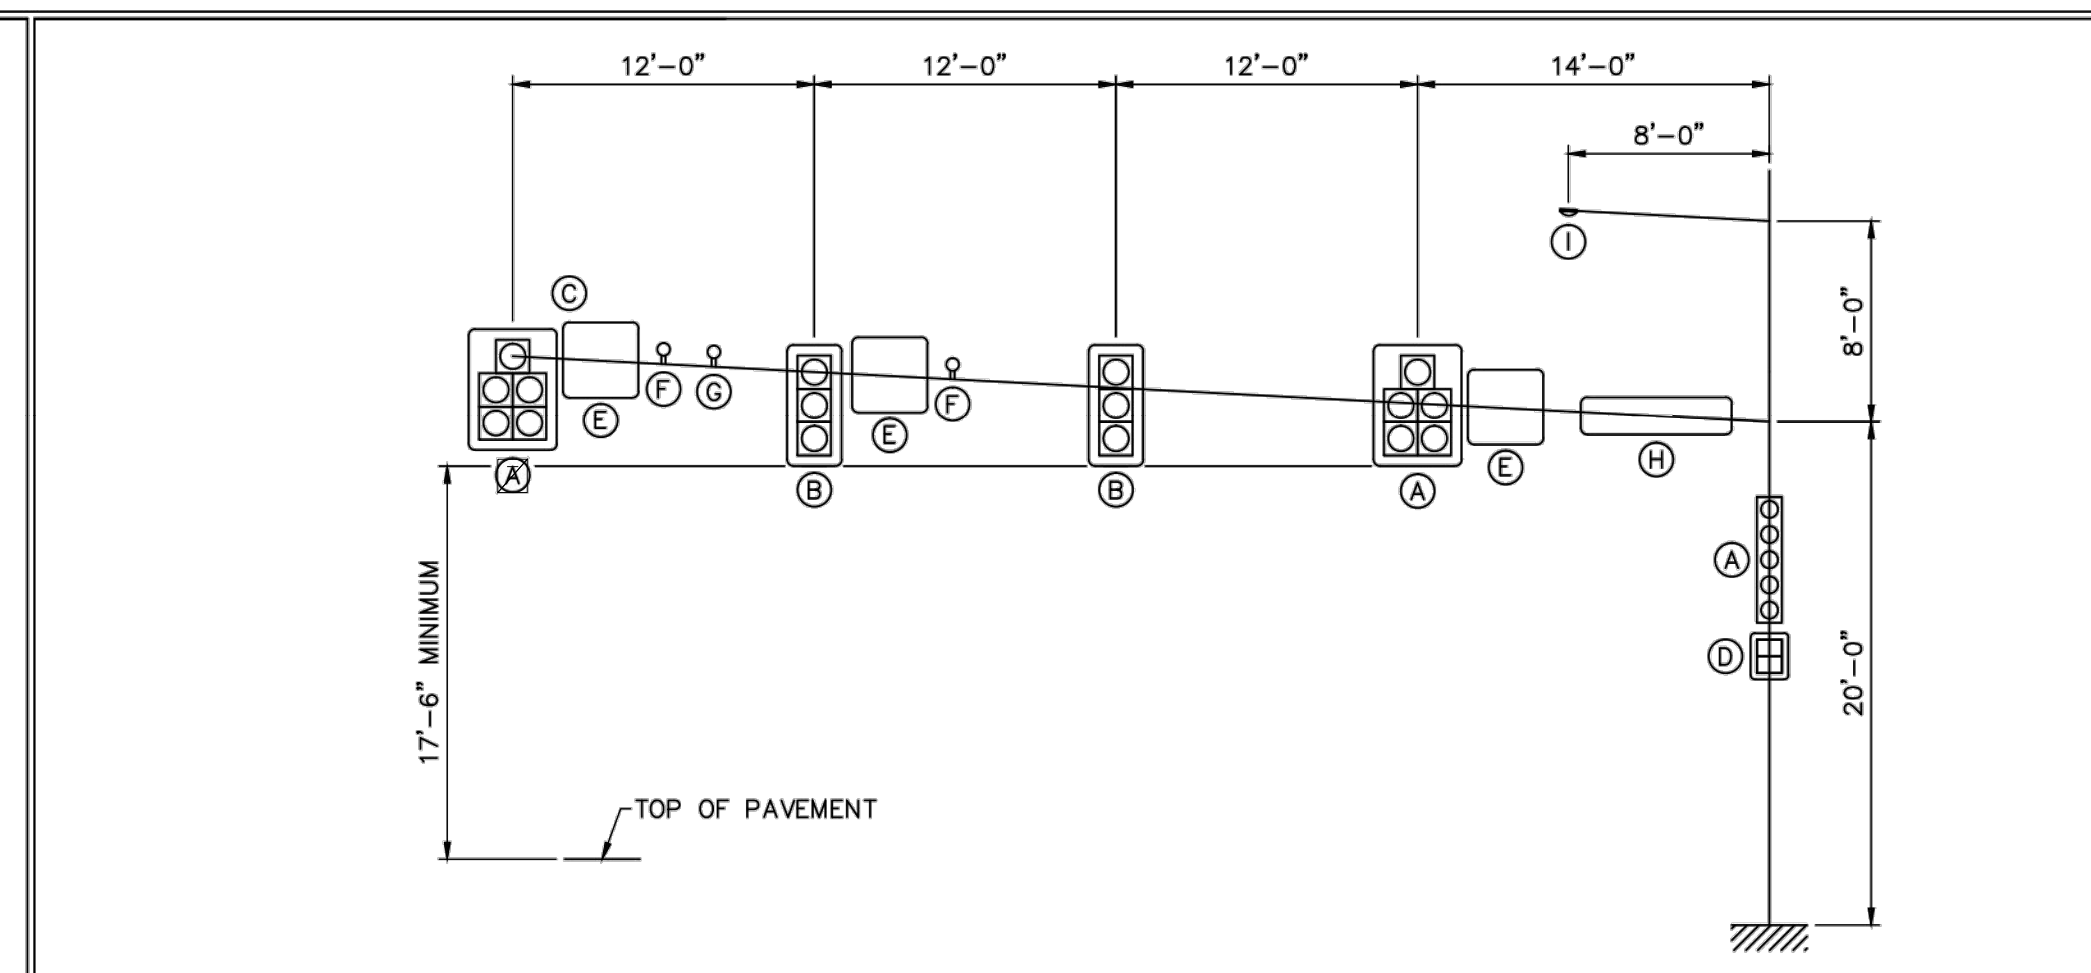

50' SPAN

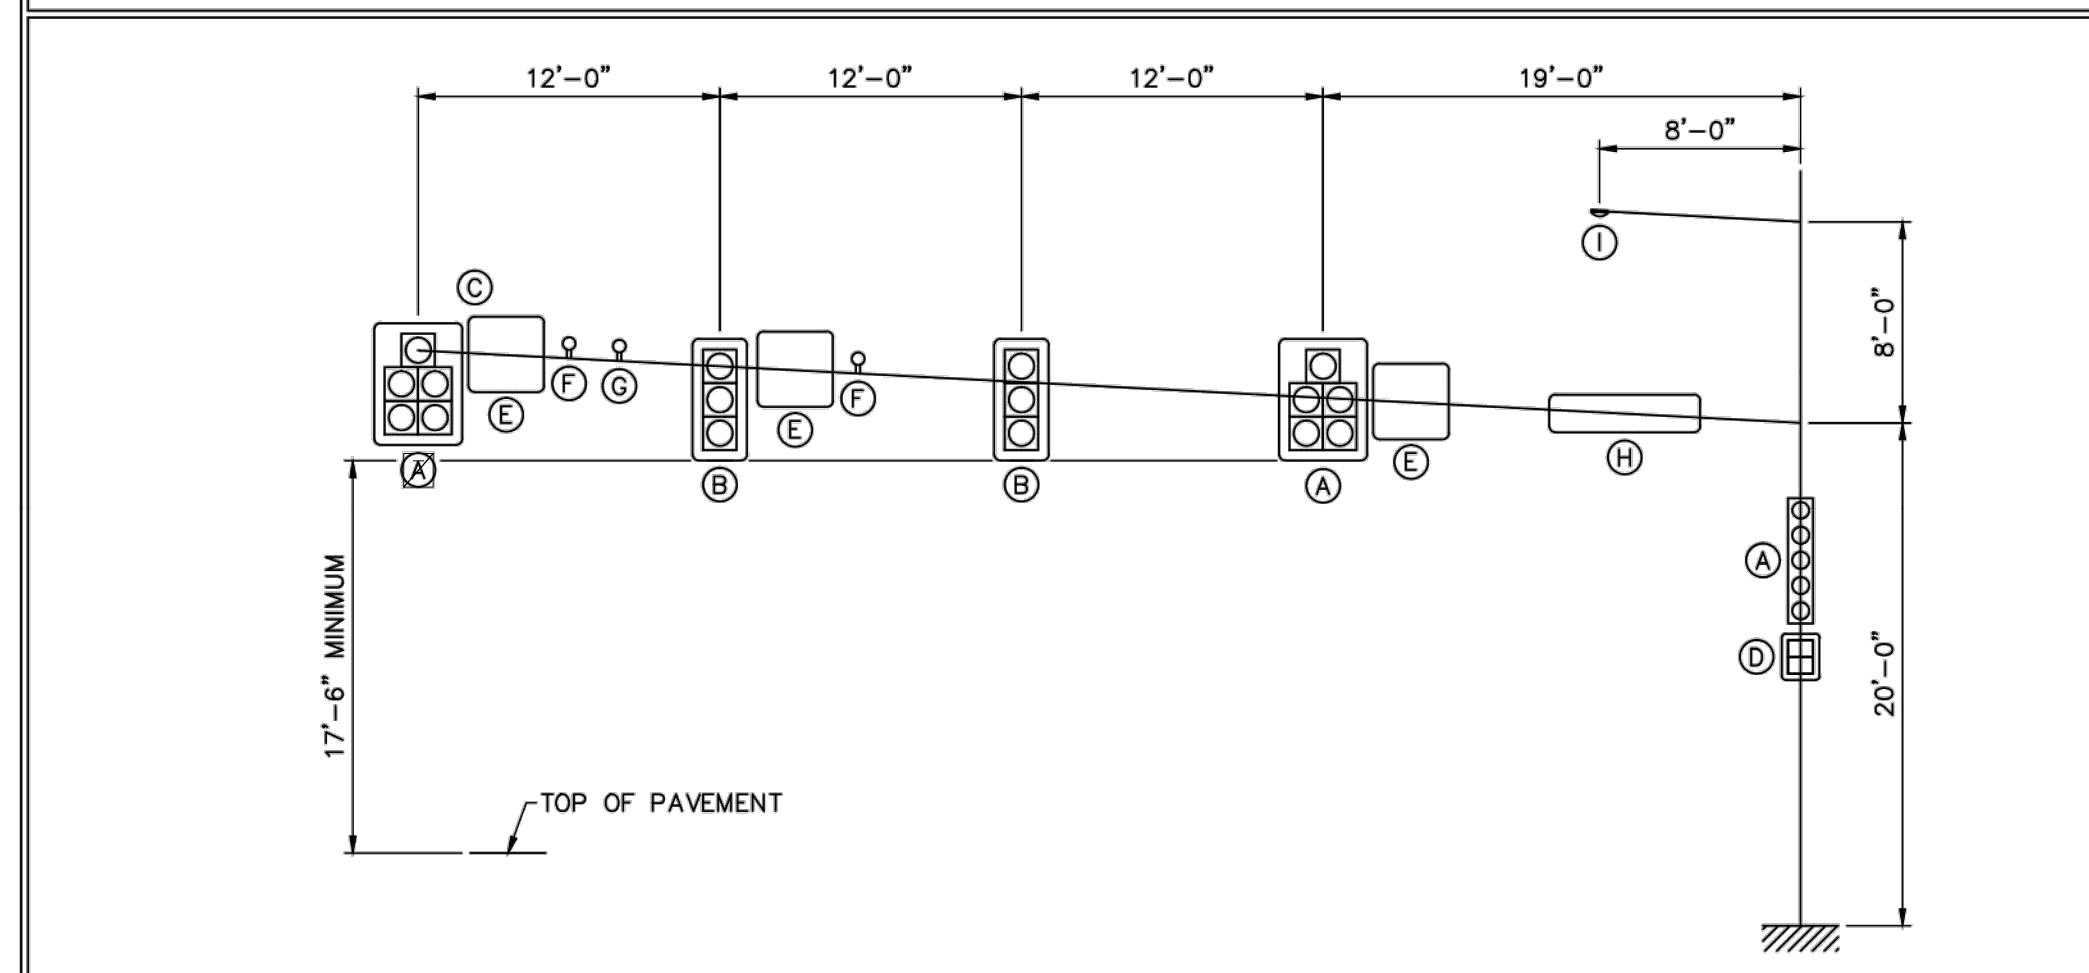

55' SPAN

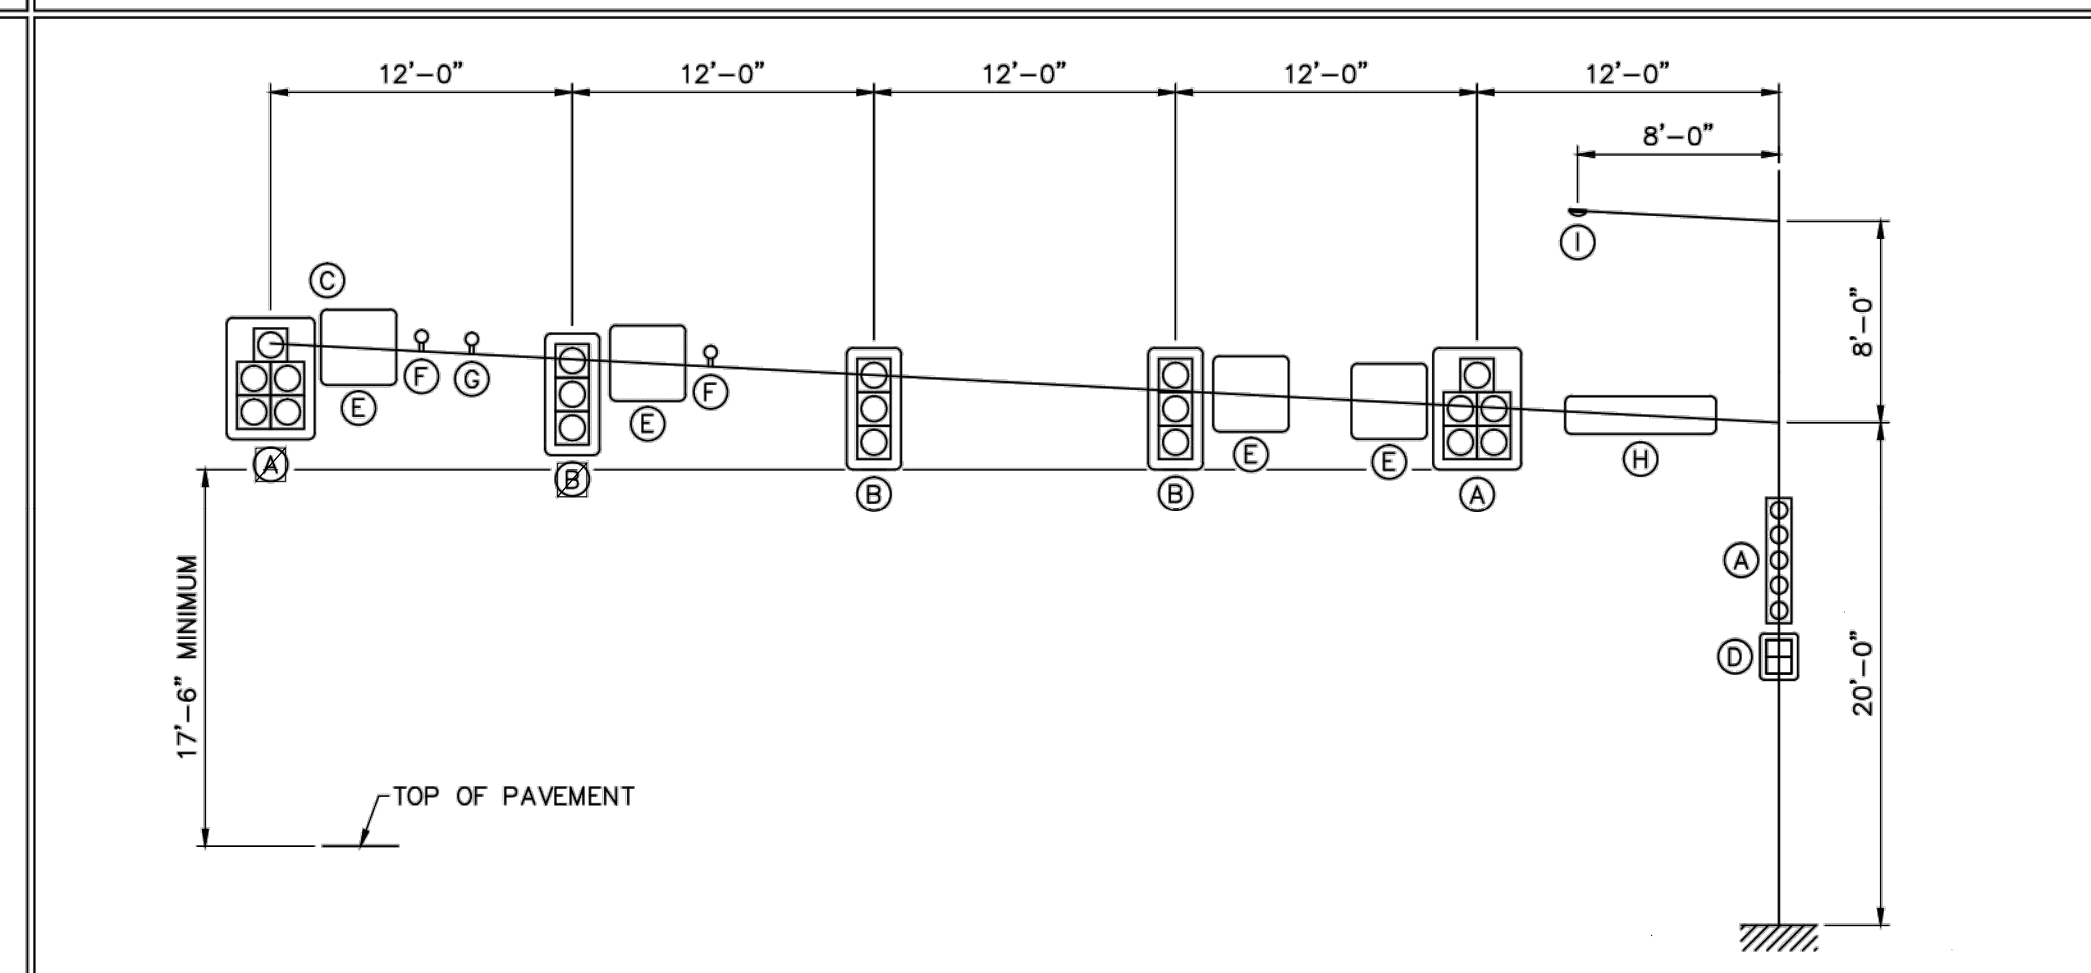

60' SPAN

NOTE:
 DETAILS FROM MASSDOT STANDARD DRAWINGS (2015)

DESIGN LOADING							
DEVICE	DESCRIPTION	PROJ. AREA (FT ²)	WEIGHT (LBS)	DEVICE	DESCRIPTION	PROJ. AREA (FT ²)	WEIGHT (LBS)
(A)	5 SECTION, 1 WAY SIGNAL	13.33	110	(F)	DETECTOR	1.00	10
(B)	3 SECTION, 1 WAY SIGNAL	8.67	74	(G)	STROBE	1.00	10
(C)	DAMPENER PLATE (NOT SHOWN)	0.00	9	(H)	72" X 18" STREET NAME SIGN	9.00	12
(D)	DUAL PEDESTRIAN SIGNAL	8.00	80	(I)	OPTIONAL LUMINAIRE	3.30	75
(E)	36" X 36" REGULATORY SIGN	9.00	12				

NOTE: ALL SIGNALS HAVE 5.0" NON-LOUVERED BACKPLATES WITH REFLECTIVE BORDERS

massDOT
 Highway Division
 STANDARD DRAWINGS
 OVERHEAD SIGNAL STRUCTURE & FOUNDATION
 45' - 60' ARM
 LOAD DIAGRAMS
 MASSACHUSETTS DEPARTMENT OF TRANSPORTATION
 HIGHWAY DIVISION
 10 PARK PLAZA BOSTON, MASS
 DECEMBER, 2015

PROJECT: **MINUTEMAN BIKEWAY IMPROVEMENTS AT LAKE STREET**
 DESIGN SUBMISSION: **DRAFT FINAL DESIGN**
 DRAWING TITLE: **TRAFFIC SIGNAL DETAILS 2**


LIGHTING DESIGN SERVICES
 LUMEN STUDIO, INC.
 ELECTRICAL WIRING DESIGN SERVICES
 ENGINEERING ADVANTAGE, INC.

PREPARED FOR:
 **TOWN OF ARLINGTON**
 ENGINEERING DIVISION
 51 GROVE STREET
 ARLINGTON, MA 02476






PREPARED BY:
 **GREEN INTERNATIONAL AFFILIATES, INC.**
 Civil and Structural Engineers (978) 923-0400
 Westford, Massachusetts GreenIntl.com

SCALE: AS NOTED
 DATE: 09/15/2017
 PROJECT NO. 17067.015
 DESIGNED BY: JG
 DRAWN BY: JG
 CHECKED BY: JS
 SHEET NO. **14** OF **26**

NO.	DATE	REVISIONS

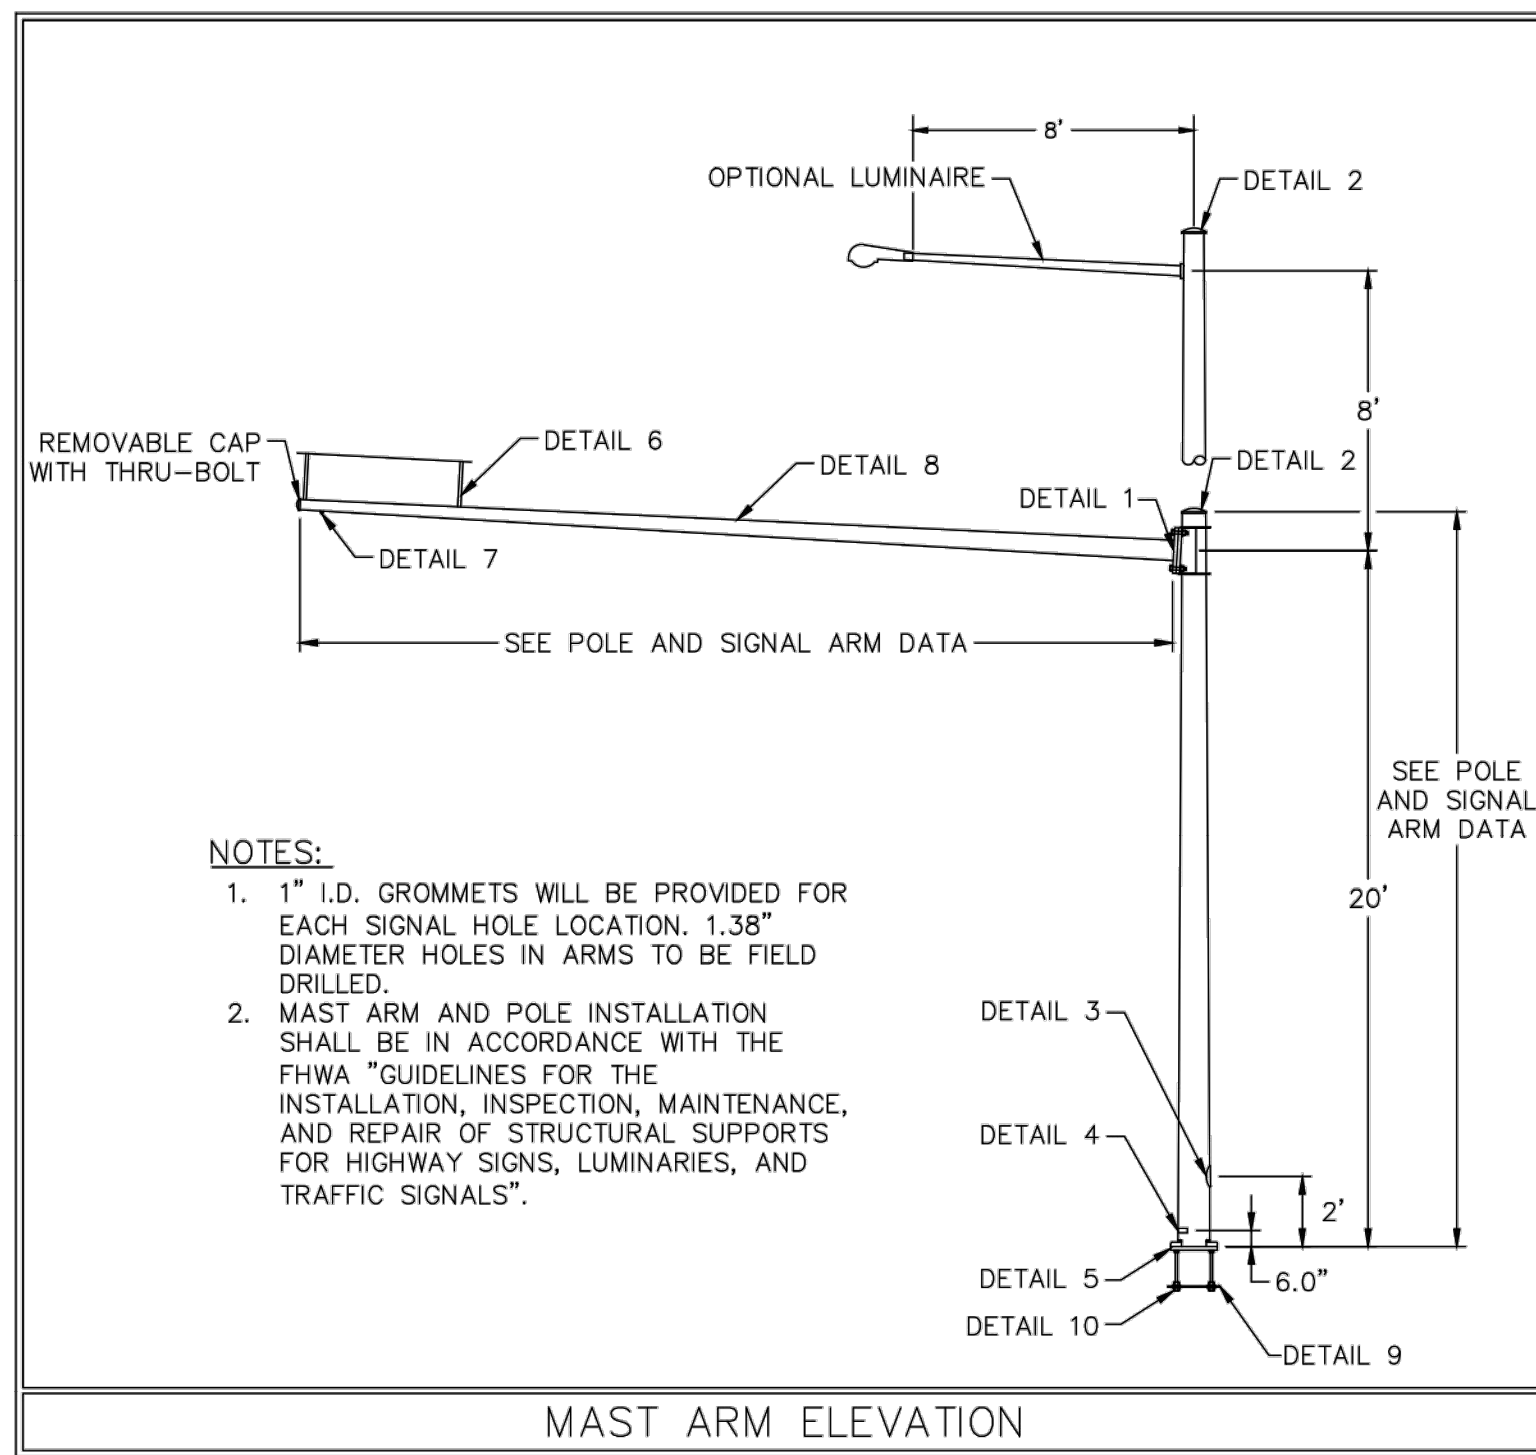





- NOTES:**
- 1" I.D. GROMMETS WILL BE PROVIDED FOR EACH SIGNAL HOLE LOCATION. 1.38" DIAMETER HOLES IN ARMS TO BE FIELD DRILLED.
 - MAST ARM AND POLE INSTALLATION SHALL BE IN ACCORDANCE WITH THE FHWA "GUIDELINES FOR THE INSTALLATION, INSPECTION, MAINTENANCE, AND REPAIR OF STRUCTURAL SUPPORTS FOR HIGHWAY SIGNS, LUMINARIES, AND TRAFFIC SIGNALS".

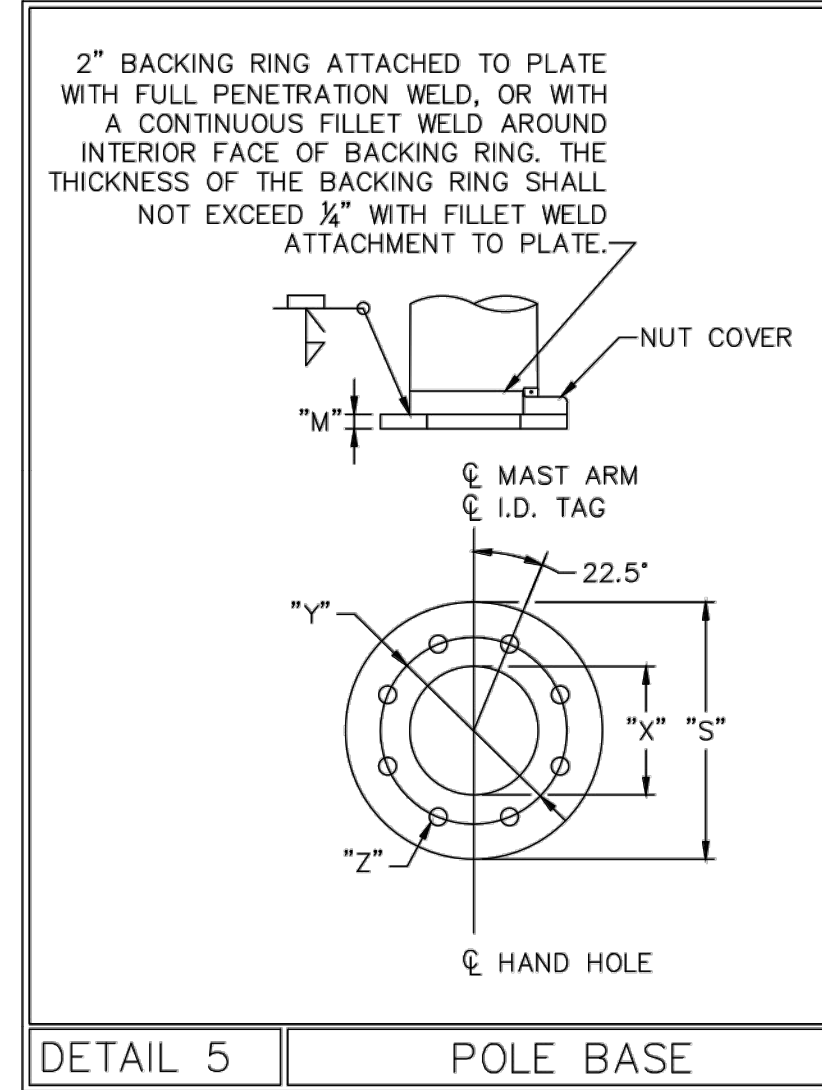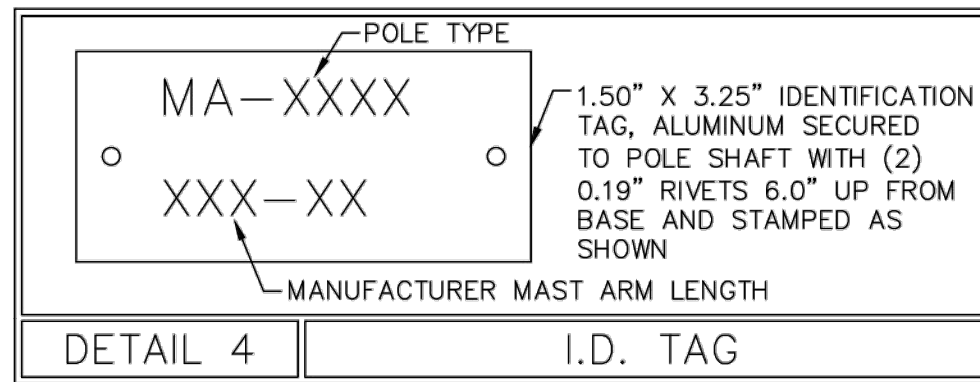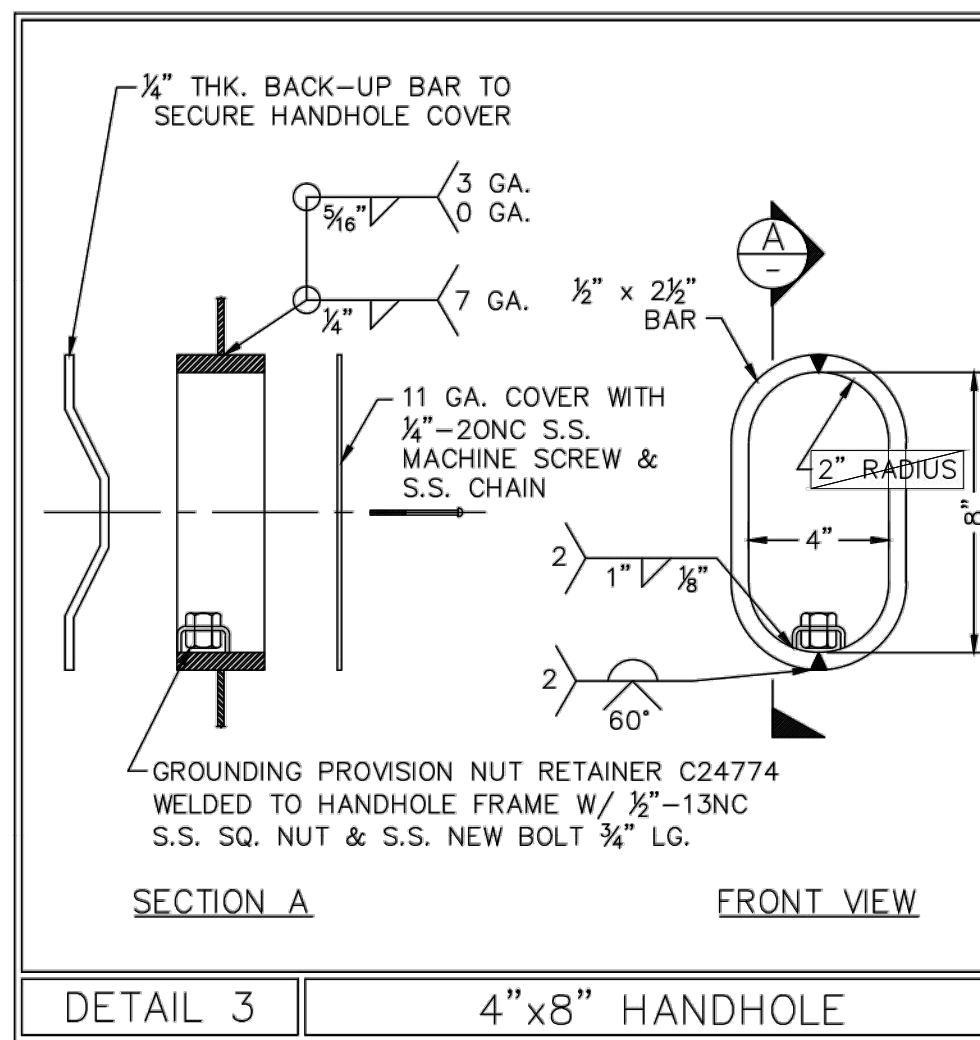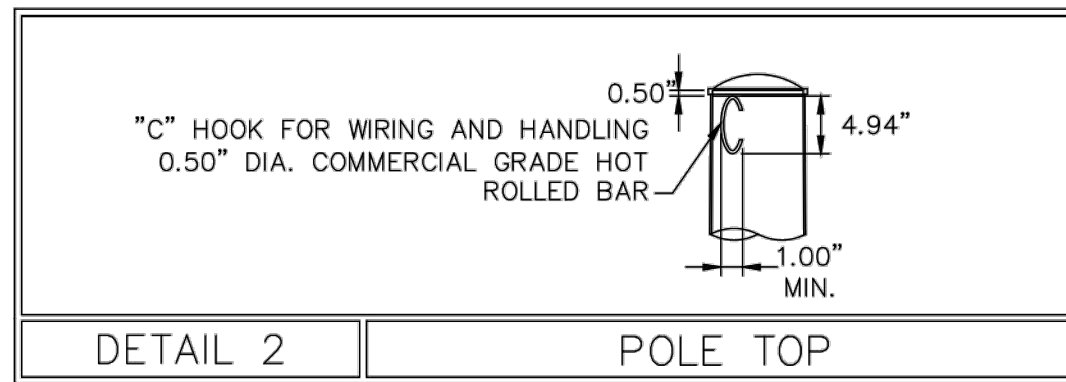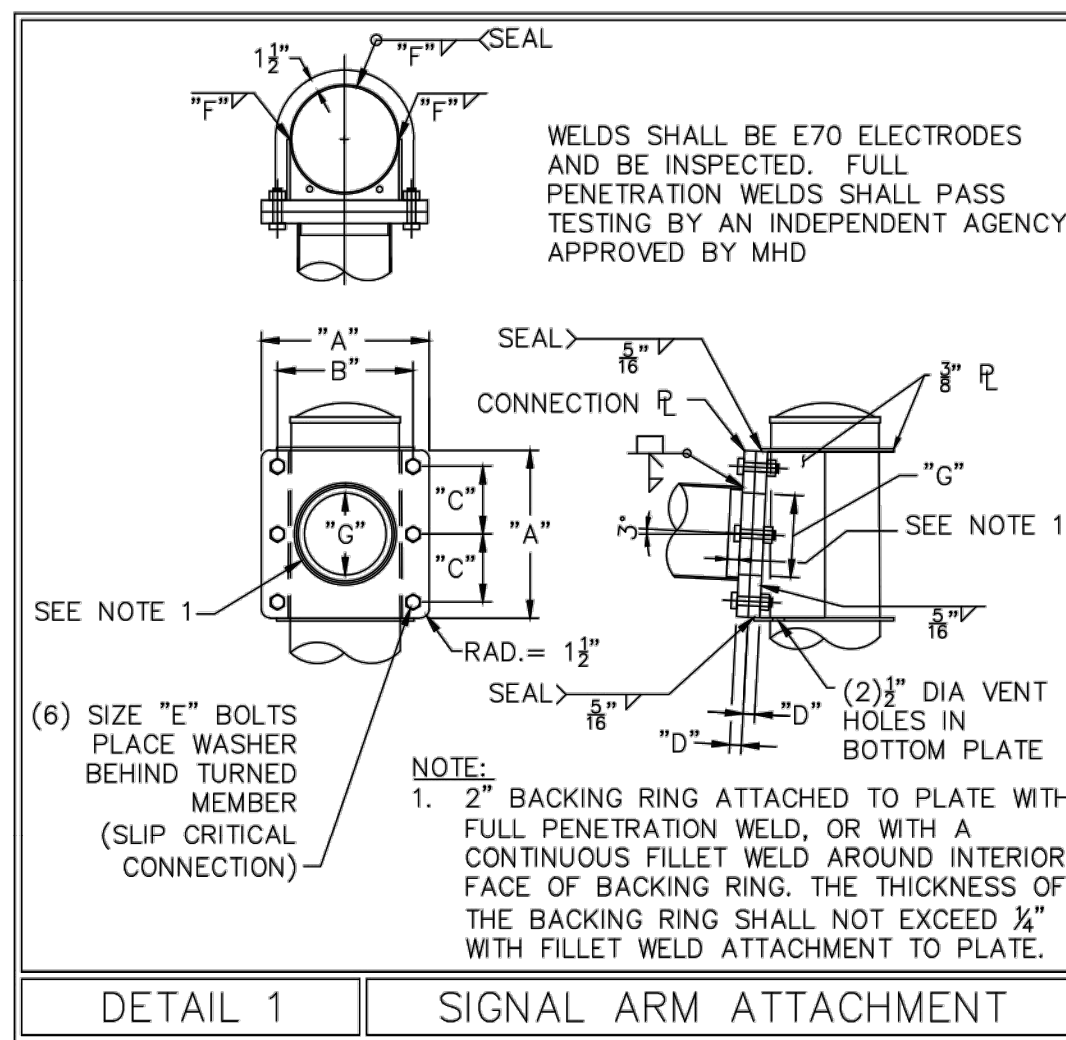


NOTE:
DETAILS FROM MASSDOT STANDARD DRAWINGS (2015)

MATERIAL DATA		
COMPONENT	DESIGNATION	YIELD (KSI)
POLE TUBE	ASTM A595 GR. A	55
POLE BASE PLATE	AASHTO M270, OR ASTM A709	50
ANCHOR BOLTS	AASHTO M314, OR ASTM A307 GR. C	55
GALVANIZING	AASHTO M111 OR M232	
ARM TUBE	ASTM A595 GR. A	55
ARM CONNECTION PLATE	AASHTO M270, OR ASTM A709	50
ARM CONNECTING BOLTS	AASHTO M164, OR ASTM A325 **	

** BOLTS WHICH ACCUMULATE RUST OR DIRT SHALL BE DISCARDED.

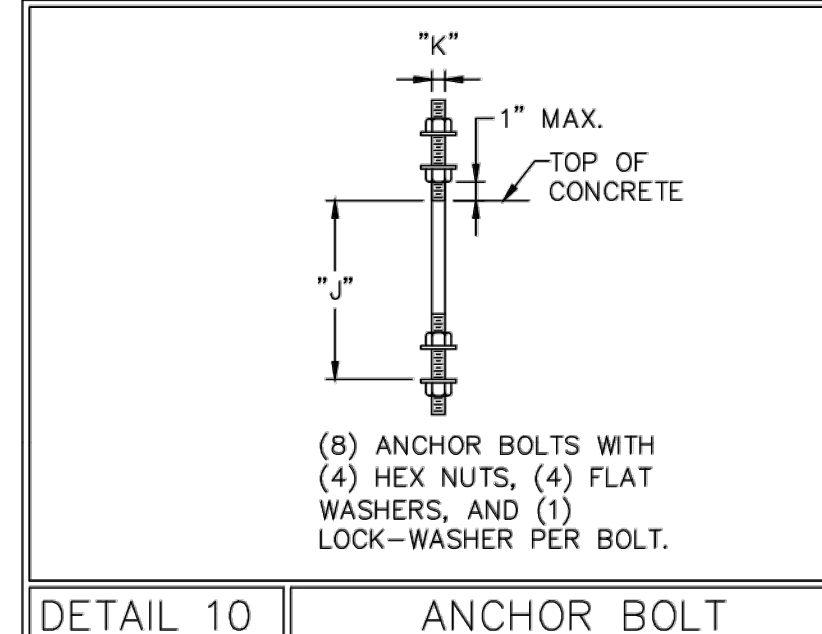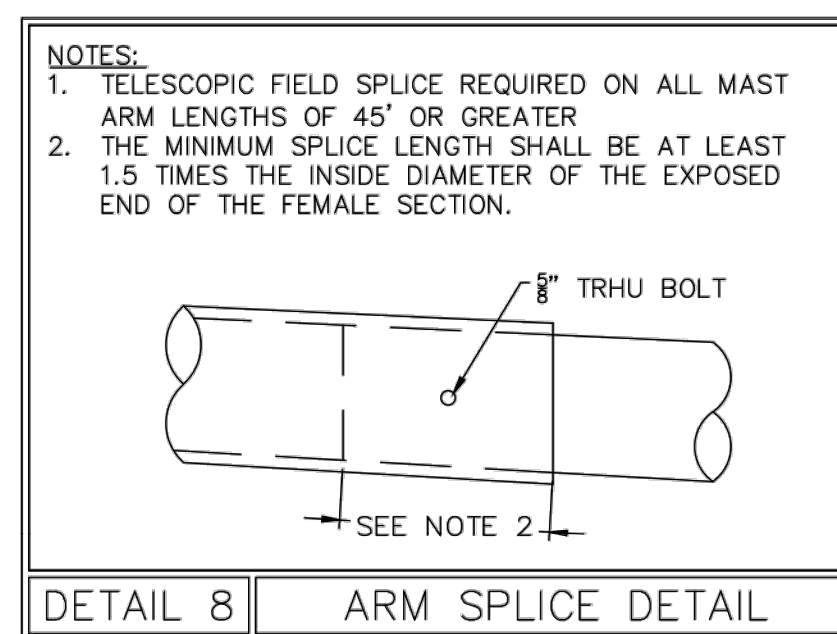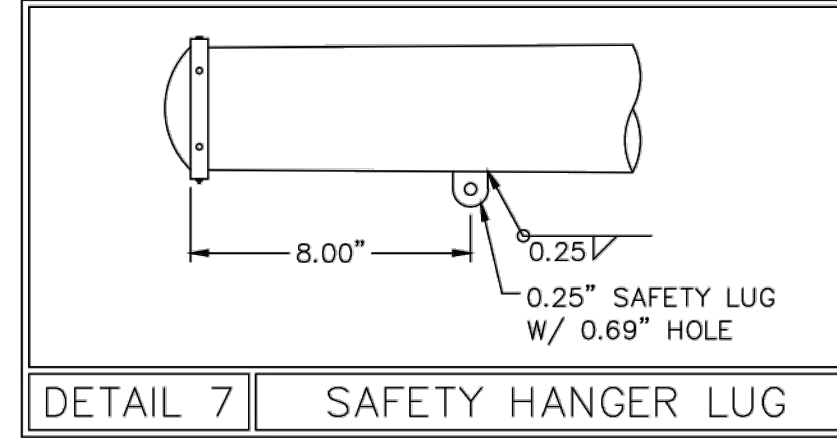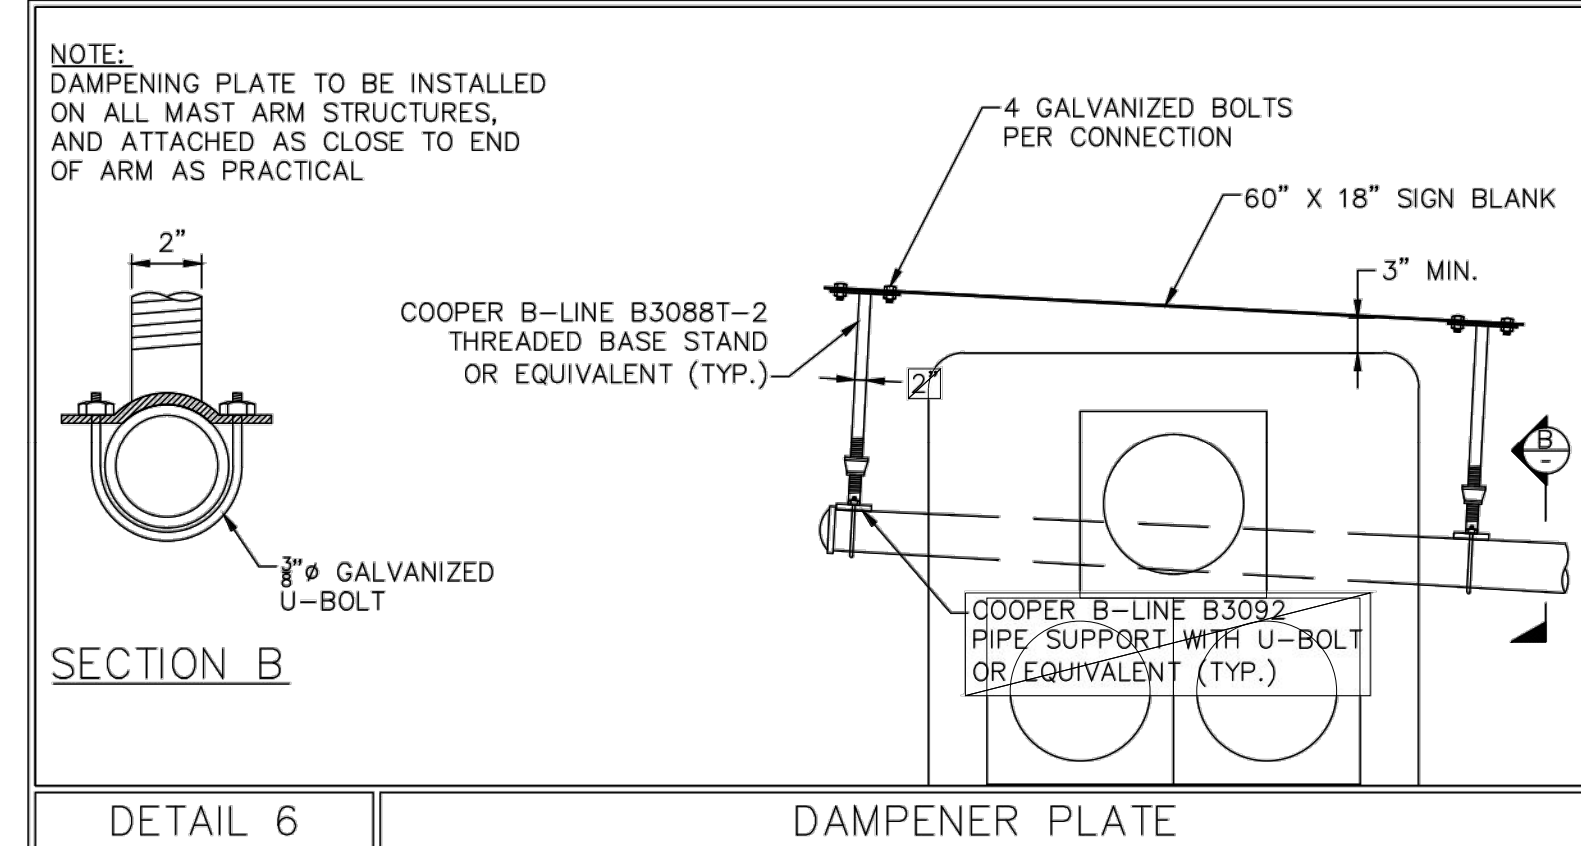

LOCATIONS	SIGNAL ARM TUBE		POLE TUBE		POLE BASE					ANCHOR BOLT		SIGNAL ARM ATTACHMENT DATA										
	SPAN (FT)	FIXED END DIA. (IN)	FREE END DIA. (IN)	WALL THK.	BASE DIA. (IN)	TOP DIA. (IN)	LENGTH (FT)	WALL THK.	PLATE CIRCLE "S" (IN)	BOLT CIRCLE "Y" (IN)	THK. "M" (IN)	HOLE "Z" (IN)	HOLE "X" (IN)	DIA. "K" (IN)	EMBED. LENGTH "J" (IN)	"A" (IN)	"B" (IN)	"C" (IN)	"D" (IN)	"E" (IN)	"F" (IN)	"G" (IN)
	15.00	9.00	6.90	7 GA.	13.00	9.92	22.00	7 GA.	24.00	19.00	2.00	1.50	10.00	1.25	36.00	17.25	14.00	7.00	2.00	1.00	0.188	7.00
	20.00	9.00	6.20	7 GA.	13.00	9.92	22.00	3 GA.	27.00	22.00	2.00	1.75	10.00	1.50	36.00	17.75	14.50	7.25	2.00	1.00	0.250	7.00
	25.00	10.00	6.50	7 GA.	13.00	9.92	22.00	3 GA.	27.00	22.00	2.00	1.75	10.00	1.50	36.00	18.25	15.00	7.50	2.00	1.00	0.250	7.50
	30.00	11.00	6.80	7 GA.	13.50	10.42	22.00	3 GA.	27.00	22.00	2.00	1.75	10.50	1.50	36.00	18.75	15.50	7.75	2.00	1.00	0.250	8.75
	35.00	12.00	7.10	3 GA.	15.00	11.92	22.00	3 GA.	27.00	22.00	2.00	1.75	12.50	1.50	36.00	20.25	17.00	8.50	2.00	1.25	0.313	6.50
	40.00	13.00	7.40	3 GA.	16.00	12.92	22.00	3 GA.	29.00	24.00	2.00	2.00	12.00	1.75	36.00	21.25	18.00	9.00	2.00	1.25	0.313	6.75
	45.00	13.50	7.20	3 GA.	17.50	14.42	22.00	3 GA.	29.00	24.00	2.00	2.00	12.00	1.75	48.00	22.25	19.00	9.50	2.25	1.25	0.313	8.00
	50.00	14.50	7.50	3 GA.	17.00	13.92	22.00	0 GA.	29.00	24.00	2.00	2.00	12.00	1.75	48.00	22.75	19.50	9.75	2.25	1.25	0.313	8.50
	55.00	16.00	8.30	3 GA.	18.00	14.92	22.00	0 GA.	31.00	26.00	2.00	2.25	12.00	2.00	48.00	23.75	20.00	10.00	2.25	1.25	0.313	8.75
	60.00	16.00	8.00	0 GA.	19.50	16.42	22.00	0 GA.	31.00	26.00	2.00	2.25	14.00	2.00	48.00	25.75	22.00	11.00	2.50	1.50	0.313	7.50

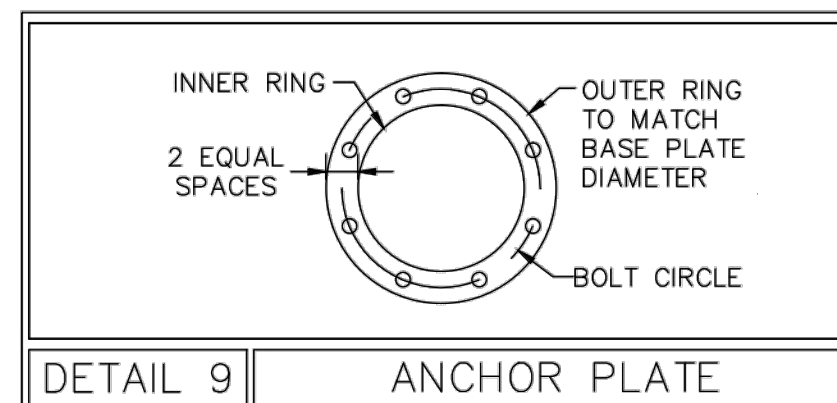

massDOT
Standard Drawings
OVERHEAD SIGNAL STRUCTURE & FOUNDATION
MAST ARM DETAILS
MASSACHUSETTS DEPARTMENT OF TRANSPORTATION
HIGHWAY DIVISION
10 PARK PLAZA BOSTON, MASS
DECEMBER, 2015

PROJECT: **MINUTEMAN BIKEWAY IMPROVEMENTS AT LAKE STREET**
DESIGN SUBMISSION: **DRAFT FINAL DESIGN**
DRAWING TITLE: **TRAFFIC SIGNAL DETAILS 3**

PREPARED FOR:
TOWN OF ARLINGTON ENGINEERING DIVISION
51 GROVE STREET
ARLINGTON, MA 02476

PREPARED BY:
GREEN INTERNATIONAL AFFILIATES, INC.
Civil and Structural Engineers
Westford, Massachusetts
(978) 923-0400
GreenIntl.com

SCALE: AS NOTED
DATE: 09/15/2017
PROJECT NO. 17067.015

DESIGNED BY: JG
DRAWN BY: JG
CHECKED BY: JS

SHEET NO. **15** OF **26**

© 2015 MASSDOT. ALL RIGHTS RESERVED. DESIGN AND TRAFFIC SIGNAL DETAILS 3 (2015) 15 OF 26


PIER FOUNDATIONS FOR 110 MPH WIND SPEED ZONE																				
SOIL TYPE	15' & 20' MAST ARMS				25' & 30' MAST ARMS				35' & 40' MAST ARMS				45' & 50' MAST ARMS				55' & 60' MAST ARMS			
	DIAMETER	DEPTH	VERT. BARS	TIE BARS	DIAMETER	DEPTH	VERT. BARS	TIE BARS	DIAMETER	DEPTH	VERT. BARS	TIE BARS	DIAMETER	DEPTH	VERT. BARS	TIE BARS	DIAMETER	DEPTH	VERT. BARS	TIE BARS
DRY SAND (LOOSE)	3'-6"	8'-6"	18-#8	#5 @ 12"	3'-6"	9'-0"	18-#8	#5 @ 12"	3'-6"	11'-6"	18-#8	#5 @ 9"	4'-0"	12'-0"	18-#9	#5 @ 9"	4'-6"	13'-0"	18-#10	#5 @ 6"
DRY SAND (DENSE)	3'-6"	7'-6"	18-#8	#5 @ 12"	3'-6"	7'-6"	18-#8	#5 @ 12"	3'-6"	8'-6"	18-#8	#5 @ 9"	4'-0"	9'-0"	18-#9	#5 @ 9"	4'-6"	9'-6"	18-#10	#5 @ 6"
WET SAND (LOOSE)	3'-6"	9'-6"	18-#8	#5 @ 12"	3'-6"	11'-6"	18-#8	#5 @ 12"	3'-6"	14'-6"	18-#8	#5 @ 9"	4'-0"	15'-6"	18-#9	#5 @ 9"	4'-6"	16'-6"	18-#10	#5 @ 6"
WET SAND (DENSE)	3'-6"	8'-6"	18-#8	#5 @ 12"	3'-6"	9'-0"	18-#8	#5 @ 12"	3'-6"	10'-6"	18-#8	#5 @ 9"	4'-0"	11'-6"	18-#9	#5 @ 9"	4'-6"	12'-0"	18-#10	#5 @ 6"
CLAY (SOFT TO MEDIUM STIFF)	3'-6"	12'-0"	18-#8	#5 @ 12"	3'-6"	12'-0"	18-#8	#5 @ 12"	3'-6"	13'-0"	18-#8	#5 @ 9"	4'-0"	14'-0"	18-#9	#5 @ 9"	4'-6"	15'-6"	18-#10	#5 @ 6"
CLAY (STIFF)	3'-6"	10'-6"	18-#8	#5 @ 12"	3'-6"	10'-6"	18-#8	#5 @ 12"	3'-6"	11'-0"	18-#8	#5 @ 9"	4'-0"	12'-0"	18-#9	#5 @ 9"	4'-6"	13'-6"	18-#10	#5 @ 6"

PIER FOUNDATIONS FOR 130 MPH WIND SPEED ZONE																				
SOIL TYPE	15' & 20' MAST ARMS				25' & 30' MAST ARMS				35' & 40' MAST ARMS				45' & 50' MAST ARMS				55' & 60' MAST ARMS			
	DIAMETER	DEPTH	VERT. BARS	TIE BARS	DIAMETER	DEPTH	VERT. BARS	TIE BARS	DIAMETER	DEPTH	VERT. BARS	TIE BARS	DIAMETER	DEPTH	VERT. BARS	TIE BARS	DIAMETER	DEPTH	VERT. BARS	TIE BARS
DRY SAND (LOOSE)	3'-6"	10'-0"	18-#8	#5 @ 12"	3'-6"	10'-6"	18-#8	#5 @ 12"	3'-6"	13'-6"	18-#8	#5 @ 8"	4'-0"	14'-6"	18-#9	#5 @ 6"	4'-6"	15'-6"	18-#10	#5 @ 5"
DRY SAND (DENSE)	3'-6"	8'-6"	18-#8	#5 @ 12"	3'-6"	9'-0"	18-#8	#5 @ 12"	3'-6"	10'-0"	18-#8	#5 @ 8"	4'-0"	11'-0"	18-#9	#5 @ 6"	4'-6"	11'-6"	18-#10	#5 @ 5"
WET SAND (LOOSE)	3'-6"	11'-6"	18-#8	#5 @ 12"	3'-6"	13'-6"	18-#8	#5 @ 12"	3'-6"	17'-0"	18-#8	#5 @ 6"	4'-0"	18'-6"	18-#9	#5 @ 6"	4'-6"	19'-6"	18-#10	#5 @ 5"
WET SAND (DENSE)	3'-6"	10'-0"	18-#8	#5 @ 12"	3'-6"	10'-0"	18-#8	#5 @ 12"	3'-6"	12'-6"	18-#8	#5 @ 8"	4'-0"	13'-6"	18-#9	#5 @ 6"	4'-6"	14'-6"	18-#10	#5 @ 5"
CLAY (SOFT TO MEDIUM STIFF)	3'-6"	12'-6"	18-#8	#5 @ 12"	3'-6"	13'-0"	18-#8	#5 @ 12"	3'-6"	14'-0"	18-#8	#5 @ 8"	4'-0"	16'-0"	18-#9	#5 @ 6"	4'-6"	17'-6"	18-#10	#5 @ 5"
CLAY (STIFF)	3'-6"	11'-0"	18-#8	#5 @ 12"	3'-6"	11'-0"	18-#8	#5 @ 12"	3'-6"	12'-0"	18-#8	#5 @ 8"	4'-0"	13'-0"	18-#9	#5 @ 6"	4'-6"	14'-0"	18-#10	#5 @ 5"


BASIS OF DESIGN			
ALL MAST ARM STRUCTURES AND FOUNDATIONS ARE DESIGNED IN ACCORDANCE WITH AASHTO STANDARD SPECIFICATIONS FOR STRUCTURAL SUPPORTS FOR HIGHWAY SIGNS, LUMINAIRES, AND TRAFFIC SIGNALS, SIXTH EDITION 2013, AND THE FOLLOWING PARAMETERS:			
OVERTURNING DESIGN	FOUNDATIONS ARE SIZED TO RESIST OVERTURNING ACCORDING TO BROMS' DESIGN METHOD WITH A SAFETY FACTOR THAT INCLUDES AN OVERLOAD FACTOR OF 2.0 AND A SOIL UNDERSTRENGTH FACTOR OF 0.7.		
SOIL PARAMETERS	UNIT WEIGHT	FRICTION ANGLE	
	LOOSE DRY SAND: $\gamma = 102$ PCF	$\phi = 33^\circ$	
	DENSE DRY SAND: $\gamma = 116$ PCF	$\phi = 39^\circ$	
	LOOSE WET SAND: $\gamma = 125$ PCF	$\phi = 33^\circ$	
DENSE WET SAND: $\gamma = 135$ PCF	$\phi = 39^\circ$		
	UNIT WEIGHT	SHEAR STRENGTH	
SOFT TO MEDIUM STIFF CLAY: $\gamma = 113$ PCF	$S_u = 1.0$ KSF		
STIFF CLAY: $\gamma = 120$ PCF	$S_u = 1.9$ KSF		
DEFLECTION LIMITS	MAXIMUM LATERAL DEFLECTION AT TOP OF MAST ARM FOUNDATION SHAFTS: $\frac{1}{2}$ "		

NOTES:


- FOUNDATIONS SHALL BE 4000 PSI, 565 MASSDOT APPROVED MIX DESIGN.
- FOUNDATIONS SHALL BE INSTALLED IN ACCORDANCE WITH MASSDOT STANDARD SPECIFICATIONS ITEM 945 - DRILLED SHAFTS
- REINFORCEMENT SHALL BE ASTM A615 GRADE 60.
- ANCHOR BOLTS SHALL BE SET BY TEMPLATE.
- PROVIDE FOR ELECTRICAL CONDUIT.
- EXCAVATION SHALL BE BY THE AUGER METHOD TO THE NEAT LINES OF THE OUTSIDE DIMENSION OF THE FOUNDATIONS WITHOUT DISTURBING THE SOIL AROUND AND BELOW THE PROPOSED FOUNDATION BOTTOM. ALTERNATE METHODS OF EXCAVATION MAY BE SUBMITTED TO MASSDOT FOR APPROVAL IF THEY MEET THE REQUIREMENTS LISTED IN NOTES 6, 7, AND 8.
- THE EARTH WALLS OF THE FOUNDATION SHALL BE ADEQUATELY AND SECURELY PROTECTED AT ALL TIMES AGAINST CAVE-INS, DISPLACEMENT OF THE SURROUNDING EARTH AND FOR THE EXCLUSION OF GROUND WATER. THIS MAY BE DONE BY THE USE OF STEEL CYLINDER LINERS OR CASINGS THAT ARE APPROVED BY MASSDOT. IF LINERS ARE USED THEY MAY BE RECLAIMED PROVIDED THAT THEY ARE WITHDRAWN AS THE CONCRETE IS BEING PLACED, MAINTAINING A SUFFICIENT HEAD OF CONCRETE WITHIN THE LINER TO PREVENT REDUCTION IN THE FOUNDATION DIAMETER AND TO PREVENT EXTRANEOUS MATERIAL FROM FALLING IN FROM THE SIDES AND MIXING WITH THE CONCRETE.
- IF THE SOIL IS DISTURBED OR REMOVED BEYOND THE NEAT LINES OF THE OUTSIDE DIMENSION OF THE FOUNDATION, IT SHALL BE REPLACED WITH CONCRETE. ANY ADDITIONAL COST FOR THE CONCRETE SHALL BE PAID FOR BY THE CONTRACTOR.
- SPECIAL CARE SHOULD BE GIVEN TO AREAS WHERE WET SOIL IS ENCOUNTERED, TO INSURE THAT THE PREAUGERED HOLE DOES NOT COLLAPSE. THIS MAY REQUIRE THE USE OF STEEL CYLINDER LINERS OR CASINGS TO HOLD THE SOIL IN PLACE UNTIL READY FOR CONCRETE PLACEMENT, UPON APPROVAL FROM THE MASSDOT. THE STEEL CYLINDERS OR CASINGS SHALL BE WITHDRAWN AS THE FOUNDATION CONCRETE IS PLACED.
- IF LEDGE OR UNSUITABLE SOIL IS ENCOUNTERED (I.E. ONE WHICH DOES NOT APPLY TO THE DESIGN TABLES SHOWN ON THIS SHEET), AN ALTERNATIVE DESIGN SHALL BE PROVIDED BY THE DESIGN ENGINEER. IF UTILITIES OR OTHER UNDERGROUND OBSTRUCTIONS ARE ENCOUNTERED, THE CONTRACTOR SHALL BACKFILL THE AREA TO ITS ORIGINAL CONDITION UNTIL AN ALTERNATE DESIGN HAS BEEN PROVIDED BY THE DESIGN ENGINEER AND APPROVED BY MASSDOT. SPECIAL FOUNDATIONS SHALL BE DESIGNED IN ACCORDANCE WITH BASIS OF DESIGN TABLE ABOVE.
- A GALVANIZED WIRE MESH SHALL BE INSTALLED AT BASE OF POLE. SCREEN SHALL BE PRESS-FORMED OF 3 OR 4 MESH, 21 GAGE OR HEAVIER, STAINLESS STEEL OR HOT DIPPED GALVANIZED WIRE SCREEN OR APPROVED EQUIVALENT. SCREEN SHALL BE SCREWED INTO POLE BASE PLATE, AND SHALL BE FLUSH WITH THE TOP OF THE PIER FOUNDATION.
- SANDY SOILS WITH STANDARD PENETRATION VALUES GREATER THAN 20 BLOWS PER FOOT SHALL BE CLASSIFIED AS DENSE DRY SAND AND DENSE WET SAND. SANDY SOILS WITH STANDARD PENETRATION VALUES RANGING FROM 6 TO 20 BLOWS PER FOOT SHALL BE CLASSIFIED LOOSE DRY SAND AND LOOSE WET SAND. SANDY SOILS WITH FEWER THAN 6 BLOWS PER FOOT SHALL REQUIRE SPECIAL FOUNDATION DESIGNS BY THE DESIGN ENGINEER AND APPROVED BY MASSDOT. SPECIAL FOUNDATIONS SHALL BE DESIGNED IN ACCORDANCE WITH BASIS OF DESIGN TABLE ABOVE.
- CLAYS WITH STANDARD PENETRATION VALUES GREATER THAN 6 BLOWS PER FOOT SHALL BE CLASSIFIED AS STIFF CLAY. CLAYS WITH STANDARD PENETRATION VALUES RANGING FROM 2 TO 6 BLOWS PER FOOT SHALL BE CLASSIFIED AS SOFT TO MEDIUM STIFF CLAY. CLAYS WITH FEWER THAN 2 BLOWS PER FOOT SHALL REQUIRE SPECIAL FOUNDATION DESIGNS BY THE DESIGN ENGINEER AND APPROVED BY MASSDOT. SPECIAL FOUNDATIONS SHALL BE DESIGNED IN ACCORDANCE WITH BASIS OF DESIGN TABLE ABOVE.
- A SANDY SOIL SHALL ONLY BE CLASSIFIED AS 'DRY' IF THE ENTIRE DRY SAND SHAFT LENGTH SITS ABOVE WET SOILS ACCORDING TO THE BORING LOGS. IF ANY PART OF THE SHAFT LENGTH IS CAST AT OR BELOW THE GROUNDWATER LEVEL, THE SOIL SHALL BE CLASSIFIED AS 'WET'.
- WHERE THE PREDOMINATING SOIL TYPE IS INORGANIC SILT, THE SOIL SHOULD BE TREATED AS CLAY OR WET LOOSE SAND, WHICHEVER LEADS TO A MORE CONSERVATIVE FOUNDATION. INORGANIC SILTS WITH STANDARD PENETRATION N-VALUES LESS THAN 2 BLOWS PER FOOT, ORGANIC SILTS, AND PEAT SHALL REQUIRE SPECIAL FOUNDATION DESIGNS BY THE DESIGN ENGINEER AND APPROVED BY MASSDOT. SPECIAL FOUNDATIONS SHALL BE DESIGNED IN ACCORDANCE WITH BASIS OF DESIGN TABLE ABOVE.
- WHERE FILL CONTAINS CLAY OR SILT, IT SHOULD BE TREATED AS SOFT CLAY.
- MAST ARM FOUNDATIONS ARE DESIGNED TO SUPPORT MAST ARMS WITH OR WITHOUT OPTIONAL LUMINAIRE.
- CONTRACTOR SHALL BE RESPONSIBLE FOR ENSURING THAT FOUNDATION DIAMETER IS AT LEAST 17.5" GREATER THAN BOLT CIRCLE DIAMETER FOR ALL STRUCTURES
- IN ORDER TO CREATE A FLUSH SURFACE, CONTRACTOR SHALL REFER TO THE FINAL ELEVATIONS SHOWN ON THE DESIGN PLANS WHEN INSTALLING FOUNDATIONS IMMEDIATELY ADJACENT TO OR WITHIN A SIDEWALK AREA.

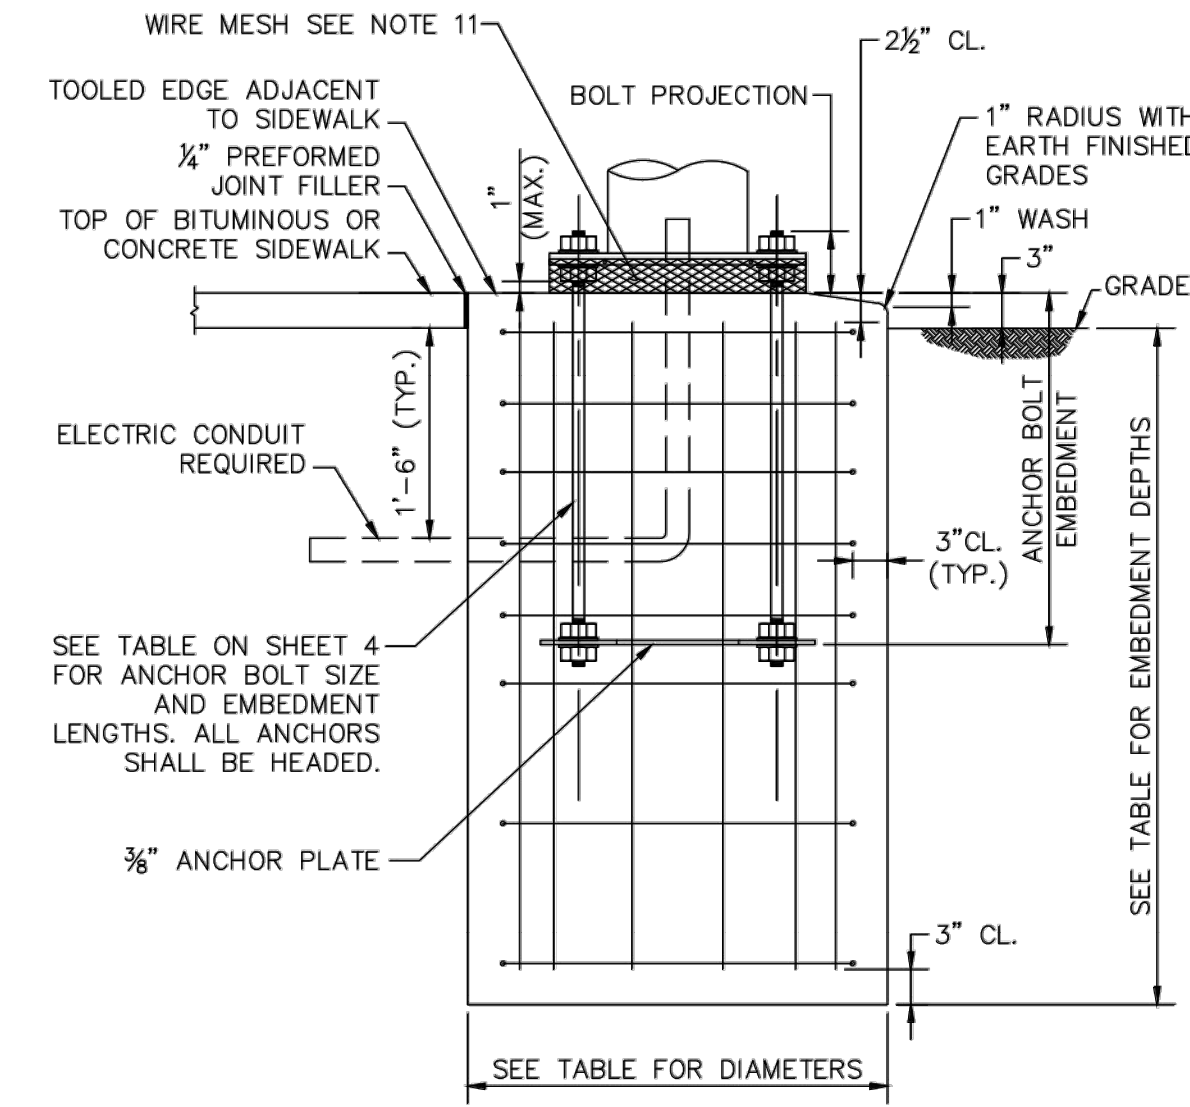

PIER FOUNDATION DETAIL
NO SCALE

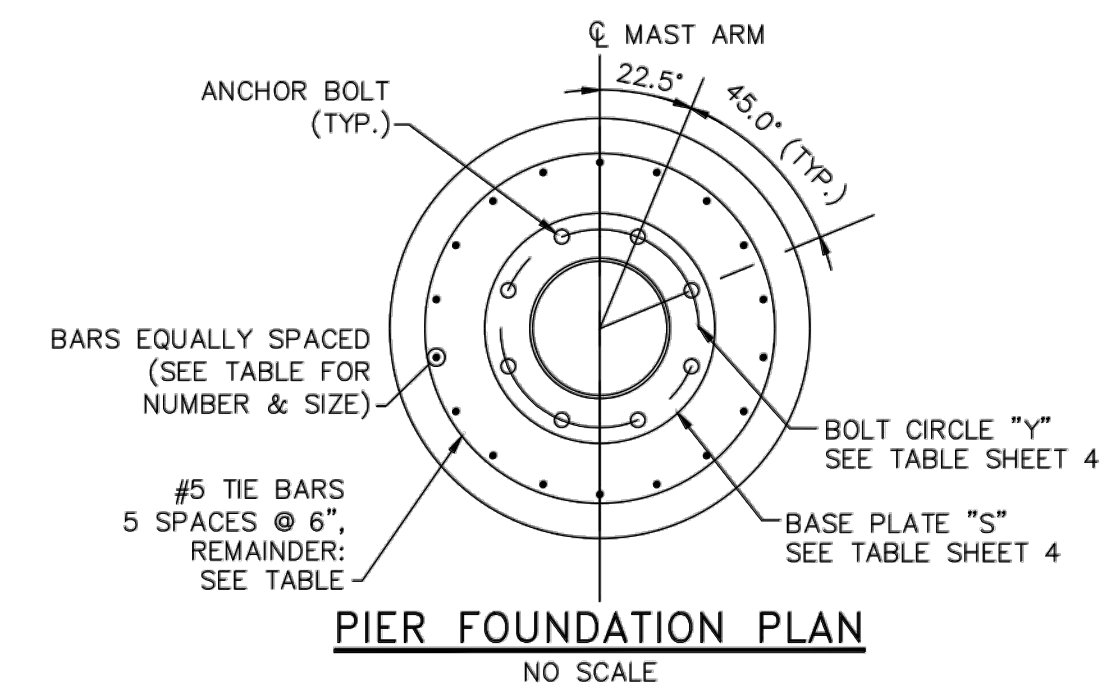

PIER FOUNDATION PLAN
NO SCALE


STANDARD DRAWINGS
 OVERHEAD SIGNAL STRUCTURE & FOUNDATION
 MAST ARM CORED PIER FOUNDATIONS
 MASSACHUSETTS DEPARTMENT OF TRANSPORTATION
 HIGHWAY DIVISION
 10 PARK PLAZA BOSTON, MASS
 DECEMBER, 2015

NOTE:

DETAILS FROM MASSDOT STANDARD DRAWINGS (2015)

PROJECT: **MINUTEMAN BIKEWAY IMPROVEMENTS AT LAKE STREET**

DESIGN SUBMISSION: **DRAFT FINAL DESIGN**



DRAWING TITLE: **TRAFFIC SIGNAL DETAILS 4**

PREPARED FOR:
 **TOWN OF ARLINGTON**
 ENGINEERING DIVISION
 51 GROVE STREET
 ARLINGTON, MA 02476

PREPARED BY:
 **GREEN INTERNATIONAL AFFILIATES, INC.**
 Civil and Structural Engineers (978) 923-0400
 Westford, Massachusetts GreenIntl.com

SCALE: AS NOTED	DESIGNED BY: JG	SHEET NO. 16 OF 26
DATE: 09/15/2017	DRAWN BY: JG	
PROJECT NO. 17067.015	CHECKED BY: JS	

LIGHTING DESIGN SERVICES LUMEN STUDIO, INC.	
ELETRICAL WIRING DESIGN SERVICES ENGINEERING ADVANTAGE, INC.	
NO.	DATE
REVISIONS	

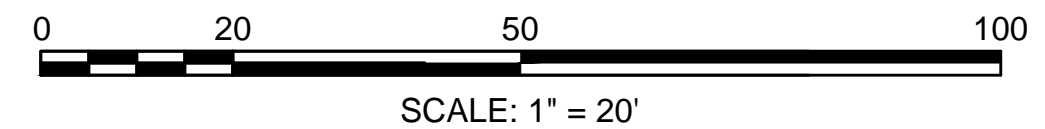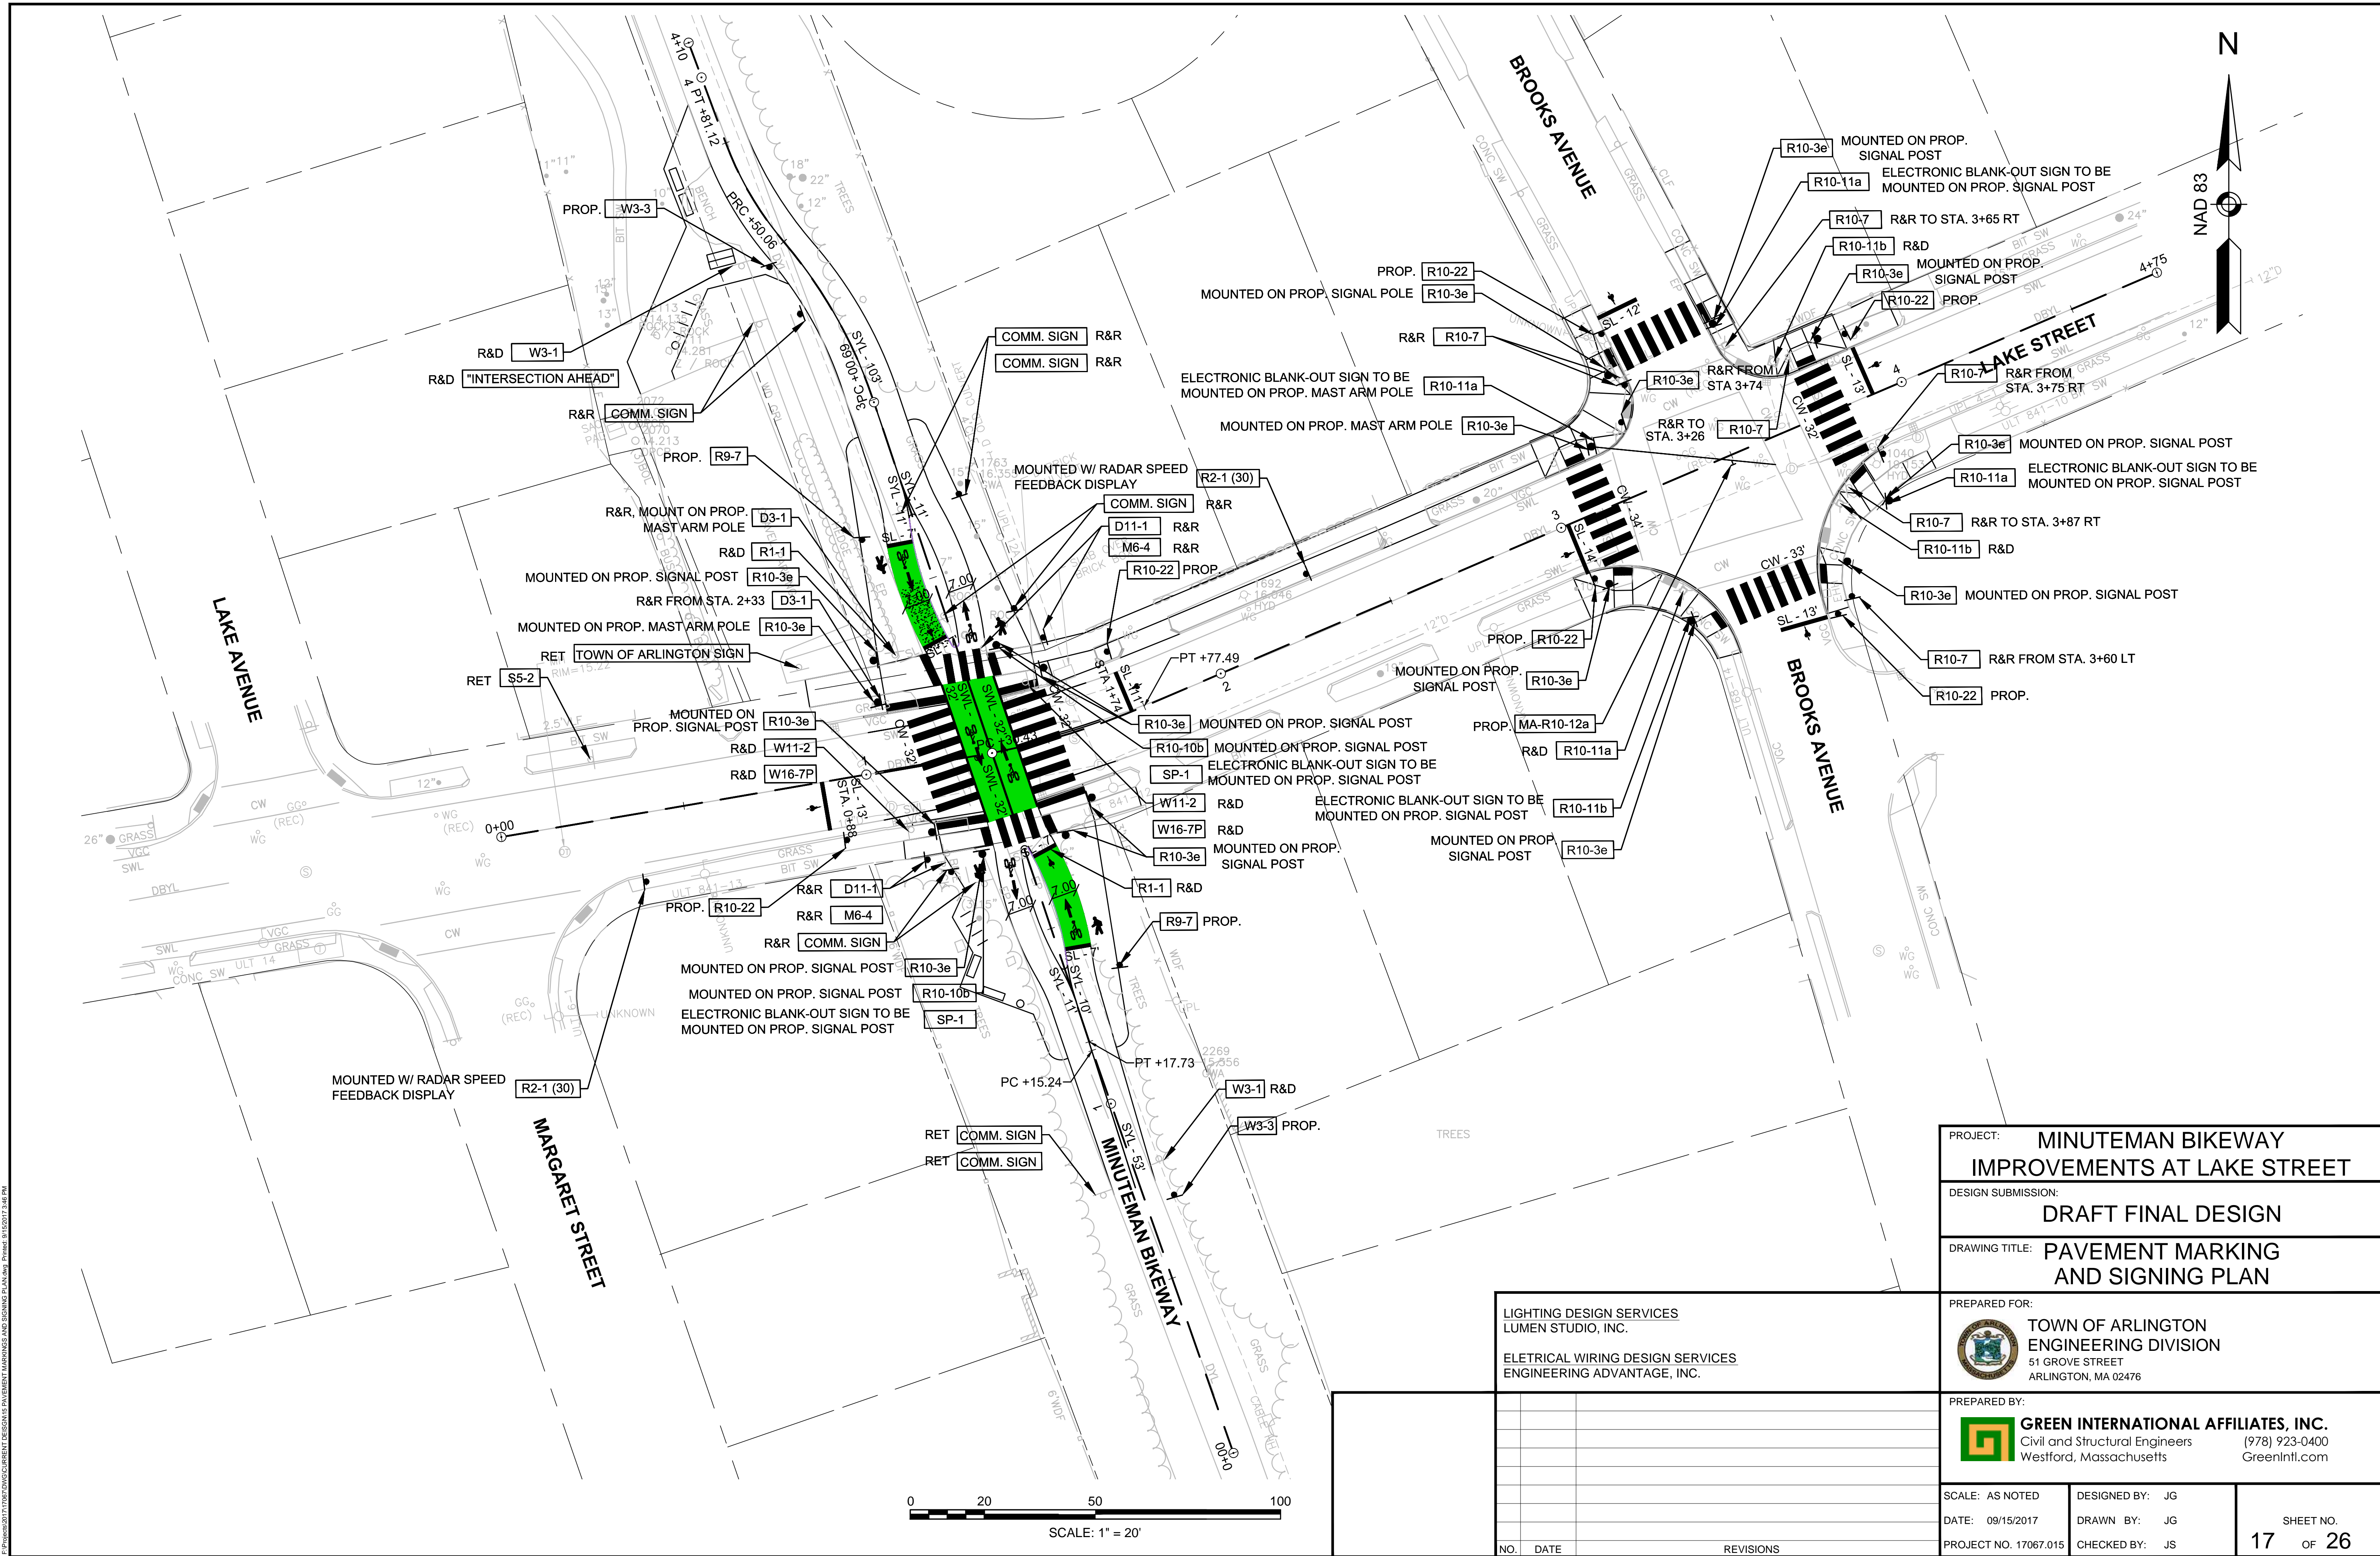

PROJECT: **MINUTEMAN BIKEWAY IMPROVEMENTS AT LAKE STREET**

DESIGN SUBMISSION: **DRAFT FINAL DESIGN**

DRAWING TITLE: **PAVEMENT MARKING AND SIGNING PLAN**

LIGHTING DESIGN SERVICES
LUMEN STUDIO, INC.

ELECTRICAL WIRING DESIGN SERVICES
ENGINEERING ADVANTAGE, INC.

PREPARED FOR:

TOWN OF ARLINGTON
 ENGINEERING DIVISION
 51 GROVE STREET
 ARLINGTON, MA 02476

PREPARED BY:






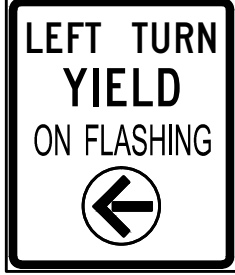
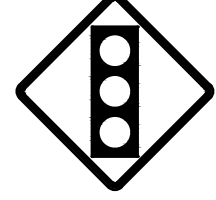
GREEN INTERNATIONAL AFFILIATES, INC.
 Civil and Structural Engineers (978) 923-0400
 Westford, Massachusetts GreenIntl.com

SCALE: AS NOTED	DESIGNED BY: JG	SHEET NO. 17 OF 26
DATE: 09/15/2017	DRAWN BY: JG	
PROJECT NO. 17067.015	CHECKED BY: JS	

NO.	DATE	REVISIONS

6/15/2017 10:15:00 AM C:\PROJECTS\17067\17067.DWG PLOT DATE: 9/15/2017 2:46 PM

TRAFFIC SIGN SUMMARY

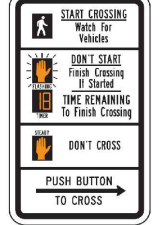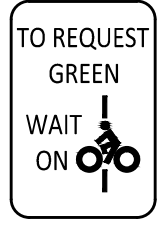IDENTIFICATION NUMBER	SIZE OF SIGN		TEXT	TEXT DIMENSIONS (INCHES)			NUMBER OF SIGNS REQUIRED	COLOR			POST SIZE AND NO. REQ'D.	UNIT AREA IN SQUARE FEET	TOTAL AREA IN SQUARE FEET
	WIDTH	HEIGHT		LETTER HEIGHT	VERTICAL SPACING	ARROW RTE. MKR.		BACK-GROUND	LEGEND	BORDER			
R2-1*	24"	30"		SEE MUTCD STANDARDS			2	SEE MUTCD STANDARDS			P5 0**	5.00	10.00*
R9-7	12"	18"					2				P5 2	1.50	3.00
R10-3e	9"	15"					16				P5 0 MOUNTED OVER PUSH-BUTTONS	0.94	15.04
R10-22	12"	18"					6				P5 6	1.50	9.00
R10-10b	12"	18"		SEE MUTCD INTERIM APPROVAL FOR OPTIONAL USE OF A BICYCLE SIGNAL FACE (IA-16)			2	SEE MUTCD INTERIM APPROVAL FOR OPTIONAL USE OF A BICYCLE SIGNAL FACE (IA-16)			P5 0 MOUNTED ON PROP. SIGNAL POSTS	3.00	6.00
MA-R10-12a	30"	36"		SEE MASSDOT STANDARD SIGNS			1	WHITE	BLACK / YELLOW	BLACK	P5 0 MOUNTED ON MAST ARM	7.50	7.50
W3-3	18"	18"		SEE MUTCD STANDARDS			2	SEE MUTCD STANDARDS			P5 2	2.25	4.50
												45.04	


NOTES:

SEE THE 2009 "MANUAL ON UNIFORM TRAFFIC CONTROL DEVICES" (MUTCD) AND ITS REVISIONS, THE 2012 MASSACHUSETTS AMENDMENTS TO THE 2009 MUTCD, AND THE STANDARD MUNICIPAL TRAFFIC CODE FOR LATEST SPECIFICATION ON TEXT, DIMENSIONS AND COLOR. ALSO REFER TO 2015 MASSACHUSETTS DEPARTMENT OF TRANSPORTATION (MASSDOT) SUPPLEMENTAL SPECIFICATIONS.

ELECTRONIC BLANK-OUT SIGN TO BE INCLUDED IN COST OF OUTDOOR BLANK-OUT LED DIRECT-VIEW SIGNS

*R2-1 SIGNS TO BE INCLUDED IN COST OF RADAR SPEED FEEDBACK DISPLAY SIGN ASSEMBLY

ELECTRONIC BLANK-OUT SIGNS

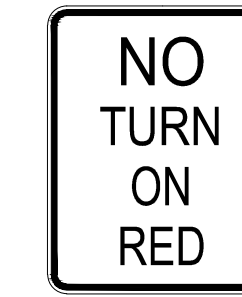

R10-11a




SP-1

NOTES:


ELECTRONIC BLANK-OUT SIGN TO BE INCLUDED IN COST OF SPECIAL PROVISION ITEM 815.11.

SEE SPECIAL PROVISION ITEM 815.11 FOR ELECTRONIC BLANK-OUT SIGN SPECIFICATIONS.

PEDESTRIAN CROSSWALK DETAIL LAKE STREET AT MINUTEMAN BIKEWAY

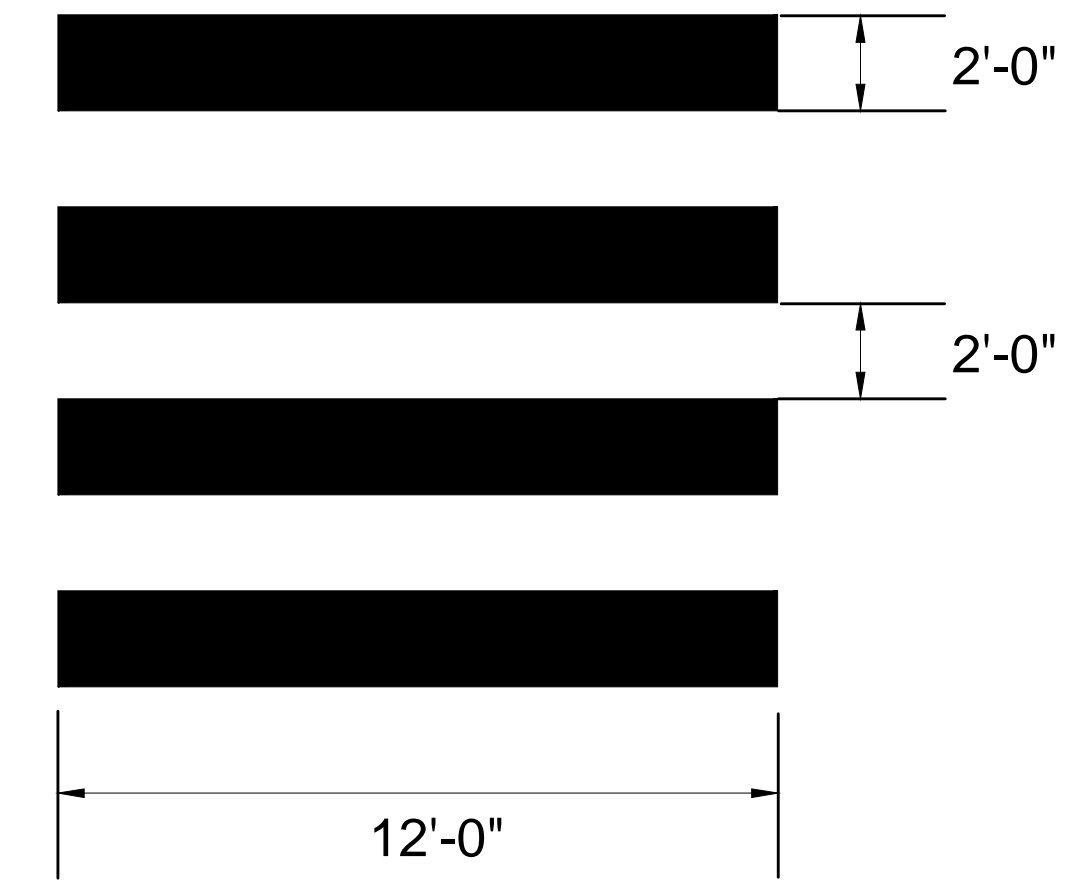

PEDESTRIAN CROSSWALK DETAIL LAKE STREET AT BROOKS AVENUE

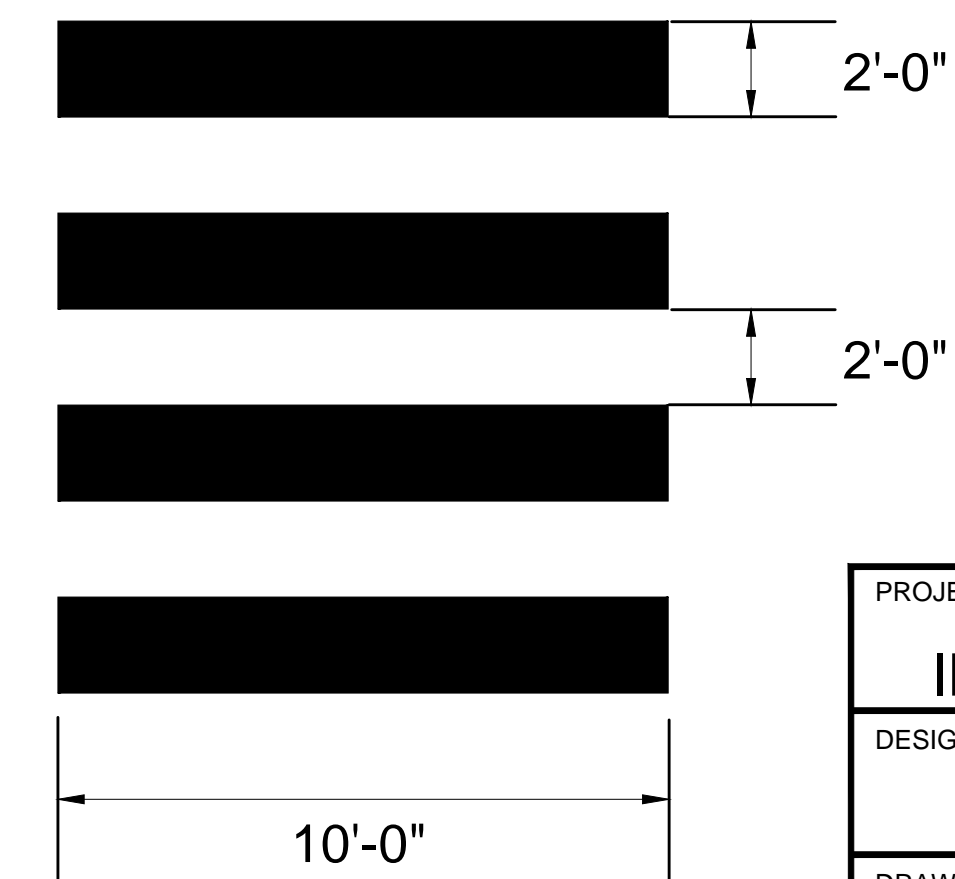


PROJECT: MINUTEMAN BIKEWAY IMPROVEMENTS AT LAKE STREET	
DESIGN SUBMISSION: DRAFT FINAL DESIGN	
DRAWING TITLE: TRAFFIC SIGN SUMMARY	
PREPARED FOR:  TOWN OF ARLINGTON ENGINEERING DIVISION 51 GROVE STREET ARLINGTON, MA 02476	
PREPARED BY:  GREEN INTERNATIONAL AFFILIATES, INC. Civil and Structural Engineers (978) 923-0400 Westford, Massachusetts GreenIntl.com	
SCALE: AS NOTED	DESIGNED BY: JG
DATE: 09/15/2017	DRAWN BY: JG
PROJECT NO. 17067.015	CHECKED BY: JS
SHEET NO. 18 OF 26	


LIGHTING DESIGN SERVICES
LUMEN STUDIO, INC.

ELECTRICAL WIRING DESIGN SERVICES
ENGINEERING ADVANTAGE, INC.

NO.	DATE	REVISIONS

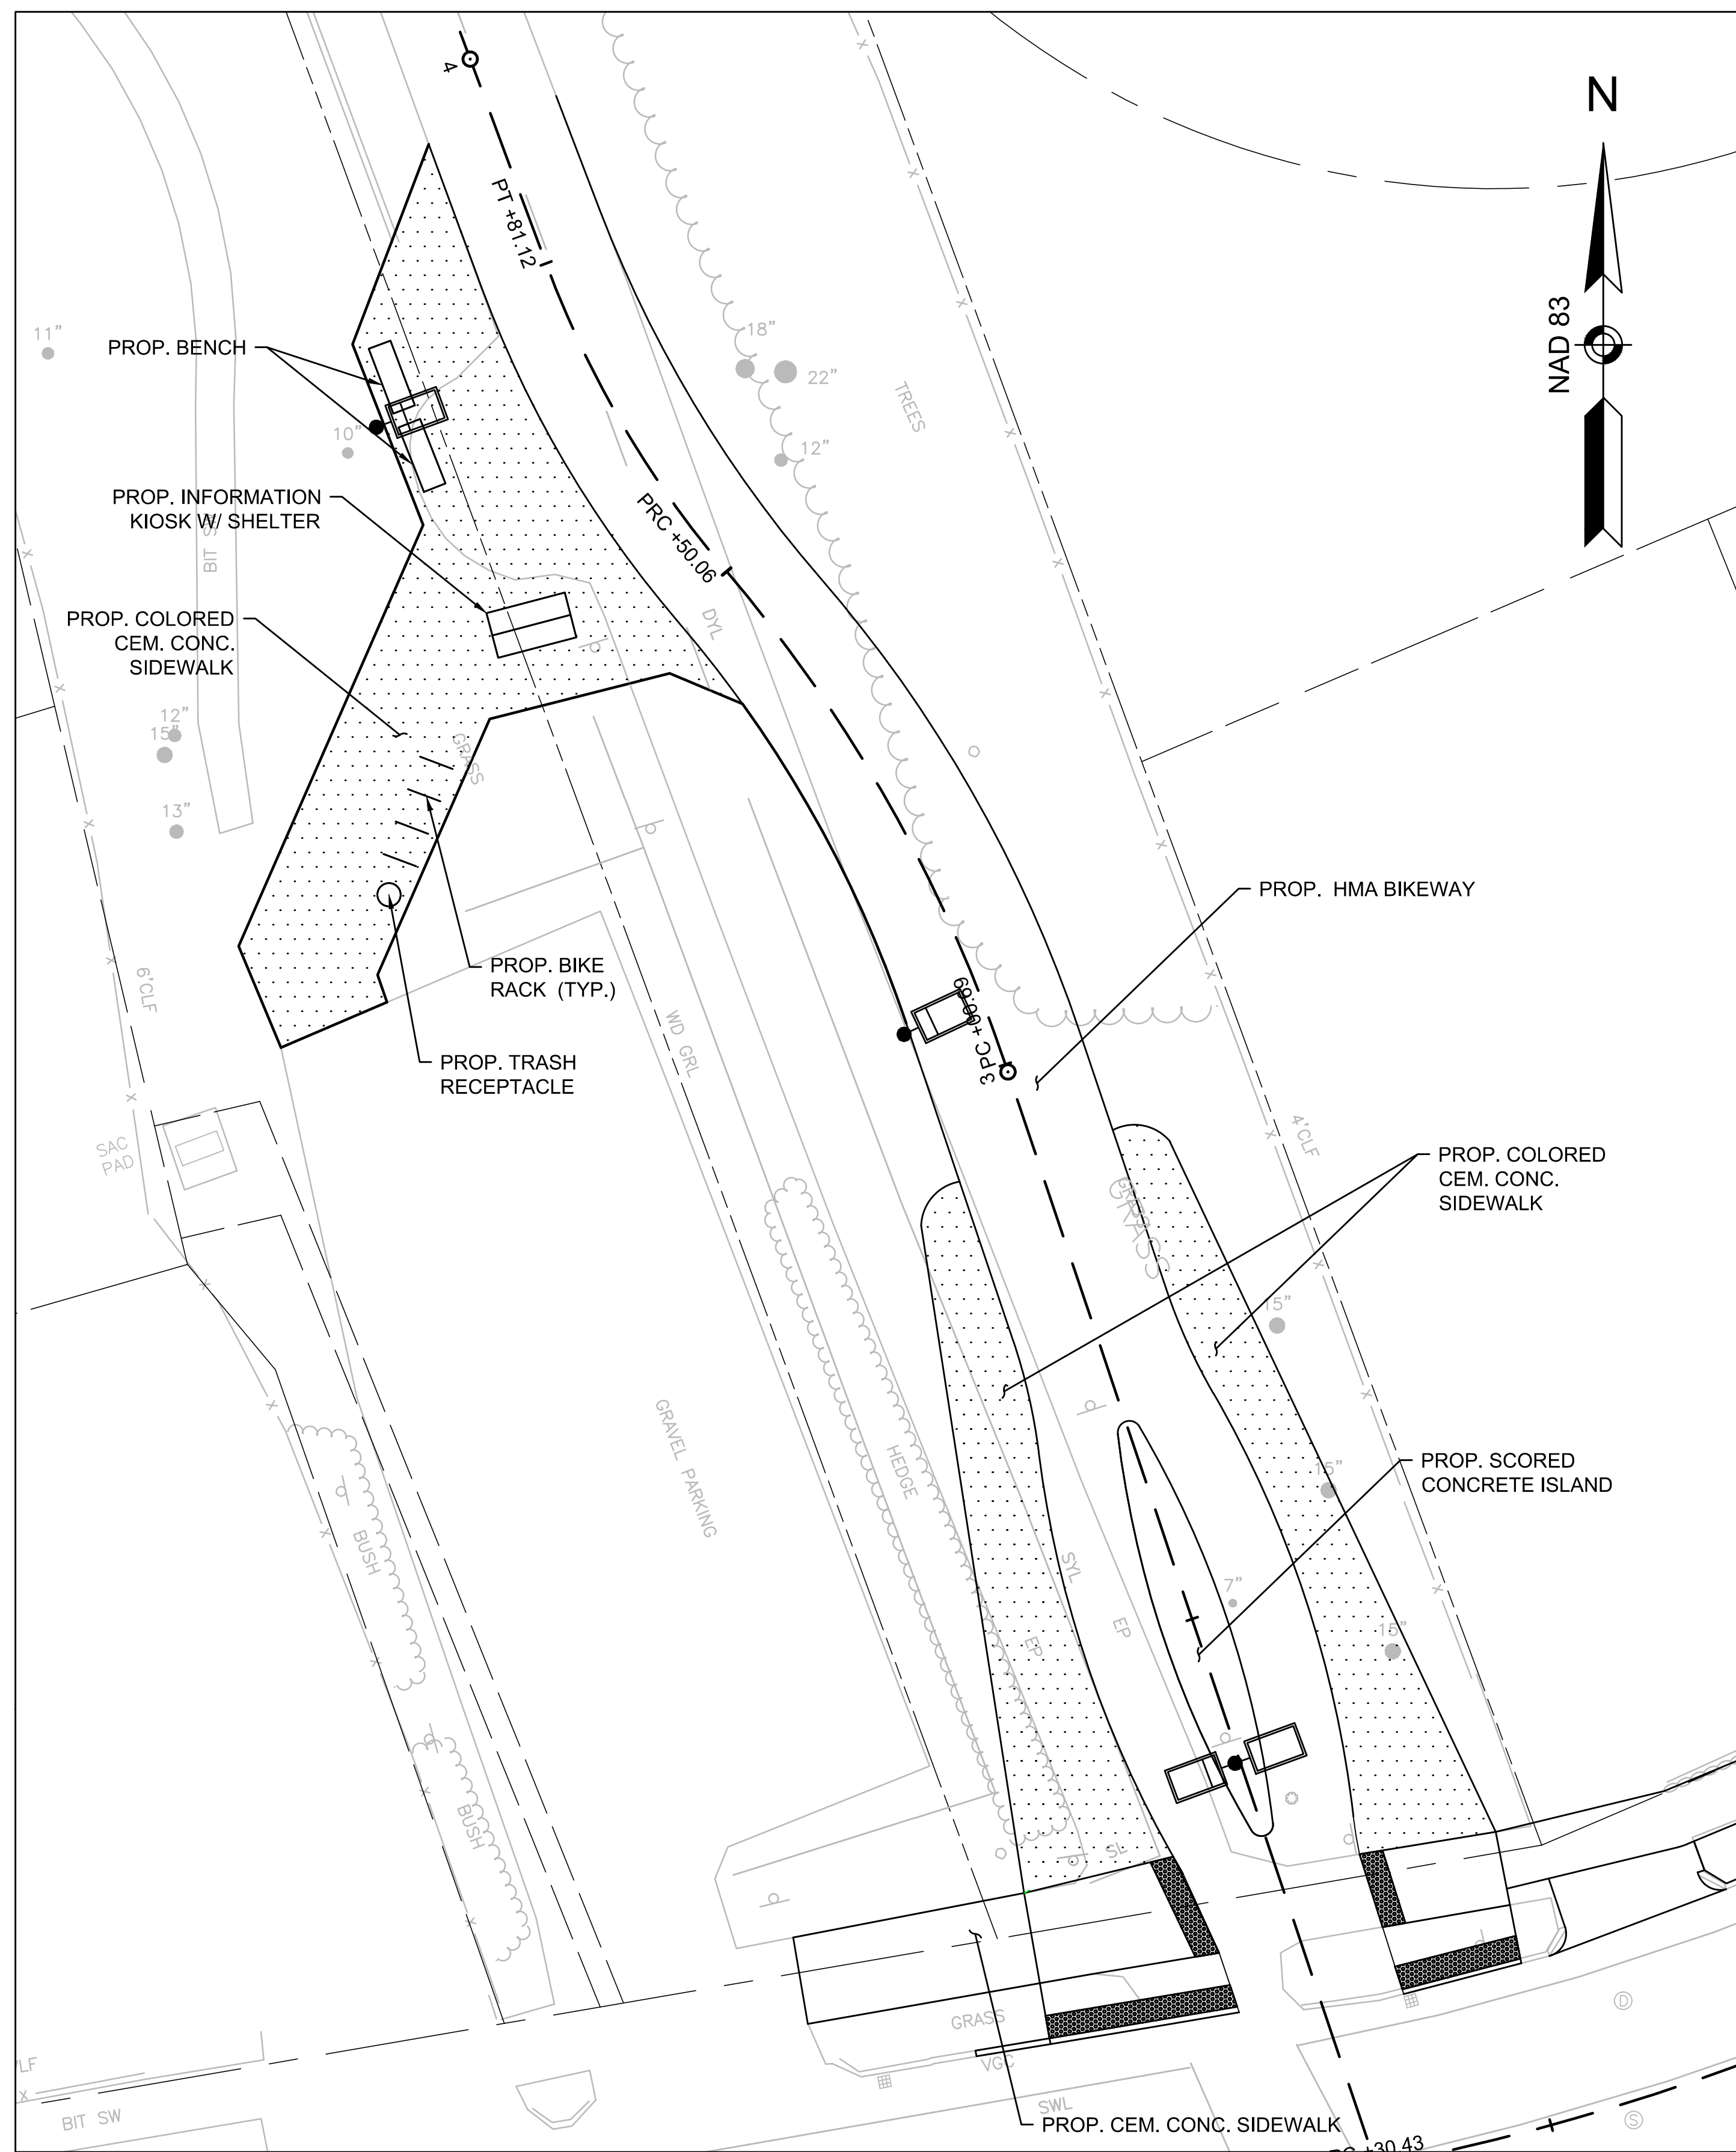

1 MATERIALS AND LAYOUT PLAN NORTH OF LAKE STREET

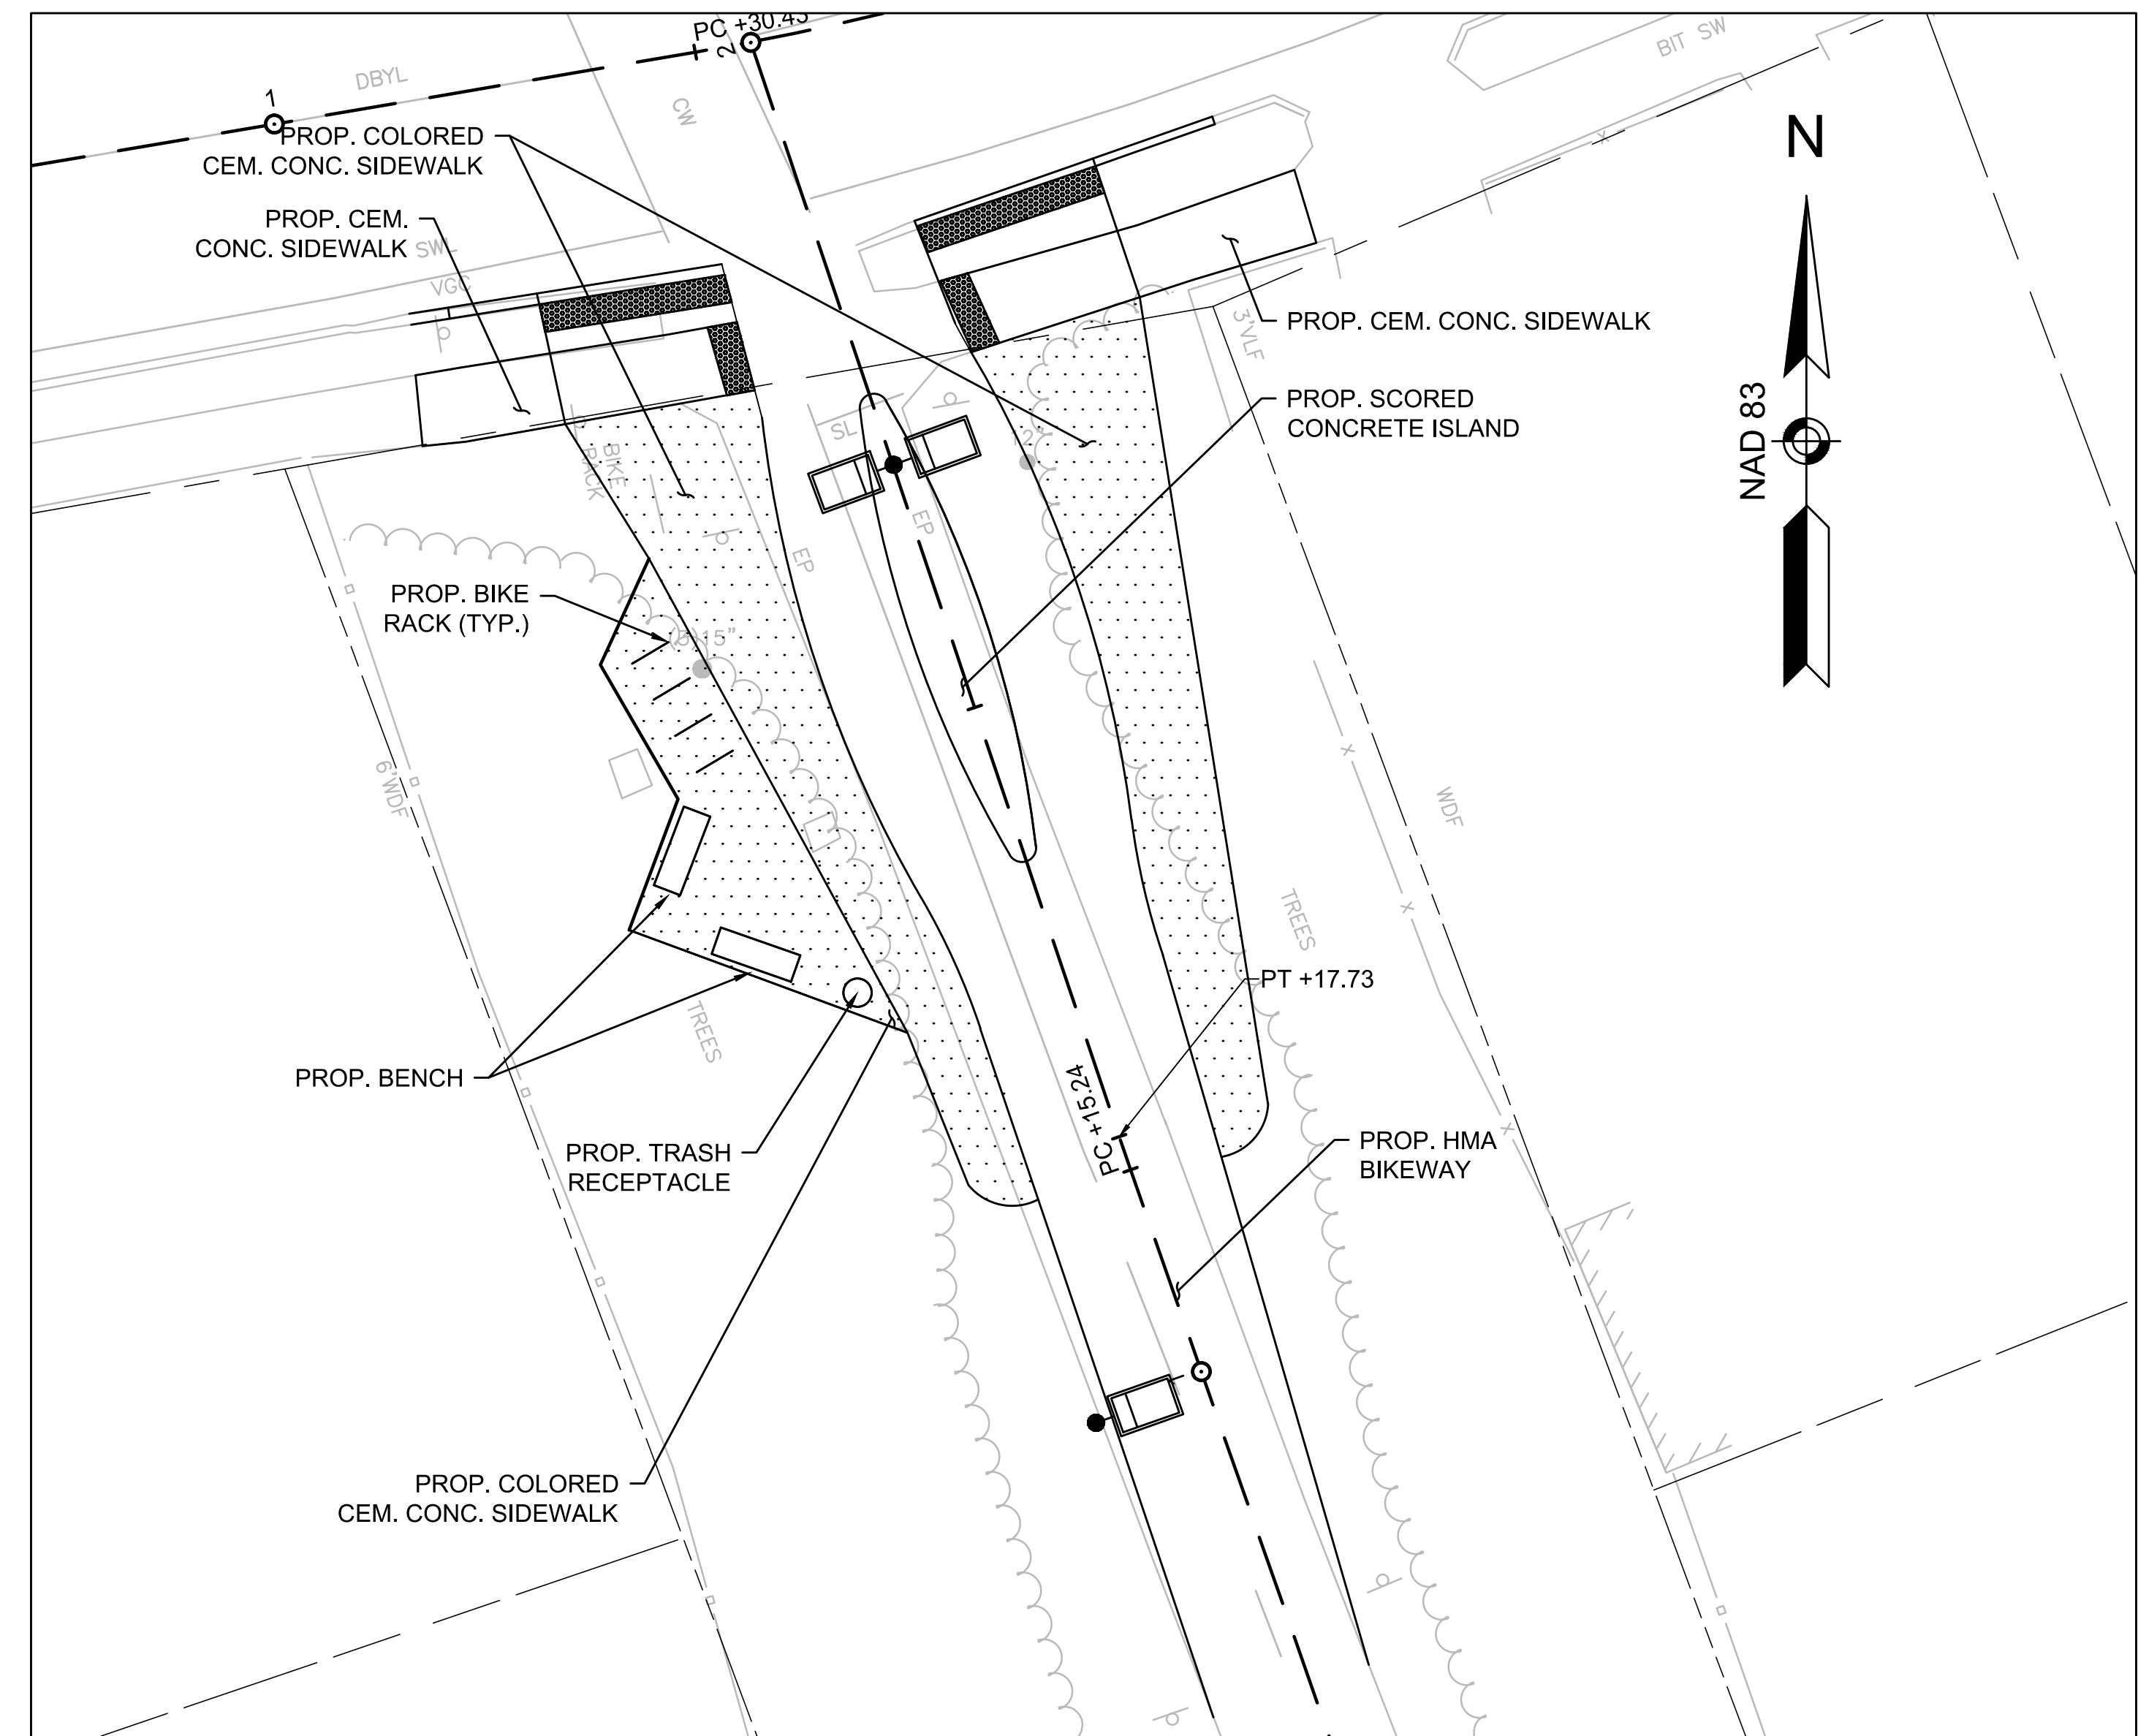

2 MATERIALS AND LAYOUT PLAN SOUTH OF LAKE STREET

P:\Projects\2017\CONCURRENT\DESIGN\LANDSCAPE\PLAN\16.dwg, Revised: 01/15/2017 2:22 PM

LIGHTING DESIGN SERVICES
LUMEN STUDIO, INC.
ELECTRICAL WIRING DESIGN SERVICES
ENGINEERING ADVANTAGE, INC.


PROJECT: **MINUTEMAN BIKEWAY IMPROVEMENTS AT LAKE STREET**
DESIGN SUBMISSION: **DRAFT FINAL DESIGN**
DRAWING TITLE: **LANDSCAPE MATERIALS AND LAYOUT PLAN**

PREPARED FOR:
 **TOWN OF ARLINGTON**
ENGINEERING DIVISION
51 GROVE STREET
ARLINGTON, MA 02476


PREPARED BY:
 **GREEN INTERNATIONAL AFFILIATES, INC.**
Civil and Structural Engineers (978) 923-0400
Westford, Massachusetts GreenIntl.com

SCALE: AS NOTED	DESIGNED BY: JG	SHEET NO. 19 OF 26
DATE: 09/15/2017	DRAWN BY: JG	
PROJECT NO. 17067.015	CHECKED BY: JS	

NO.	DATE	REVISIONS

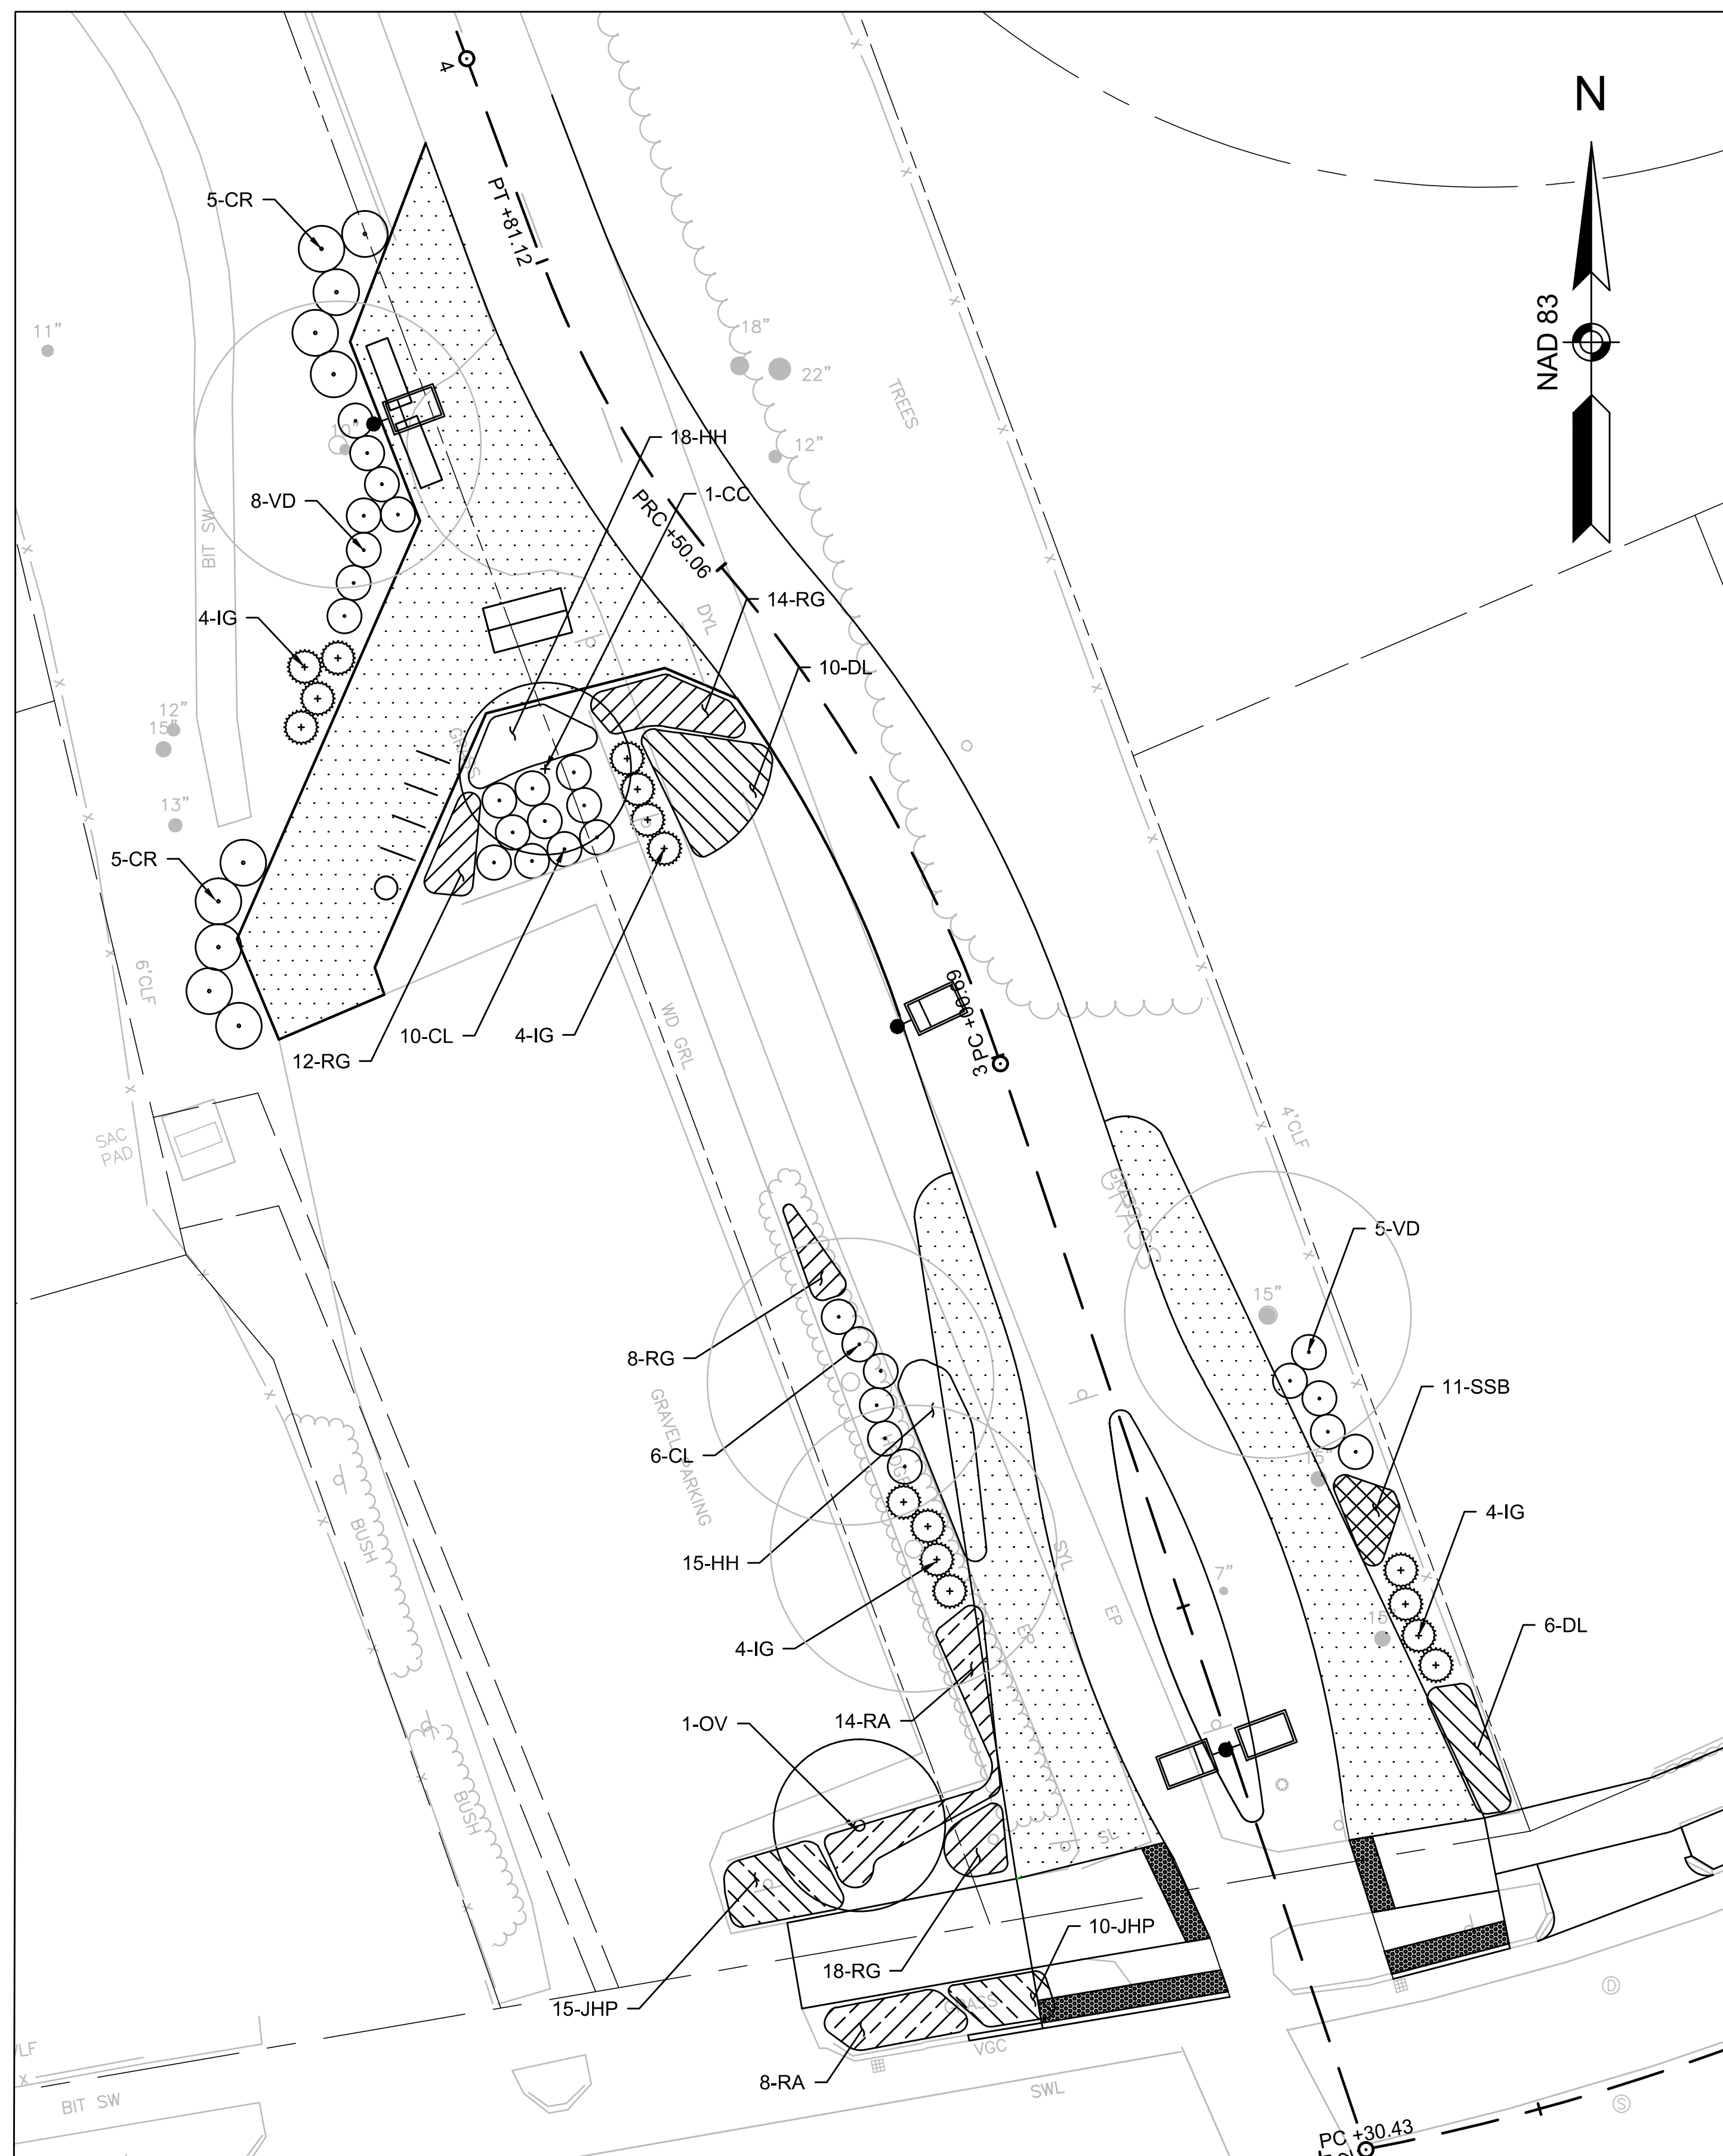


1 PLANTING PLAN NORTH OF LAKE STREET

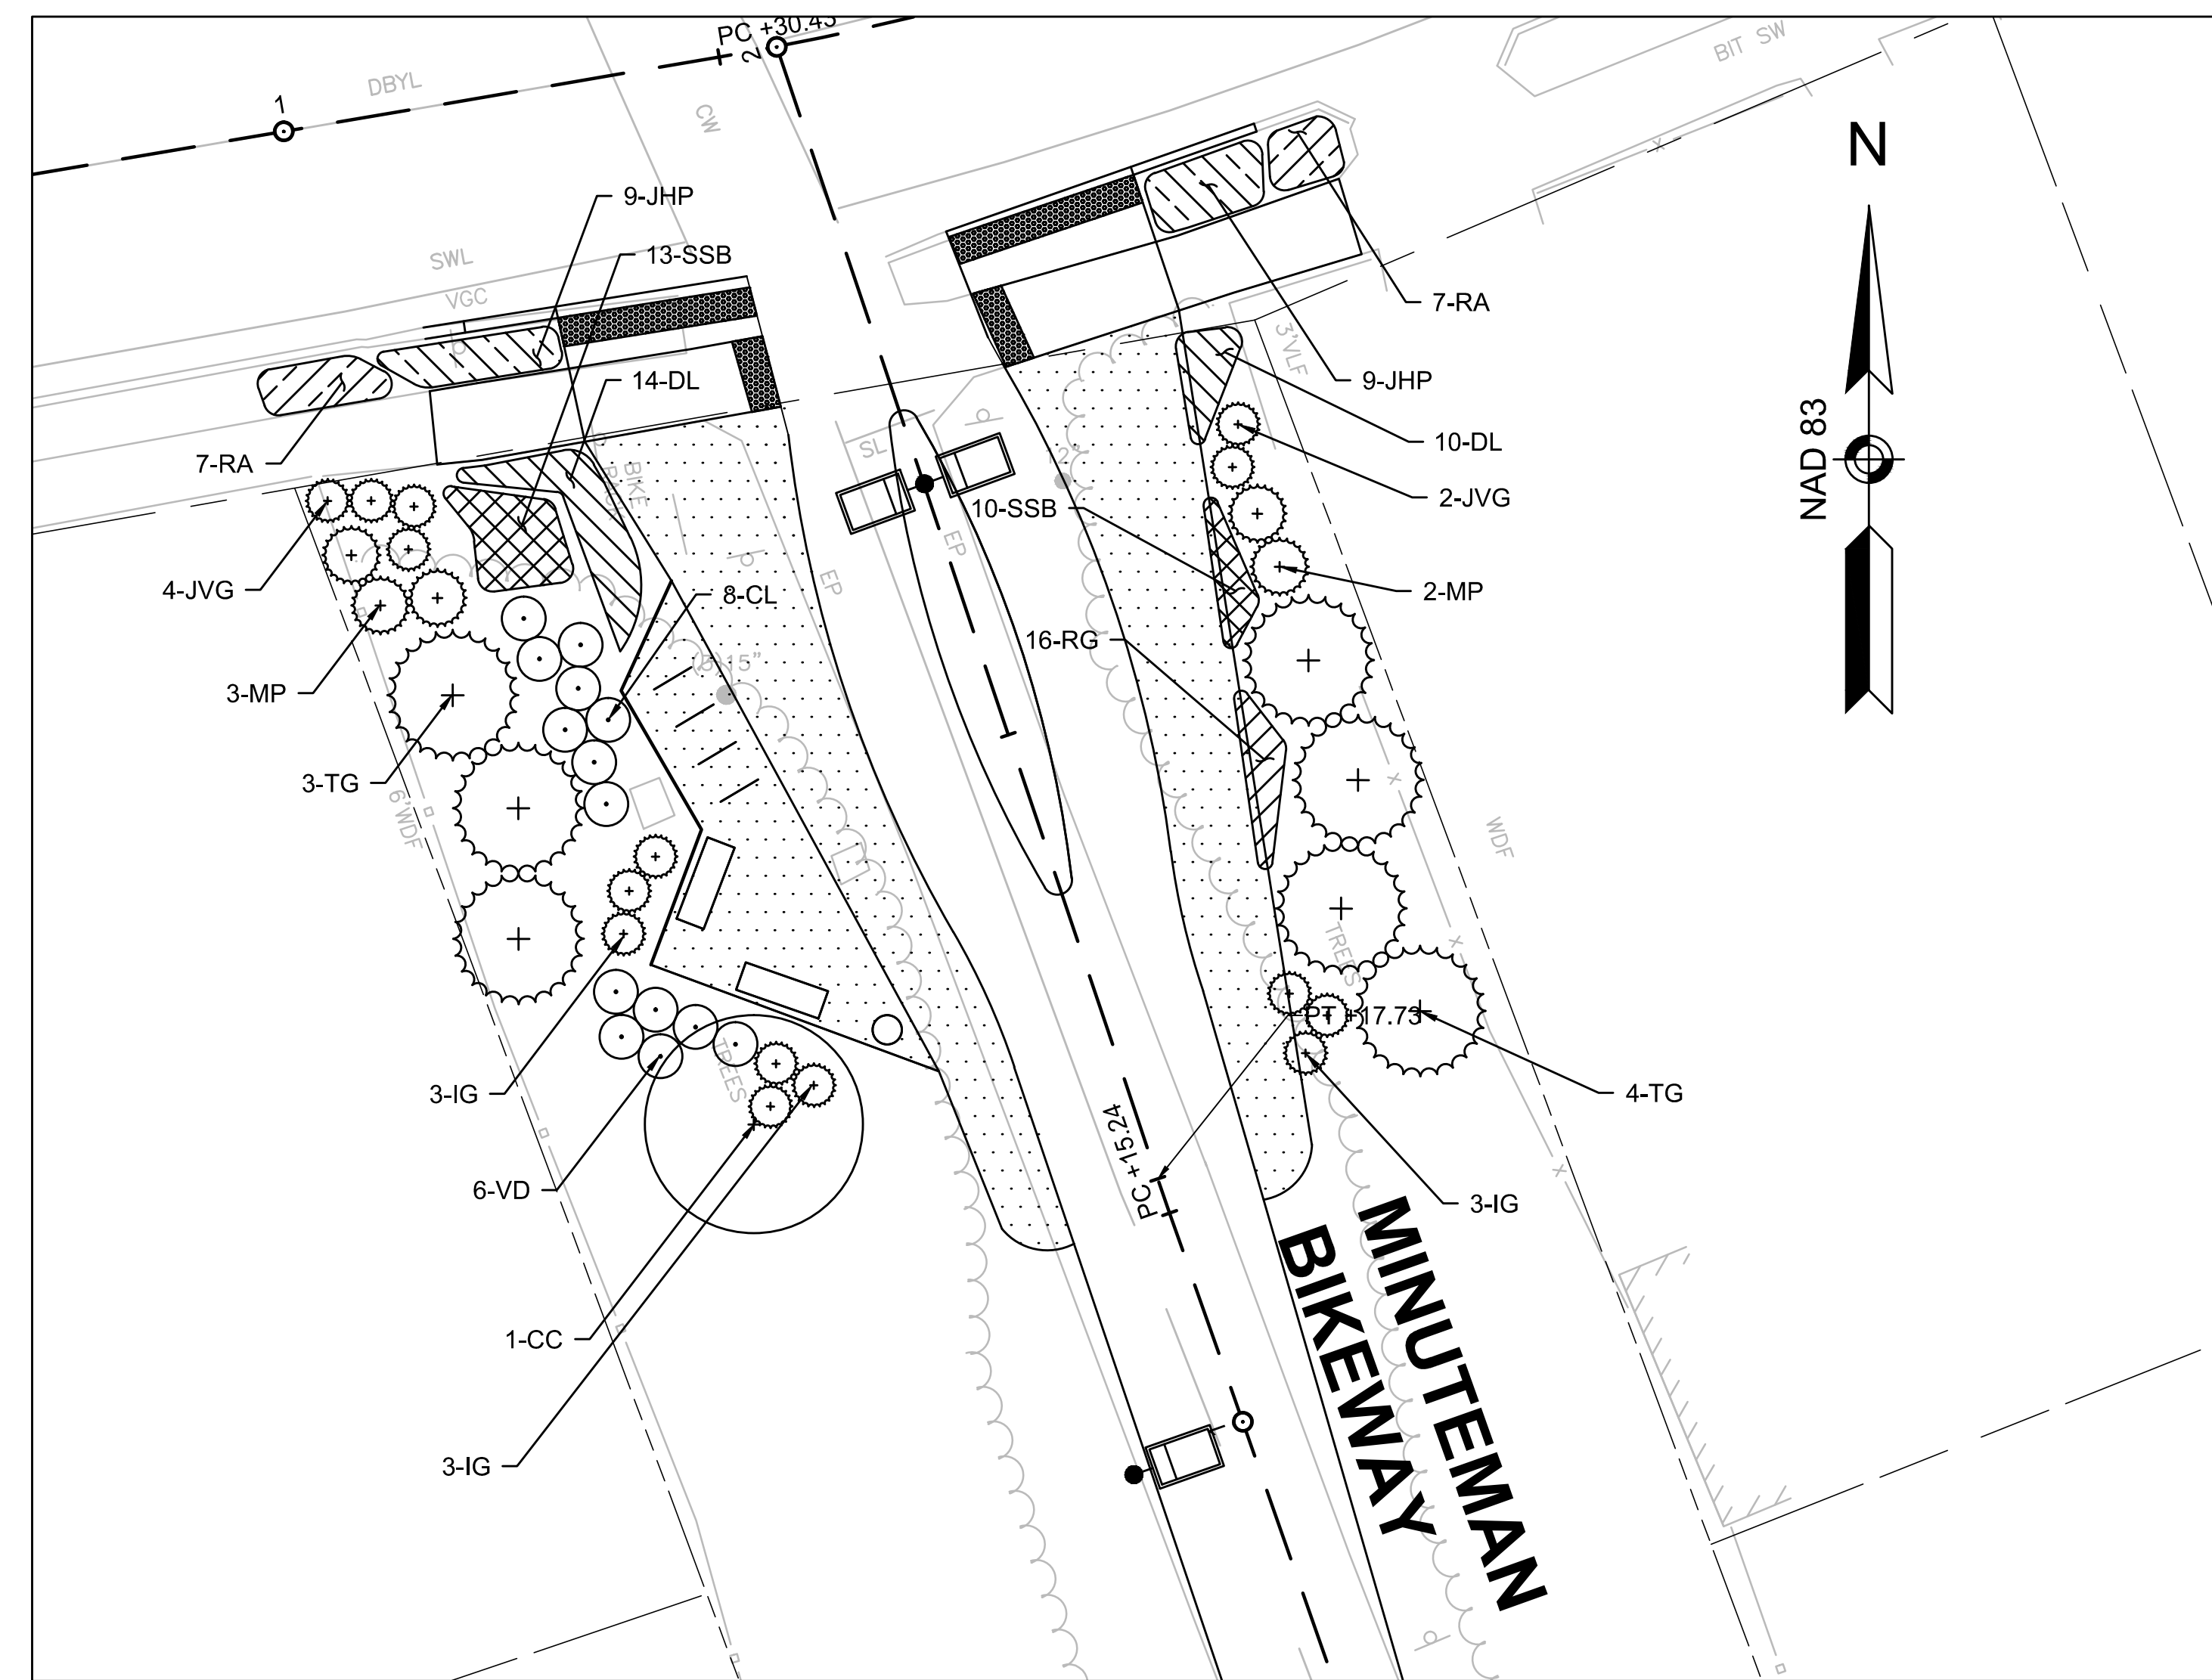

1 PLANTING PLAN SOUTH OF LAKE STREET

NOTES:

1. SEE SHEET 21 FOR PLANT LIST.
2. LOCATION OF PLANT MATERIAL SHALL BE APPROVED IN THE FIELD BY THE LANDSCAPE ARCHITECT PRIOR TO INSTALLATION.

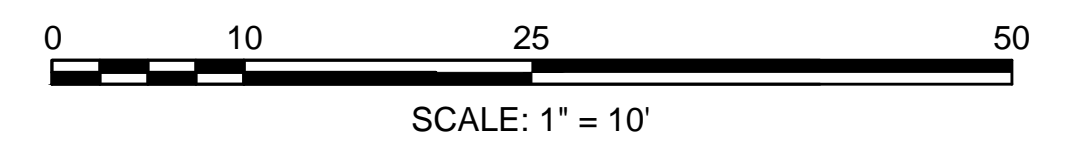

LIGHTING DESIGN SERVICES
LUMEN STUDIO, INC.
ELECTRICAL WIRING DESIGN SERVICES
ENGINEERING ADVANTAGE, INC.

PROJECT: MINUTEMAN BIKEWAY
IMPROVEMENTS AT LAKE STREET

DESIGN SUBMISSION:
DRAFT FINAL DESIGN

DRAWING TITLE:
LANDSCAPE PLANTING PLAN

PREPARED FOR:
TOWN OF ARLINGTON
ENGINEERING DIVISION
51 GROVE STREET
ARLINGTON, MA 02476


PREPARED BY:
GREEN INTERNATIONAL AFFILIATES, INC.
Civil and Structural Engineers (978) 923-0400
Westford, Massachusetts GreenIntl.com

SCALE: AS NOTED	DESIGNED BY: JG	SHEET NO. 20 OF 26
DATE: 09/15/2017	DRAWN BY: JG	
PROJECT NO. 17067.015	CHECKED BY: JS	

NO. DATE REVISIONS


NOTE:

1. CONCRETE PAD BENEATH BENCHES AND GAME TABLES TO BE 6" THICK. SEE DETAIL #1 ON SHEET C-6 FOR JOINT DETAIL.

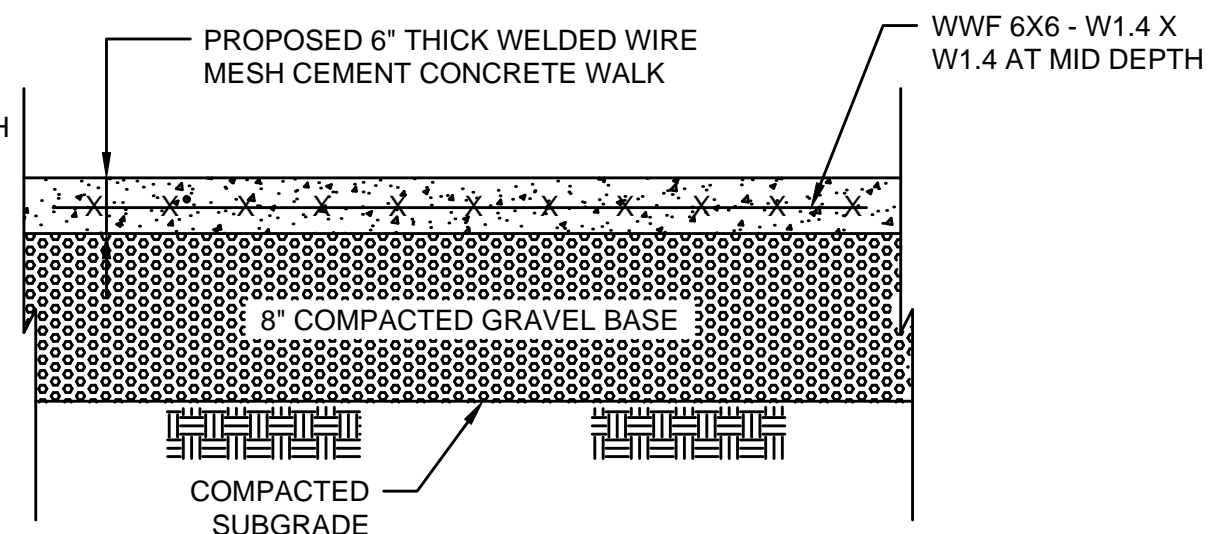

CEMENT CONCRETE PAVEMENT NOTES

1. CEMENT CONCRETE PAVEMENT SHALL HAVE A 28-DAY COMPRESSIVE STRENGTH OF 4,000 PSI WITH 6% AIR-ENTRAINMENT AND MINIMUM CEMENT CONTENT OF 610 LBS/C.Y.
2. CONTRACTOR SHALL SUBMIT CONCRETE JOINT LAYOUT PLAN FOR APPROVAL. EXPANSION JOINTS SHALL BE TRANSVERSE PREFORMED EXPANSION JOINT FILLER (AASHTO M-213-65) 1/2 IN. THICKNESS.
3. PREFORMED EXPANSION JOINT FILLER SHALL BE PLACED ADJACENT TO OR AROUND EXISTING STRUCTURES AND WALKWAYS.
4. EXPANSION JOINTS SHALL BE CONSTRUCTED WITH DOWELS, AS INDICATED IN DETAIL #2.
5. AFTER CONSOLIDATION, CONCRETE DEPTH SHALL BE 4 INCHES IN DEPTH.
6. ENSURE THAT NO BLEED WATER OR WATER SHEEN EXISTS ON THE SURFACE OF THE CONCRETE AND THAT CONCRETE HAS STARTED TO STIFFEN BEFORE ANY FINISHING OPERATIONS ARE PERFORMED.
7. AFTER TROWELING, SURFACE SHALL BE BRUSHED BY DRAWING A SOFT-BRISTLED PUSHBROOM WITH A LONG HANDLE OVER THE SURFACE OF THE CONCRETE TO PRODUCE A NON-SLIP SURFACE.
8. TOOLED CONTROL JOINTS SHALL BE CONSTRUCTED AS INDICATED IN DETAIL #2.
9. THE FINISHING OF CONCRETE SURFACE SHALL BE DONE BY EXPERIENCED AND COMPETENT CEMENT CONCRETE FINISHERS.
10. FINISHING SHALL BE BROOM FINISH WITH A 2' SMOOTH TROWELED EDGE.
11. WHEN COMPLETED, WALKWAYS SHALL BE KEPT MOIST AND PROTECTED FROM TRAFFIC AND WEATHER FOR AT LEAST 3 DAYS.
12. WELDED WIRE MESH SHALL BE 6"x6" No. 10 GAUGE AND SHALL BE SHEET MESH ONLY NOT ROLLED. MESH SHALL REST ON CONCRETE BLOCKS AND BE INSTALLED AT MID DEPTH IN CONCRETE.

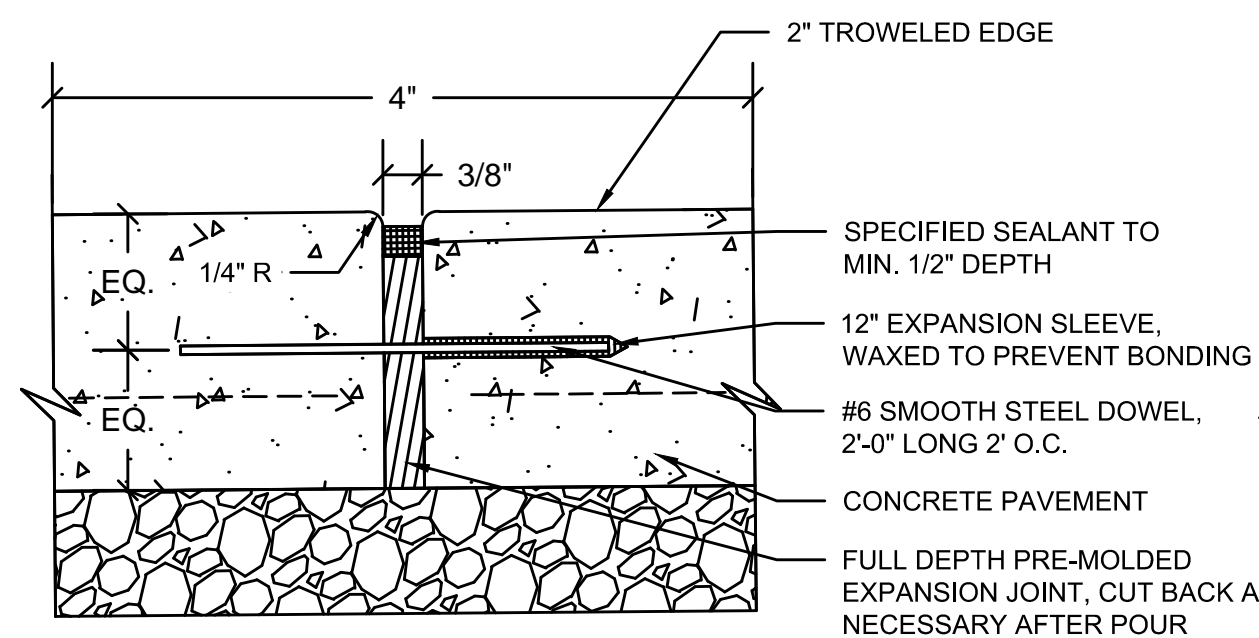


EXPANSION JOINT REQUIRED FOR EVERY +/- 225 SF OF PAVING OR EVERY 20FT ALONG WALKWAYS

EXPANSION JOINT NOTES:

1. DOWEL IS TYPICAL AT ALL EXPANSION JOINTS EXCEPT AGAINST VERTICAL JOINTS WITH WALLS, CURBS OR SITE IMPROVEMENTS.

NOTE:

CONTRACTOR SHALL COORDINATE CONCRETE JOINTS WITH BUILDING PIERS AND FOOTINGS AND SUBMIT A JOINT LAYOUT PLAN FOR ALL CONCRETE PAVED AREAS.

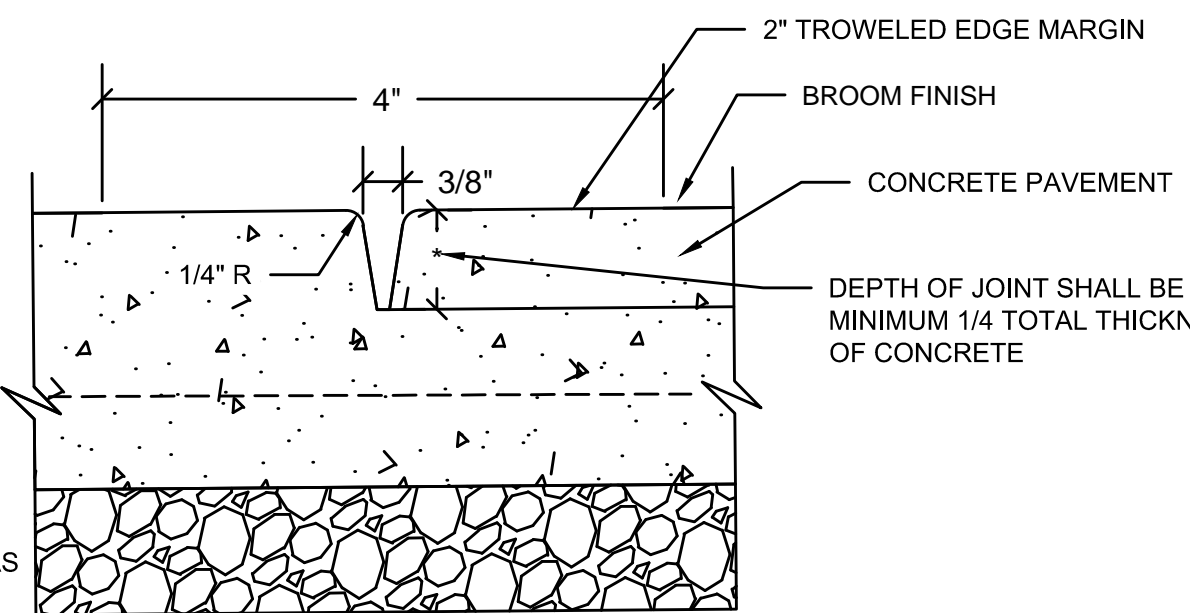


TOOLED CONTROL JOINT REQUIRED FOR EVERY 36 SF OF PAVING.

TOOLED JOINT NOTES:


1. TOOLED MARGIN IS TYPICAL AT ALL JOINTS AND PANEL EDGES.

GENERAL NOTES:

1. SUBMIT SHOP DRAWINGS FOR APPROVAL OF ALL CONCRETE JOINTING LAYOUT

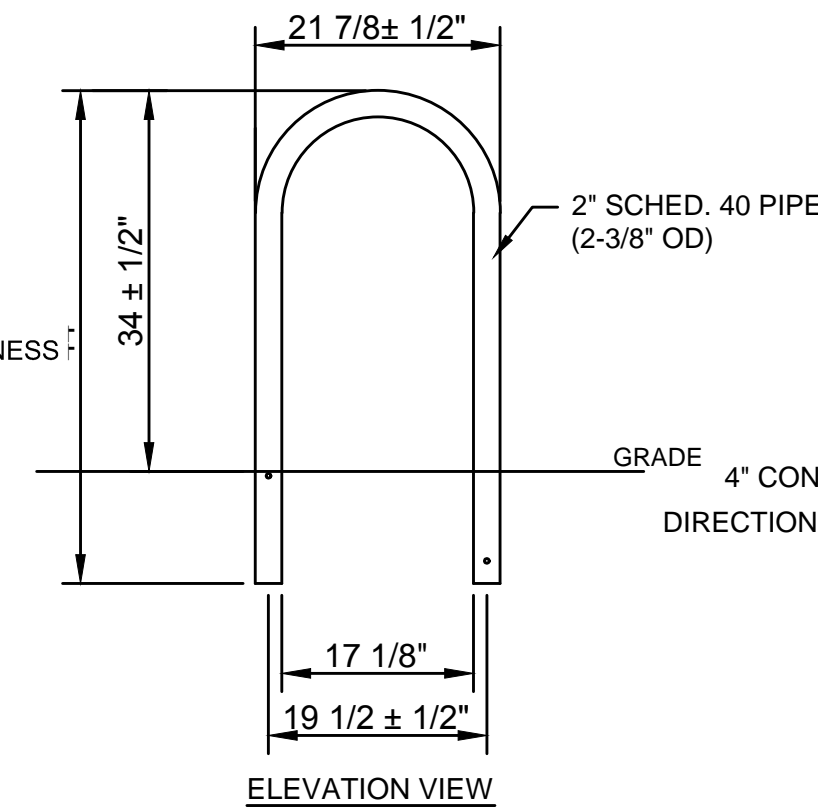


- NOTES:**
1. INSTALL BIKE RACKS ACCORDING TO MANUFACTURER'S SPECIFICATIONS.
 2. SUBMIT SHOP DRAWING FOR APPROVAL.

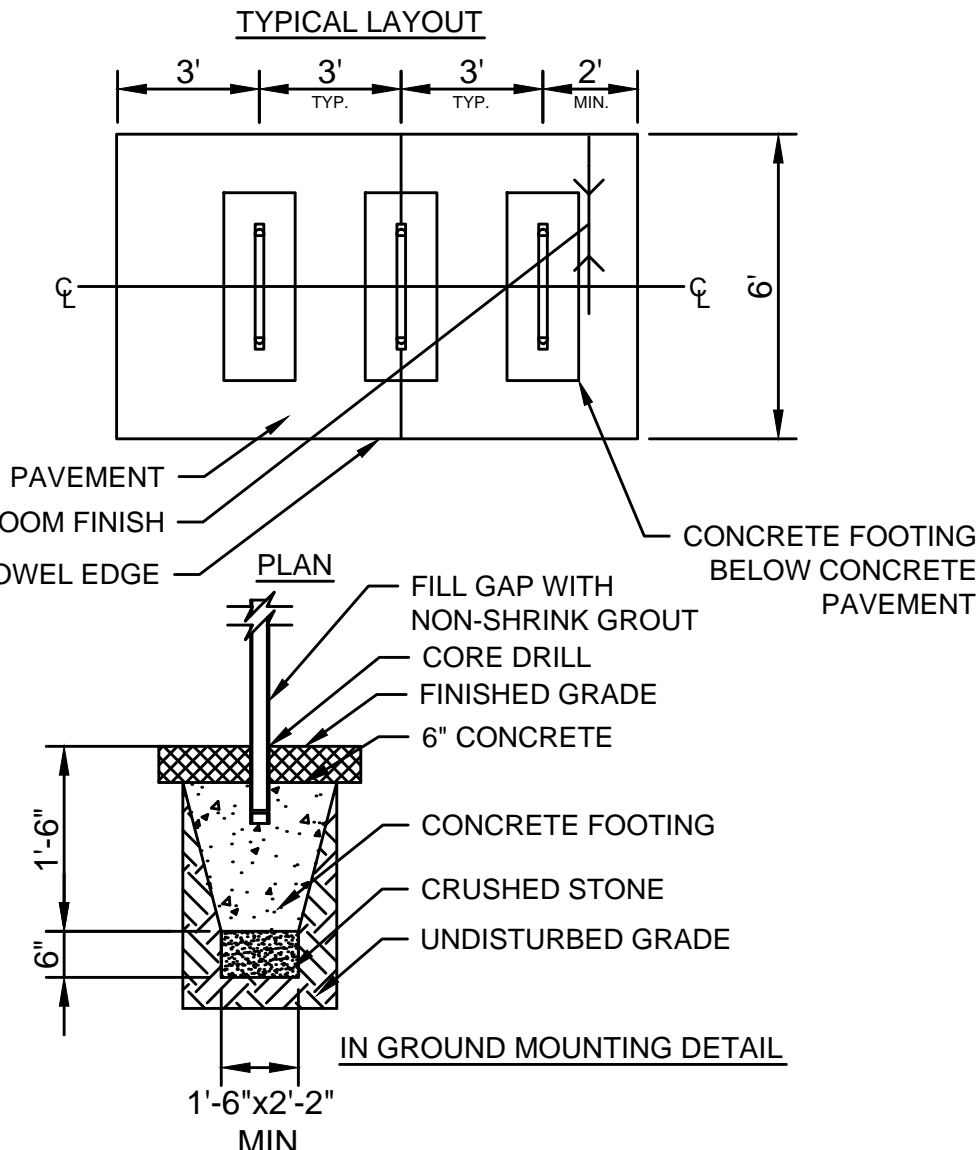

1 CEMENT CONCRETE PAVEMENT
NOT TO SCALE

2 CONCRETE JOINTS
NOT TO SCALE


3 BIKE RACK
NOT TO SCALE

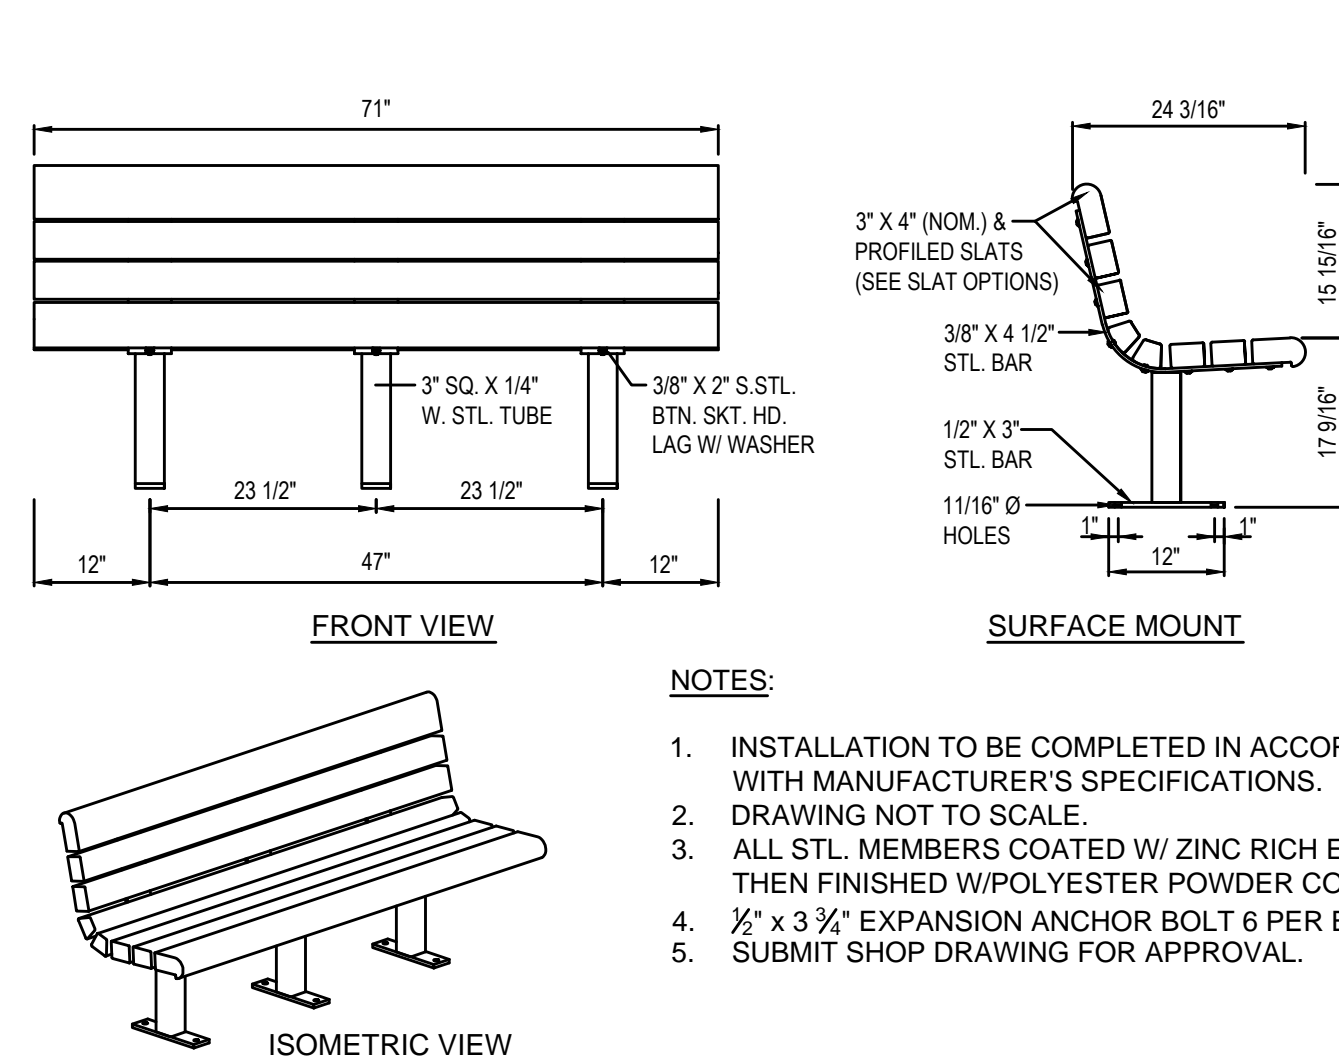

NOTES:

1. INSTALLATION TO BE COMPLETED IN ACCORDANCE WITH MANUFACTURER'S SPECIFICATIONS.
2. DRAWING NOT TO SCALE.
3. ALL STL. MEMBERS COATED W/ ZINC RICH EPOXY THEN FINISHED W/POLYESTER POWDER COATING.
4. 1/2\"/>



4 RECYCLED PLASTIC BENCH
NOT TO SCALE

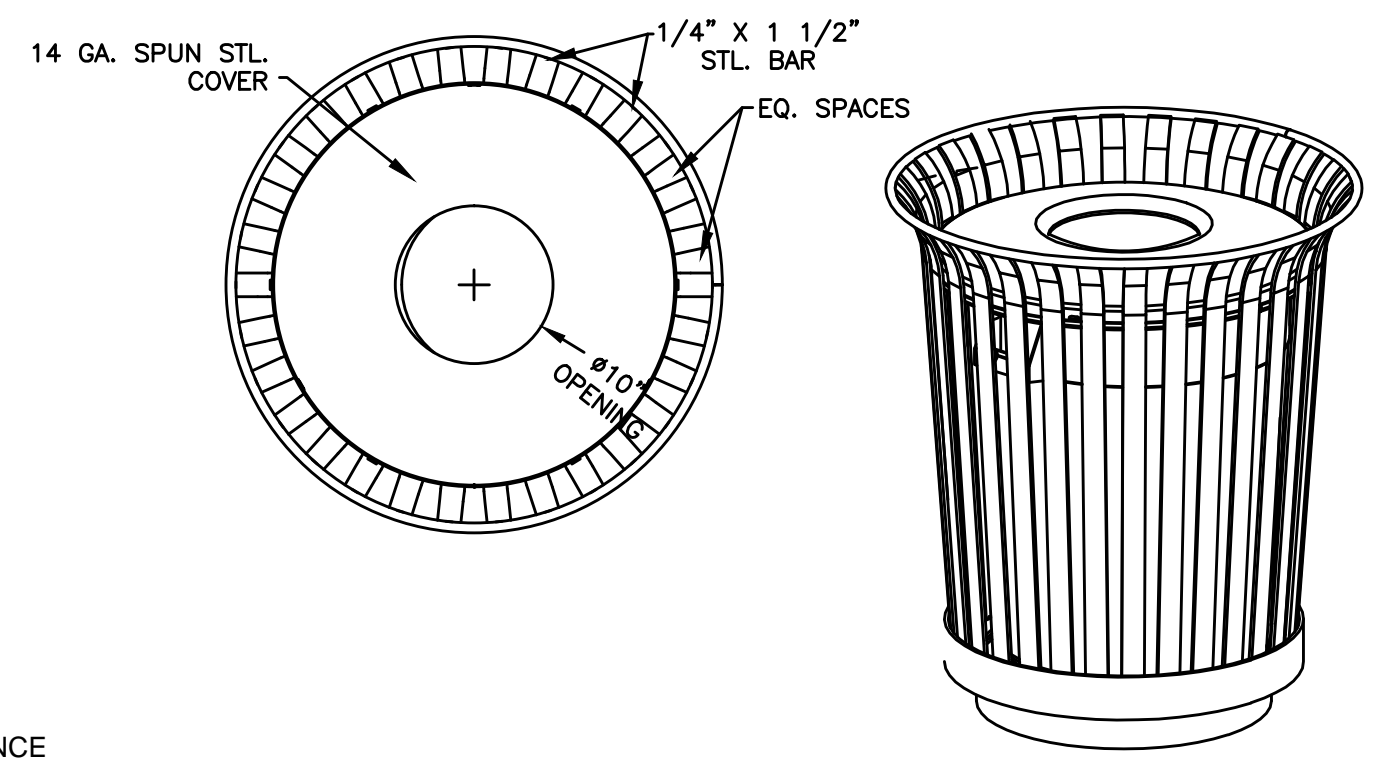

NOTES:

- 1.) ALL STL. MEMBERS COATED W/ ZINC RICH EPOXY THEN FINISHED W/ POLYESTER POWDER COATING.
- 2.) 1/2\"/>

5 TRASH RECEPTACLE
NOT TO SCALE

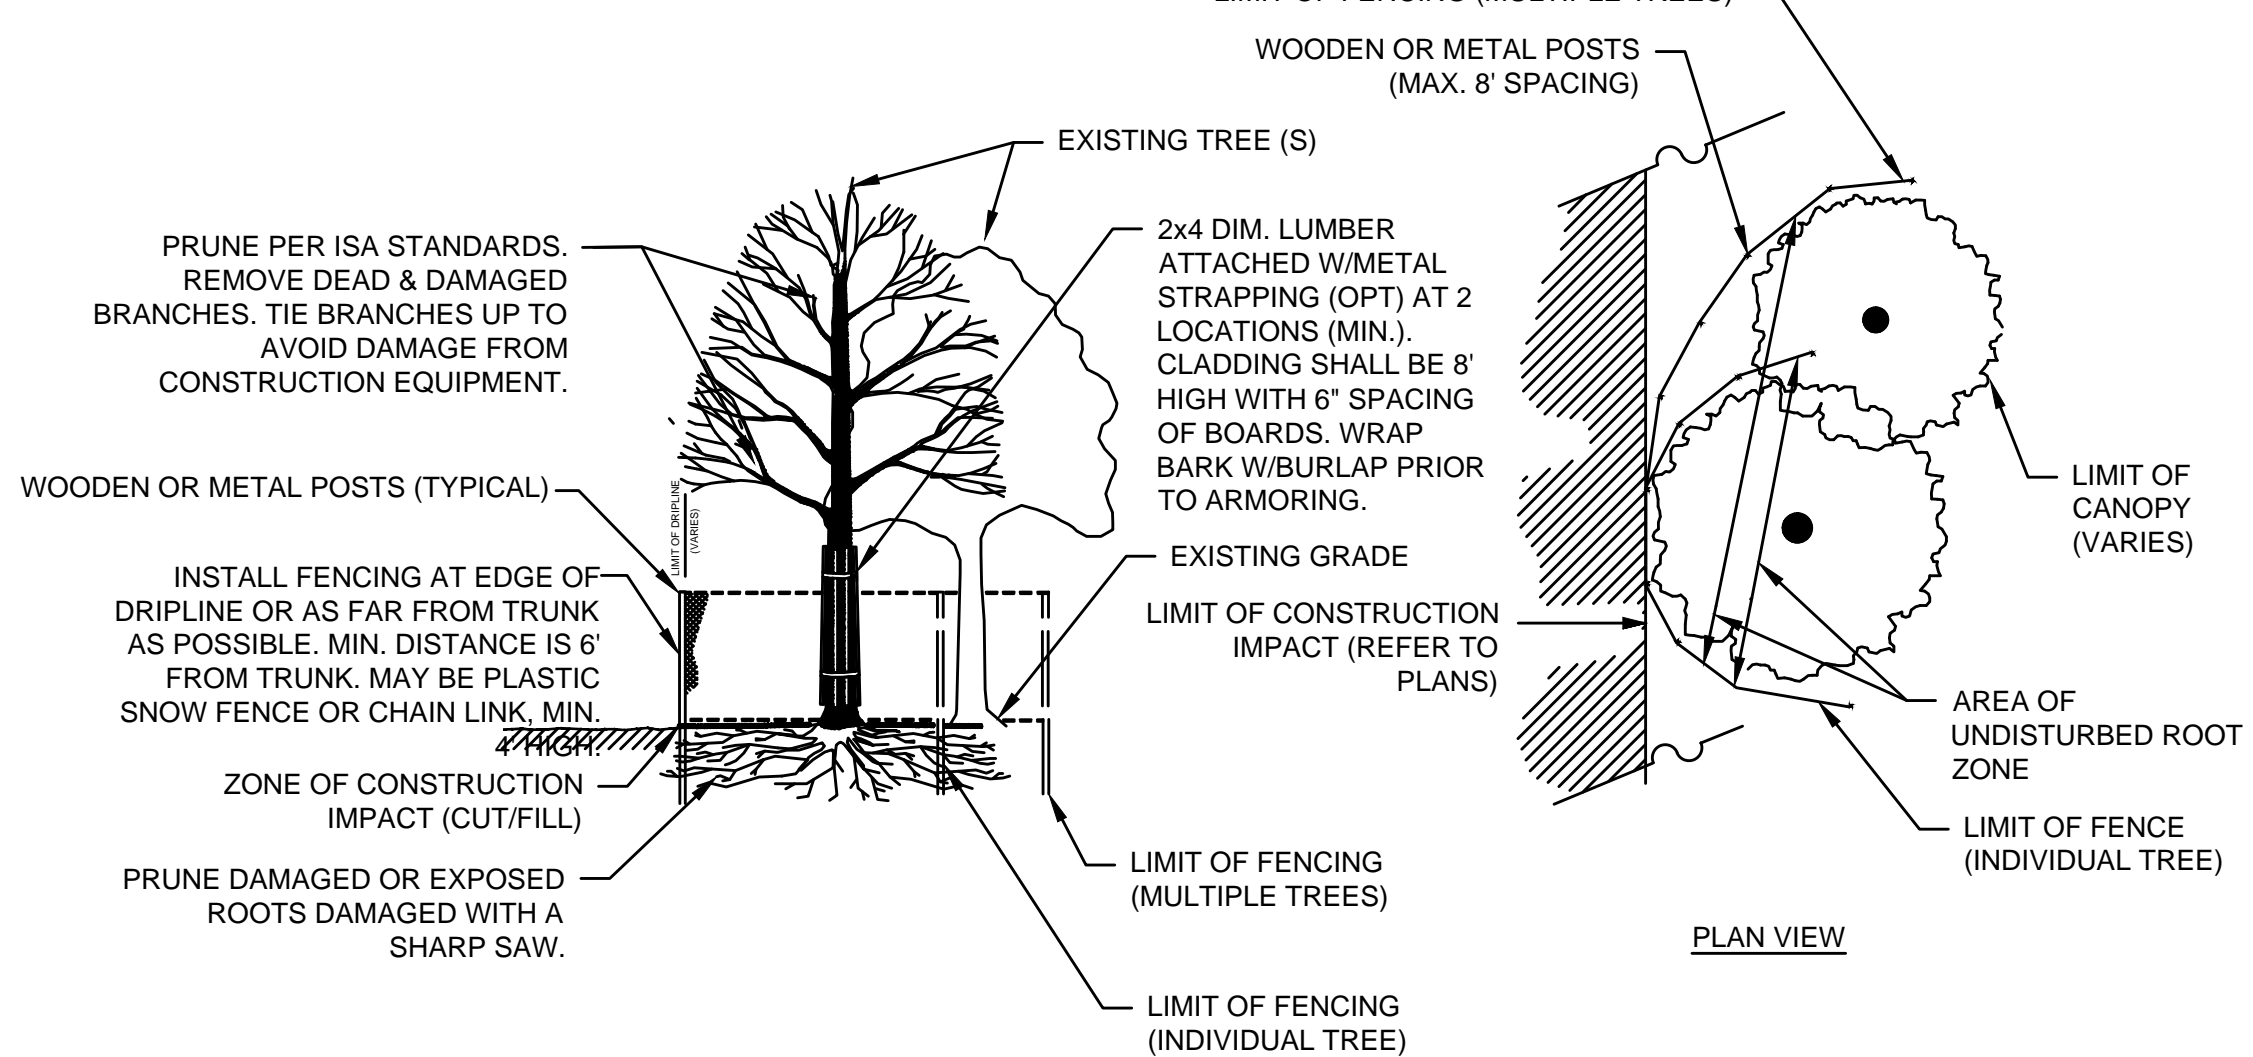
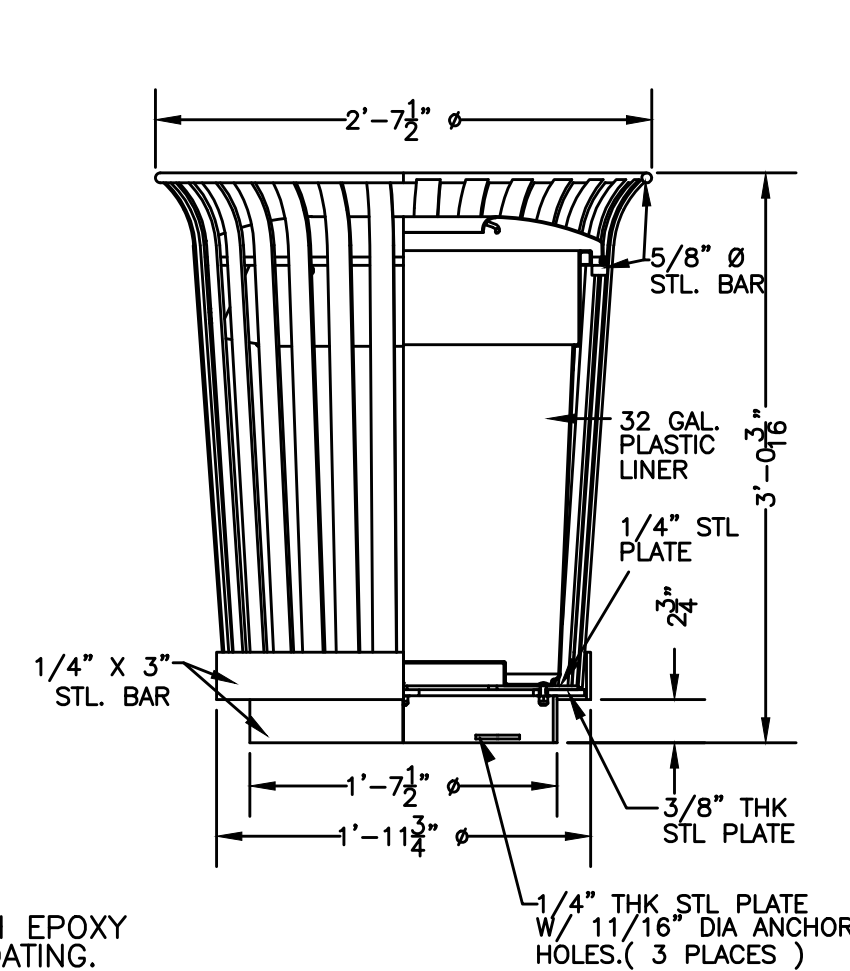


6 TREE PROTECTION OF EXISTING TREES
NOT TO SCALE

PROJECT:	MINUTEMAN BIKEWAY IMPROVEMENTS AT LAKE STREET	
DESIGN SUBMISSION:	DRAFT FINAL DESIGN	
DRAWING TITLE:	LANDSCAPE DETAILS	
PREPARED FOR:	TOWN OF ARLINGTON ENGINEERING DIVISION 51 GROVE STREET ARLINGTON, MA 02476	
PREPARED BY:	GREEN INTERNATIONAL AFFILIATES, INC. Civil and Structural Engineers (978) 923-0400 Westford, Massachusetts GreenIntl.com	
SCALE:	AS NOTED	DESIGNED BY: JG
DATE:	09/15/2017	DRAWN BY: JG
PROJECT NO.:	17067.015	CHECKED BY: JS
SHEET NO. 21		OF 26

LIGHTING DESIGN SERVICES	LUMEN STUDIO, INC.	
ELECTRICAL WIRING DESIGN SERVICES	ENGINEERING ADVANTAGE, INC.	
NO.	DATE	REVISIONS


P:\Projects\2017\CONCURRENT DESIGN\LANDSCAPE DETAILS.dwg, PLOT DATE: 09/15/2017, 09:29

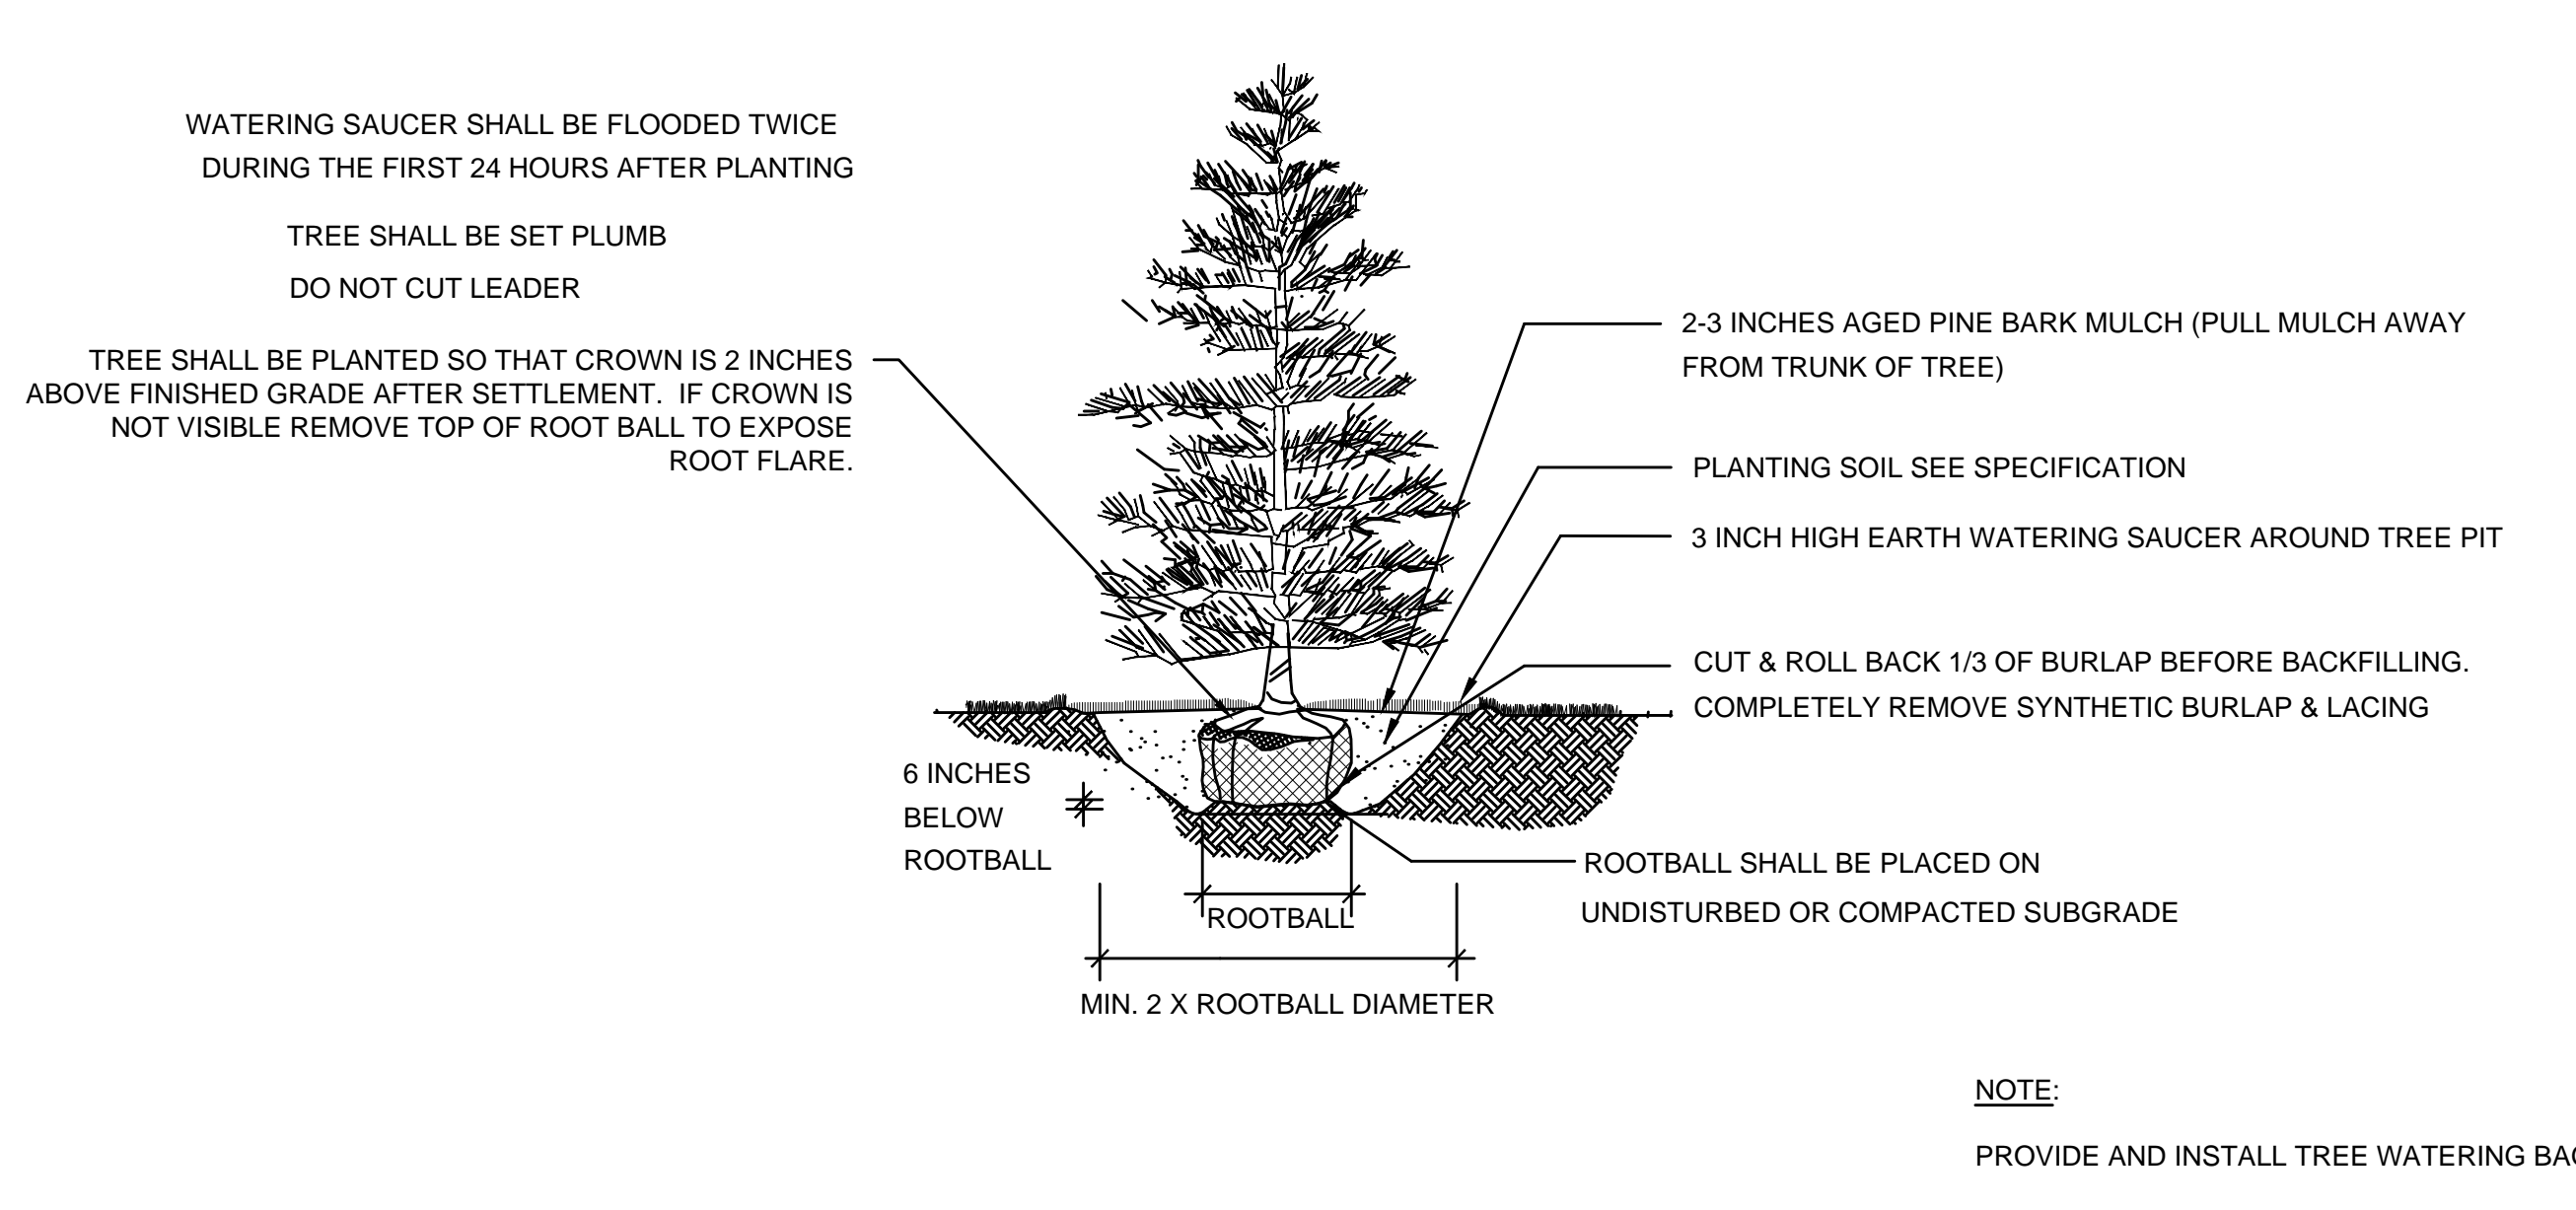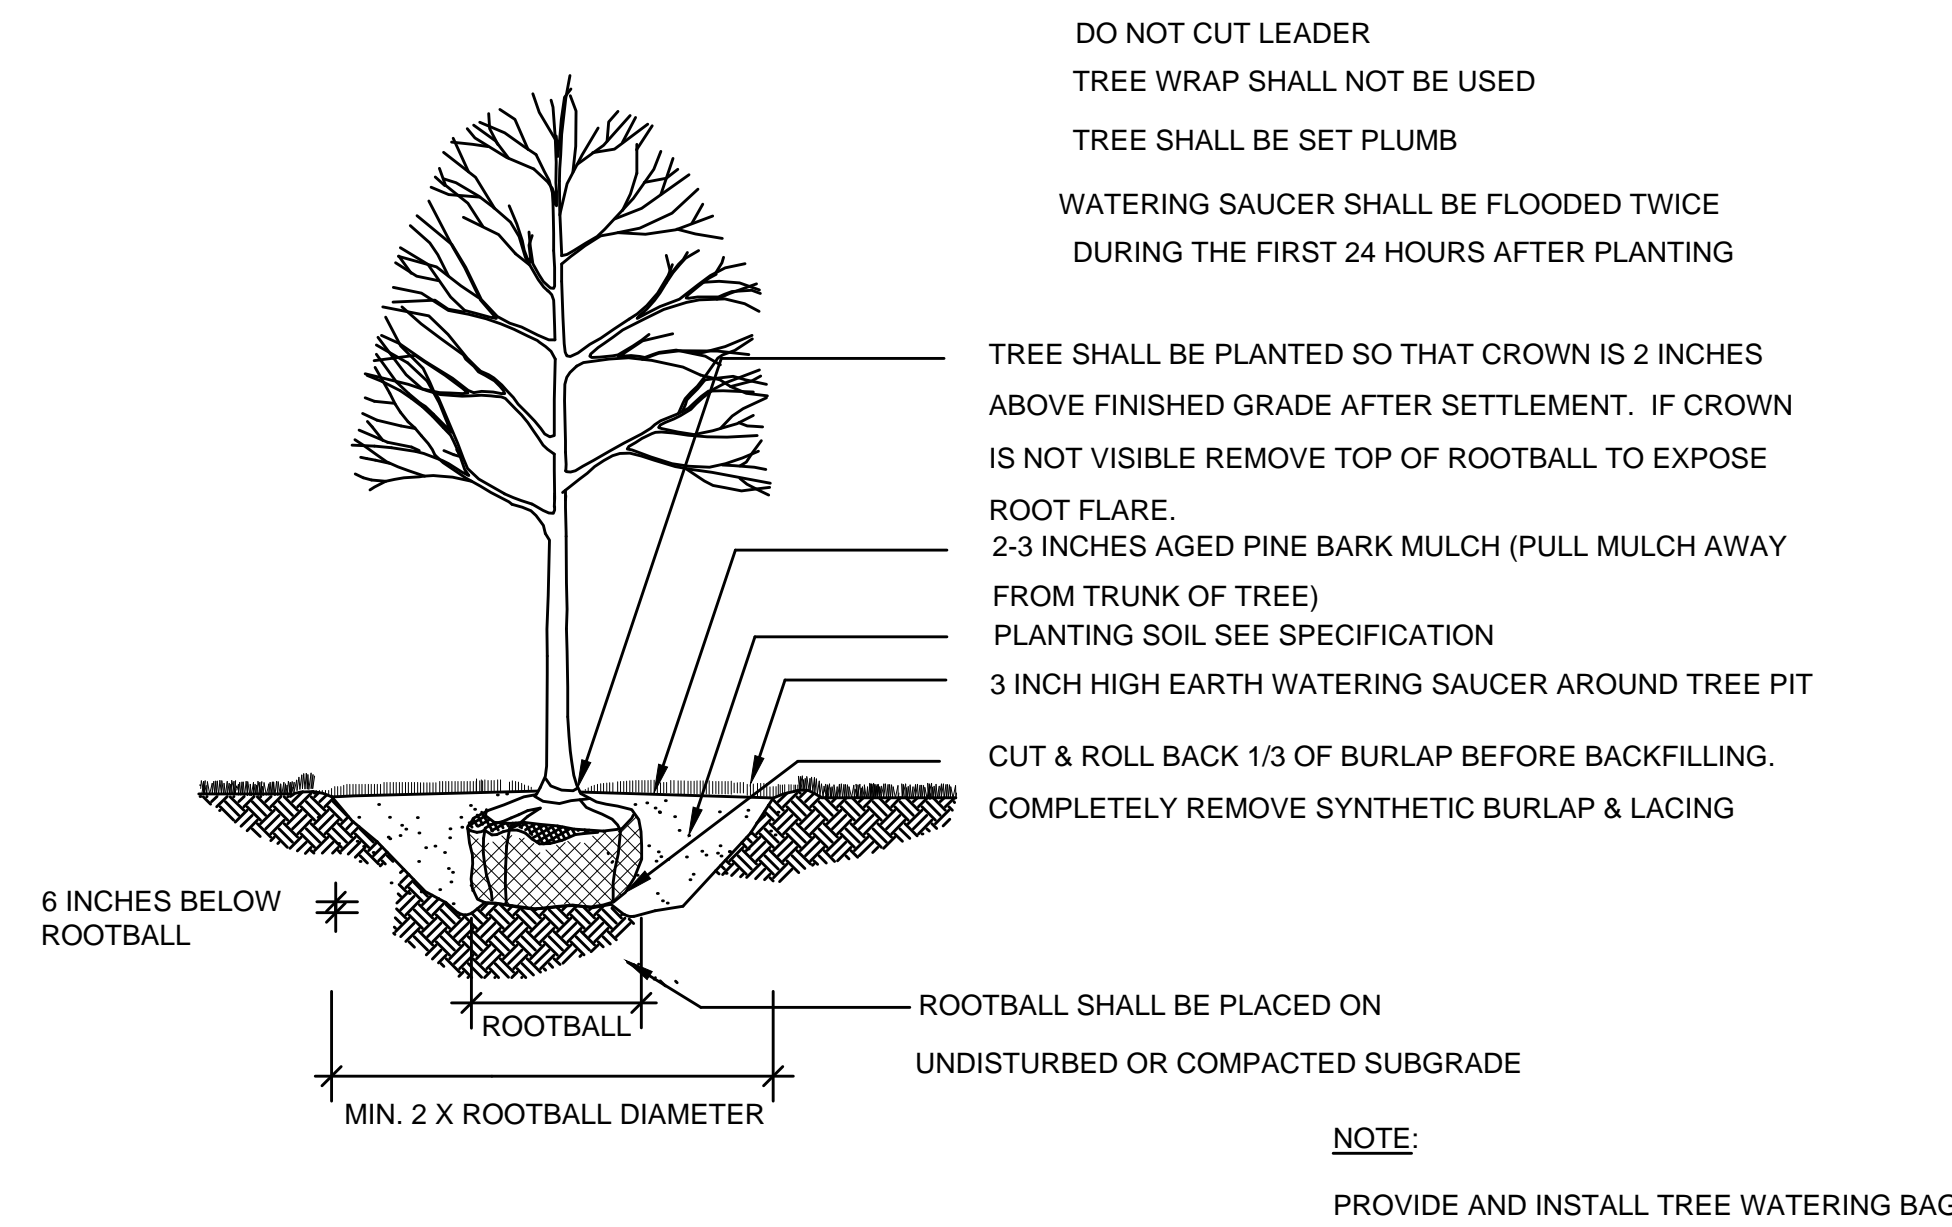


1 DECIDUOUS TREE PLANTING
 NOT TO SCALE

EXCAVATE TO REQUIRED DEPTH AND BACKFILL WITH PLANTING SOIL


RAISE AND REPLANT ANY PLANTS THAT SETTLE MORE THAN 2 INCHES AFTER PLANTING AND WATERING IN

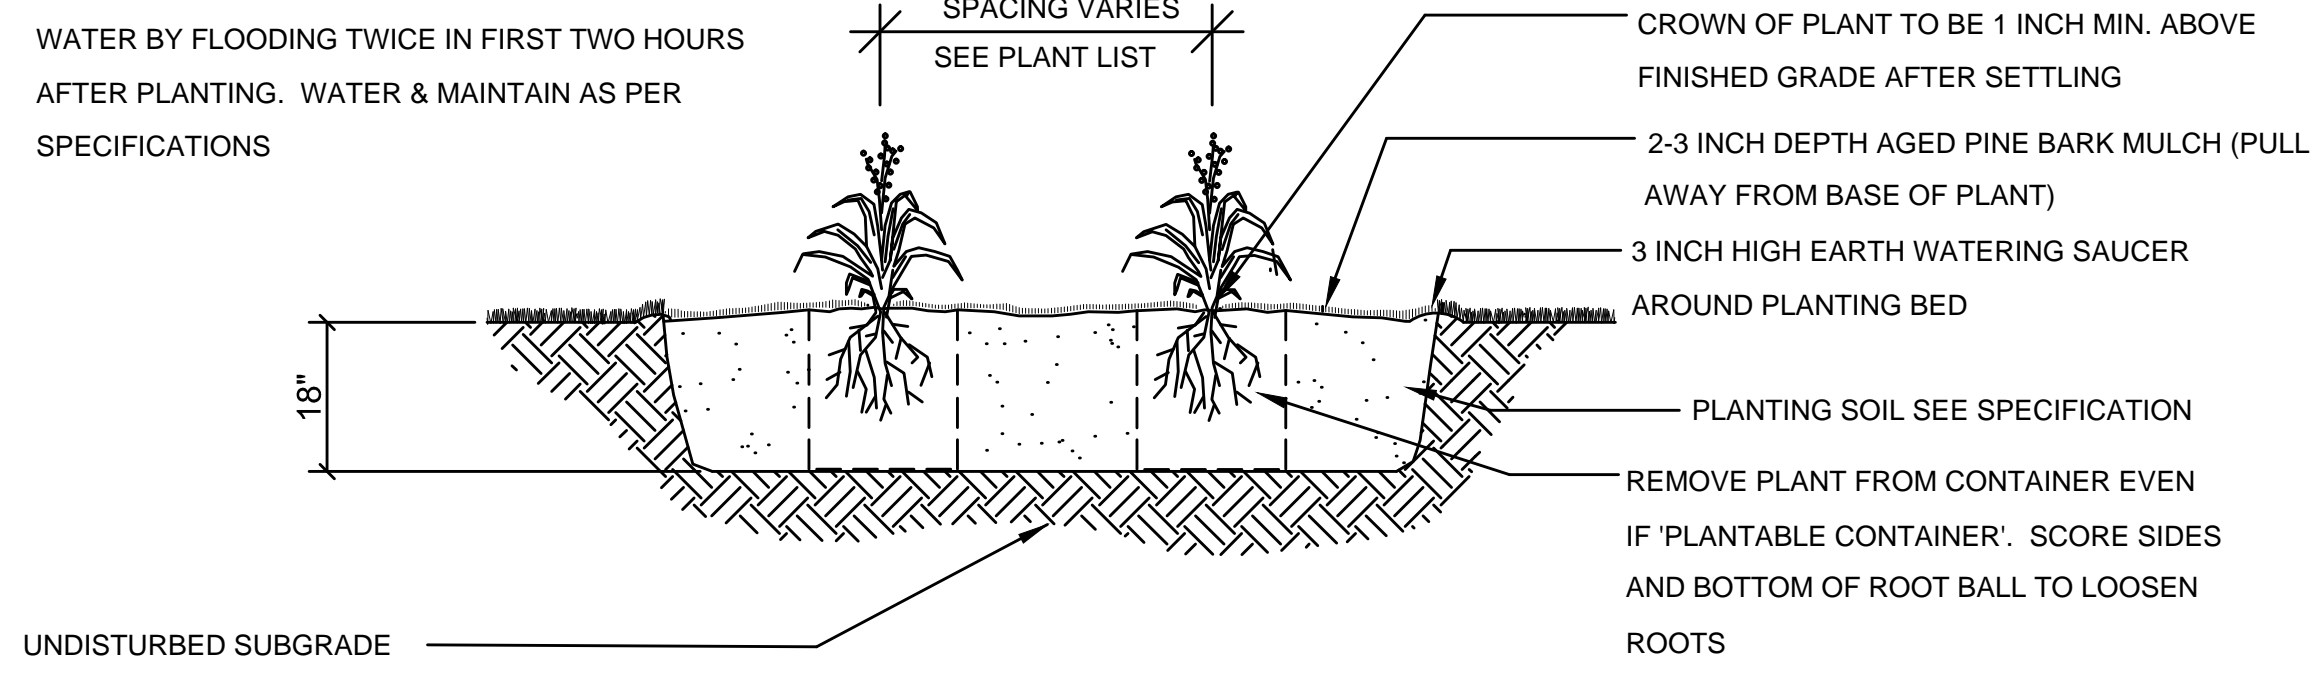

2 PERENNIAL
 NOT TO SCALE

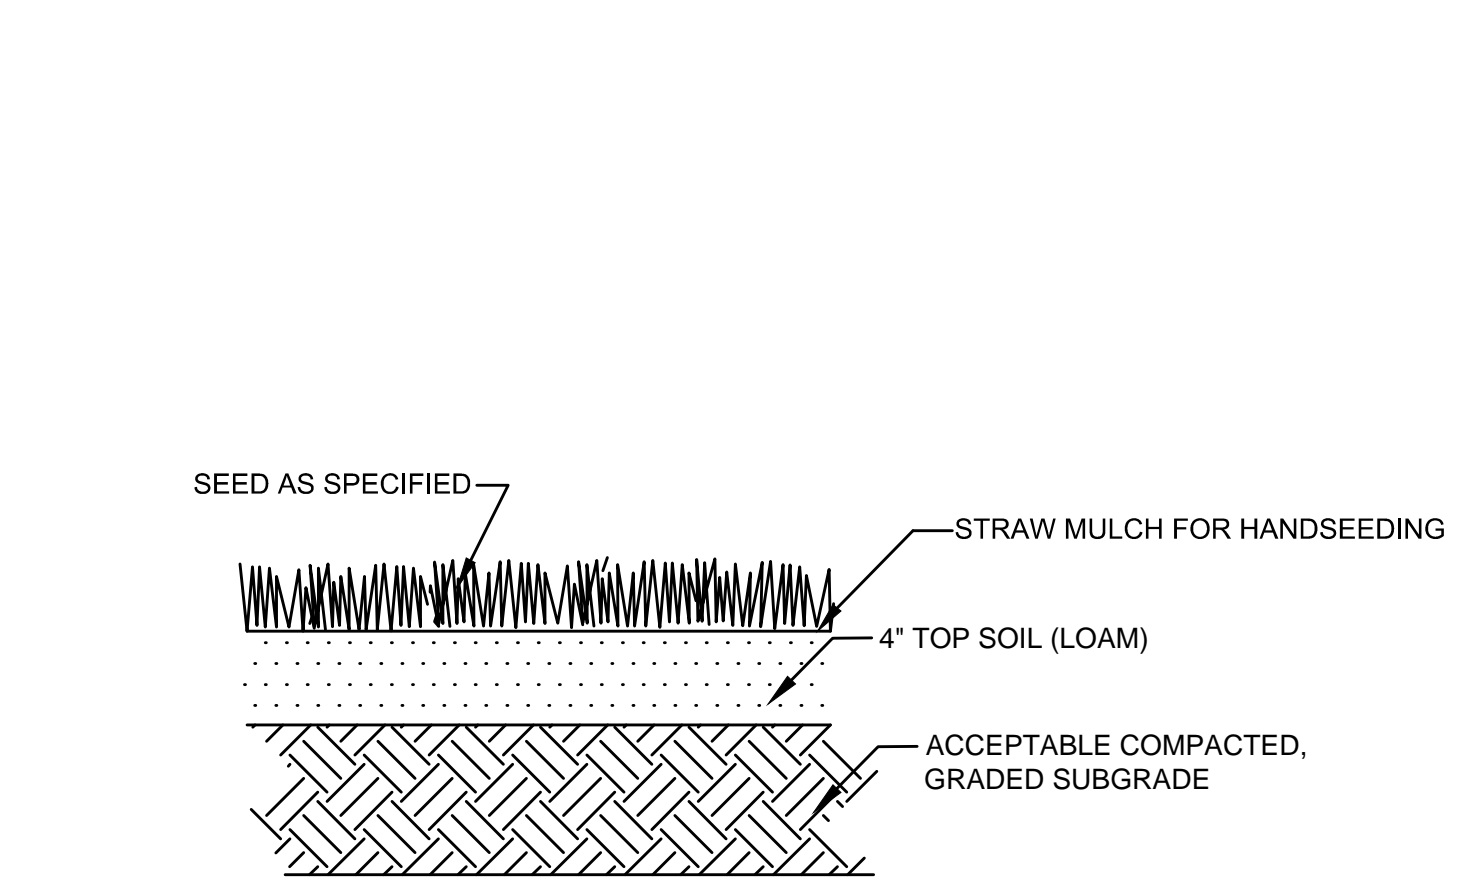

3 LOAM & SEED
 NOT TO SCALE

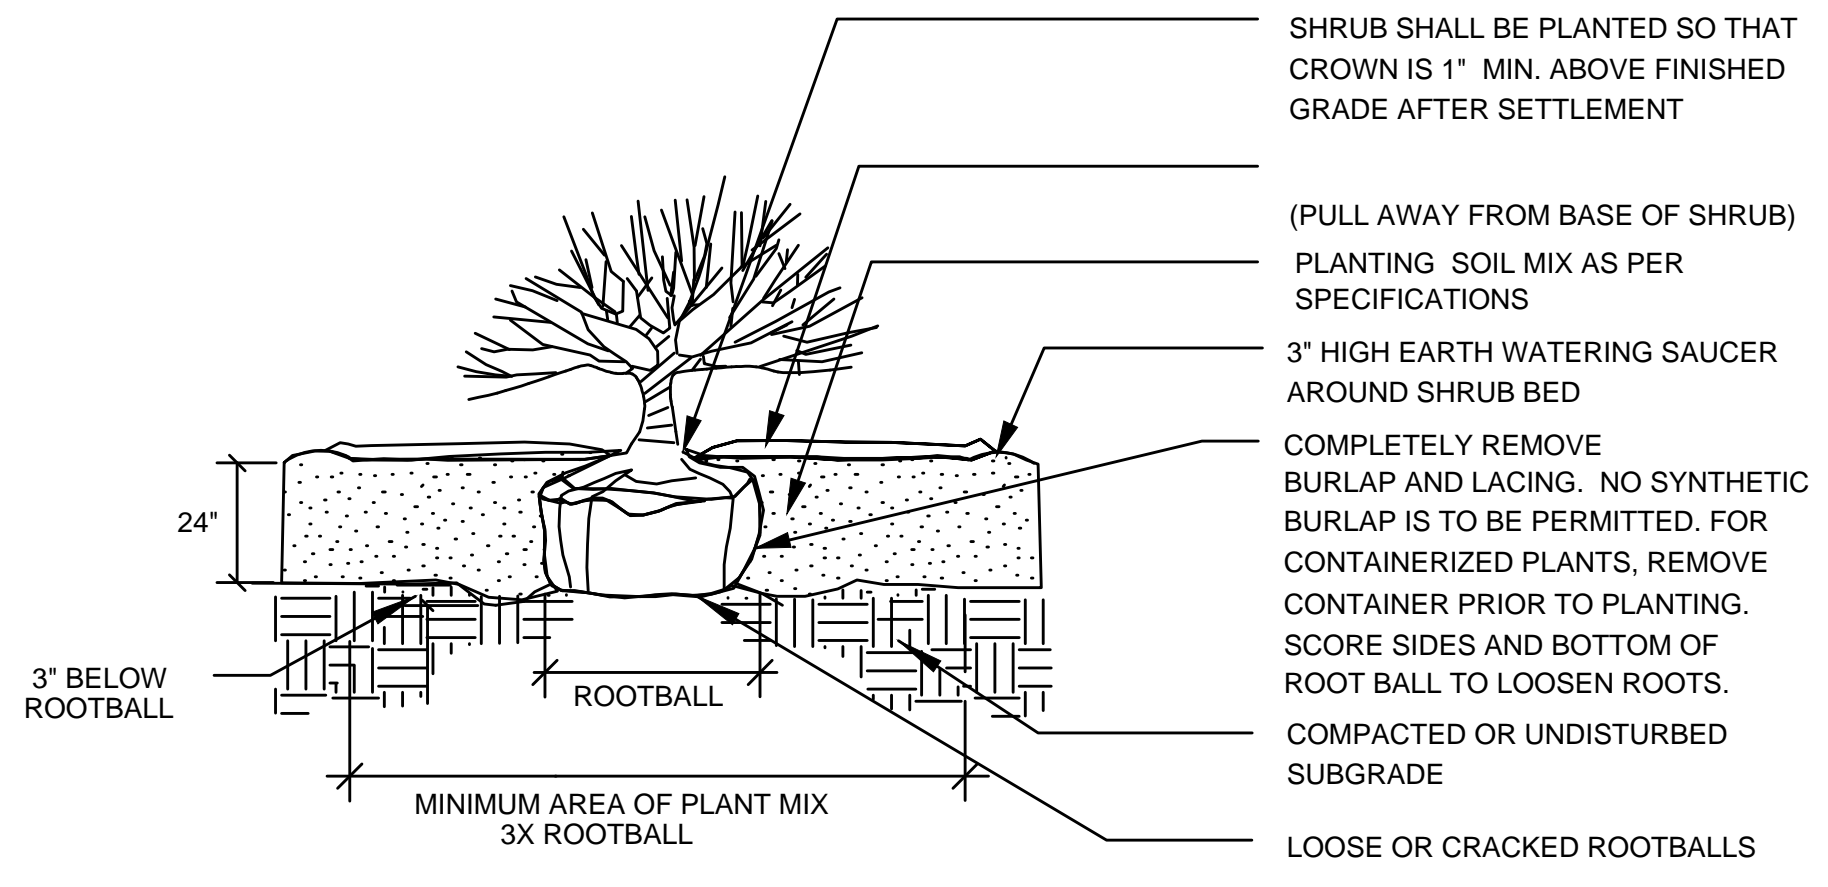

4 SHRUB PLANTING DETAIL
 NOT TO SCALE

5 EVERGREEN PLANTING
 NOT TO SCALE

KEY	QTY	BOTANICAL NAME	COMMON NAME	SIZE	REMARKS/ ROOT SPACING
DECIDUOUS TREES					
CC	2	CARPINUS CAROLINIANA	IRONWOOD	2-2 1/2" CAL	TREE FORM B&B
OV	1	OSTRYA VIRGINIANA	AMERICAN HOPHORNBEAM	2-2 1/2" CAL	TREE FORM B&B
EVERGREEN TREES					
TG	7	THUJA PLICATA 'GREEN GIANT'	GREEN GIANT ARBORVITEA	6-7' HT	B&B
DECIDUOUS SHRUBS					
CR	10	CORNUS RACEMOSA	GRAY TWIG DOGWOOD	3-4' HT	4' O.C. CONT #7
CL	23	CLETHRA ALNIFOLIA 'HUMMINGBIRD'	HUMMINGBIRD SUMMERSWEET	2-3' FT	3' O.C. CONT #5
DL	64	DIERVILLA LONICERA	BUSH HONEYSUCKLE	18-24" SP.	18" O.C. CONT 3
RA	36	RHUS AROMATICA 'GRO-LOW'	GRO-LOW FRAGRANT SUMAC	18-24" SP.	2.5' O.C. CONT #3
VD	19	VIBURNUM DENTATUM 'CHRISTOM'	BLUE MUFFIN VIBURNUM	3-4' HT	4' O.C. CONT #7
EVERGREEN SHRUBS					
IG	21	ILEX GLABRA 'SHAMROCK'	SHAMROCK INKBERRY	2-3' FT	3' O.C. CONT #5
JHB	15	JUNIPERUS HORIZONTALIS 'BAR HARBOR'	BAR HARBOR JUNIPER	18-24" SP.	2' O.C. CONT #2
JHP	28	JUNIPERUS HORIZONTALIS PLUMOSA COMPACTA	COMPACT ANDORRA JUNIPER	18-24" SP.	2' O.C. CONT #2
JVG	6	JUNIPERUS VIRGINIANA 'GREY OWL'	GREY OWL JUNIPER	2-2.5' SP.	3' O.C. CONT #3
MP	5	MYRICA PENNSYLVANICA	BAYBERRY	3-4' HT	4' O.C. B&B
PERENNIALS AND GRASSES					
RG	68	RUDBECKIA FULVA 'GOLDSTRM'	BLACK EYED SUSAN	CONT #2	12" O.C. CONT #2
HH	33	HEMEROCALLIS 'HAPPY RETURNS'	HAPPY RETURNS DAYLILLY	CONT #2	9" O.C. CONT #2
SSB	34	SCHIZACHYIUM SCOPARIUM 'THE BLUES'	THE BLUES LITTLE BLUESTEM	CONT #2	12" O.C. CONT #2

PROJECT: **MINUTEMAN BIKEWAY IMPROVEMENTS AT LAKE STREET**

DESIGN SUBMISSION: **DRAFT FINAL DESIGN**

DRAWING TITLE: **LANDSCAPE DETAILS 2**

PREPARED FOR: **TOWN OF ARLINGTON ENGINEERING DIVISION**
 51 GROVE STREET
 ARLINGTON, MA 02476

PREPARED BY: **GREEN INTERNATIONAL AFFILIATES, INC.**
 Civil and Structural Engineers (978) 923-0400
 Westford, Massachusetts GreenIntl.com

LIGHTING DESIGN SERVICES
 LUMEN STUDIO, INC.

ELECTRICAL WIRING DESIGN SERVICES
 ENGINEERING ADVANTAGE, INC.





NO.	DATE	REVISIONS

SCALE: AS NOTED
 DATE: 09/15/2017
 PROJECT NO. 17067.015

DESIGNED BY: JG
 DRAWN BY: JG
 CHECKED BY: JS

SHEET NO. **22** OF **26**

P:\Projects\2017\PROJ\201709\20170901\LANDSCAPE DETAILS.dwg, P:\Projects\2017\PROJ\201709\20170901\LANDSCAPE DETAILS.dwg

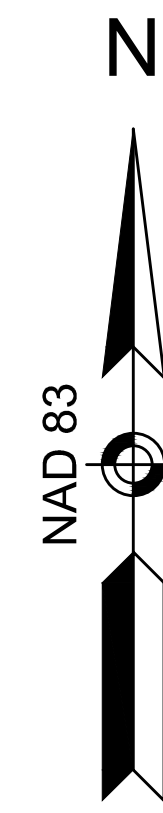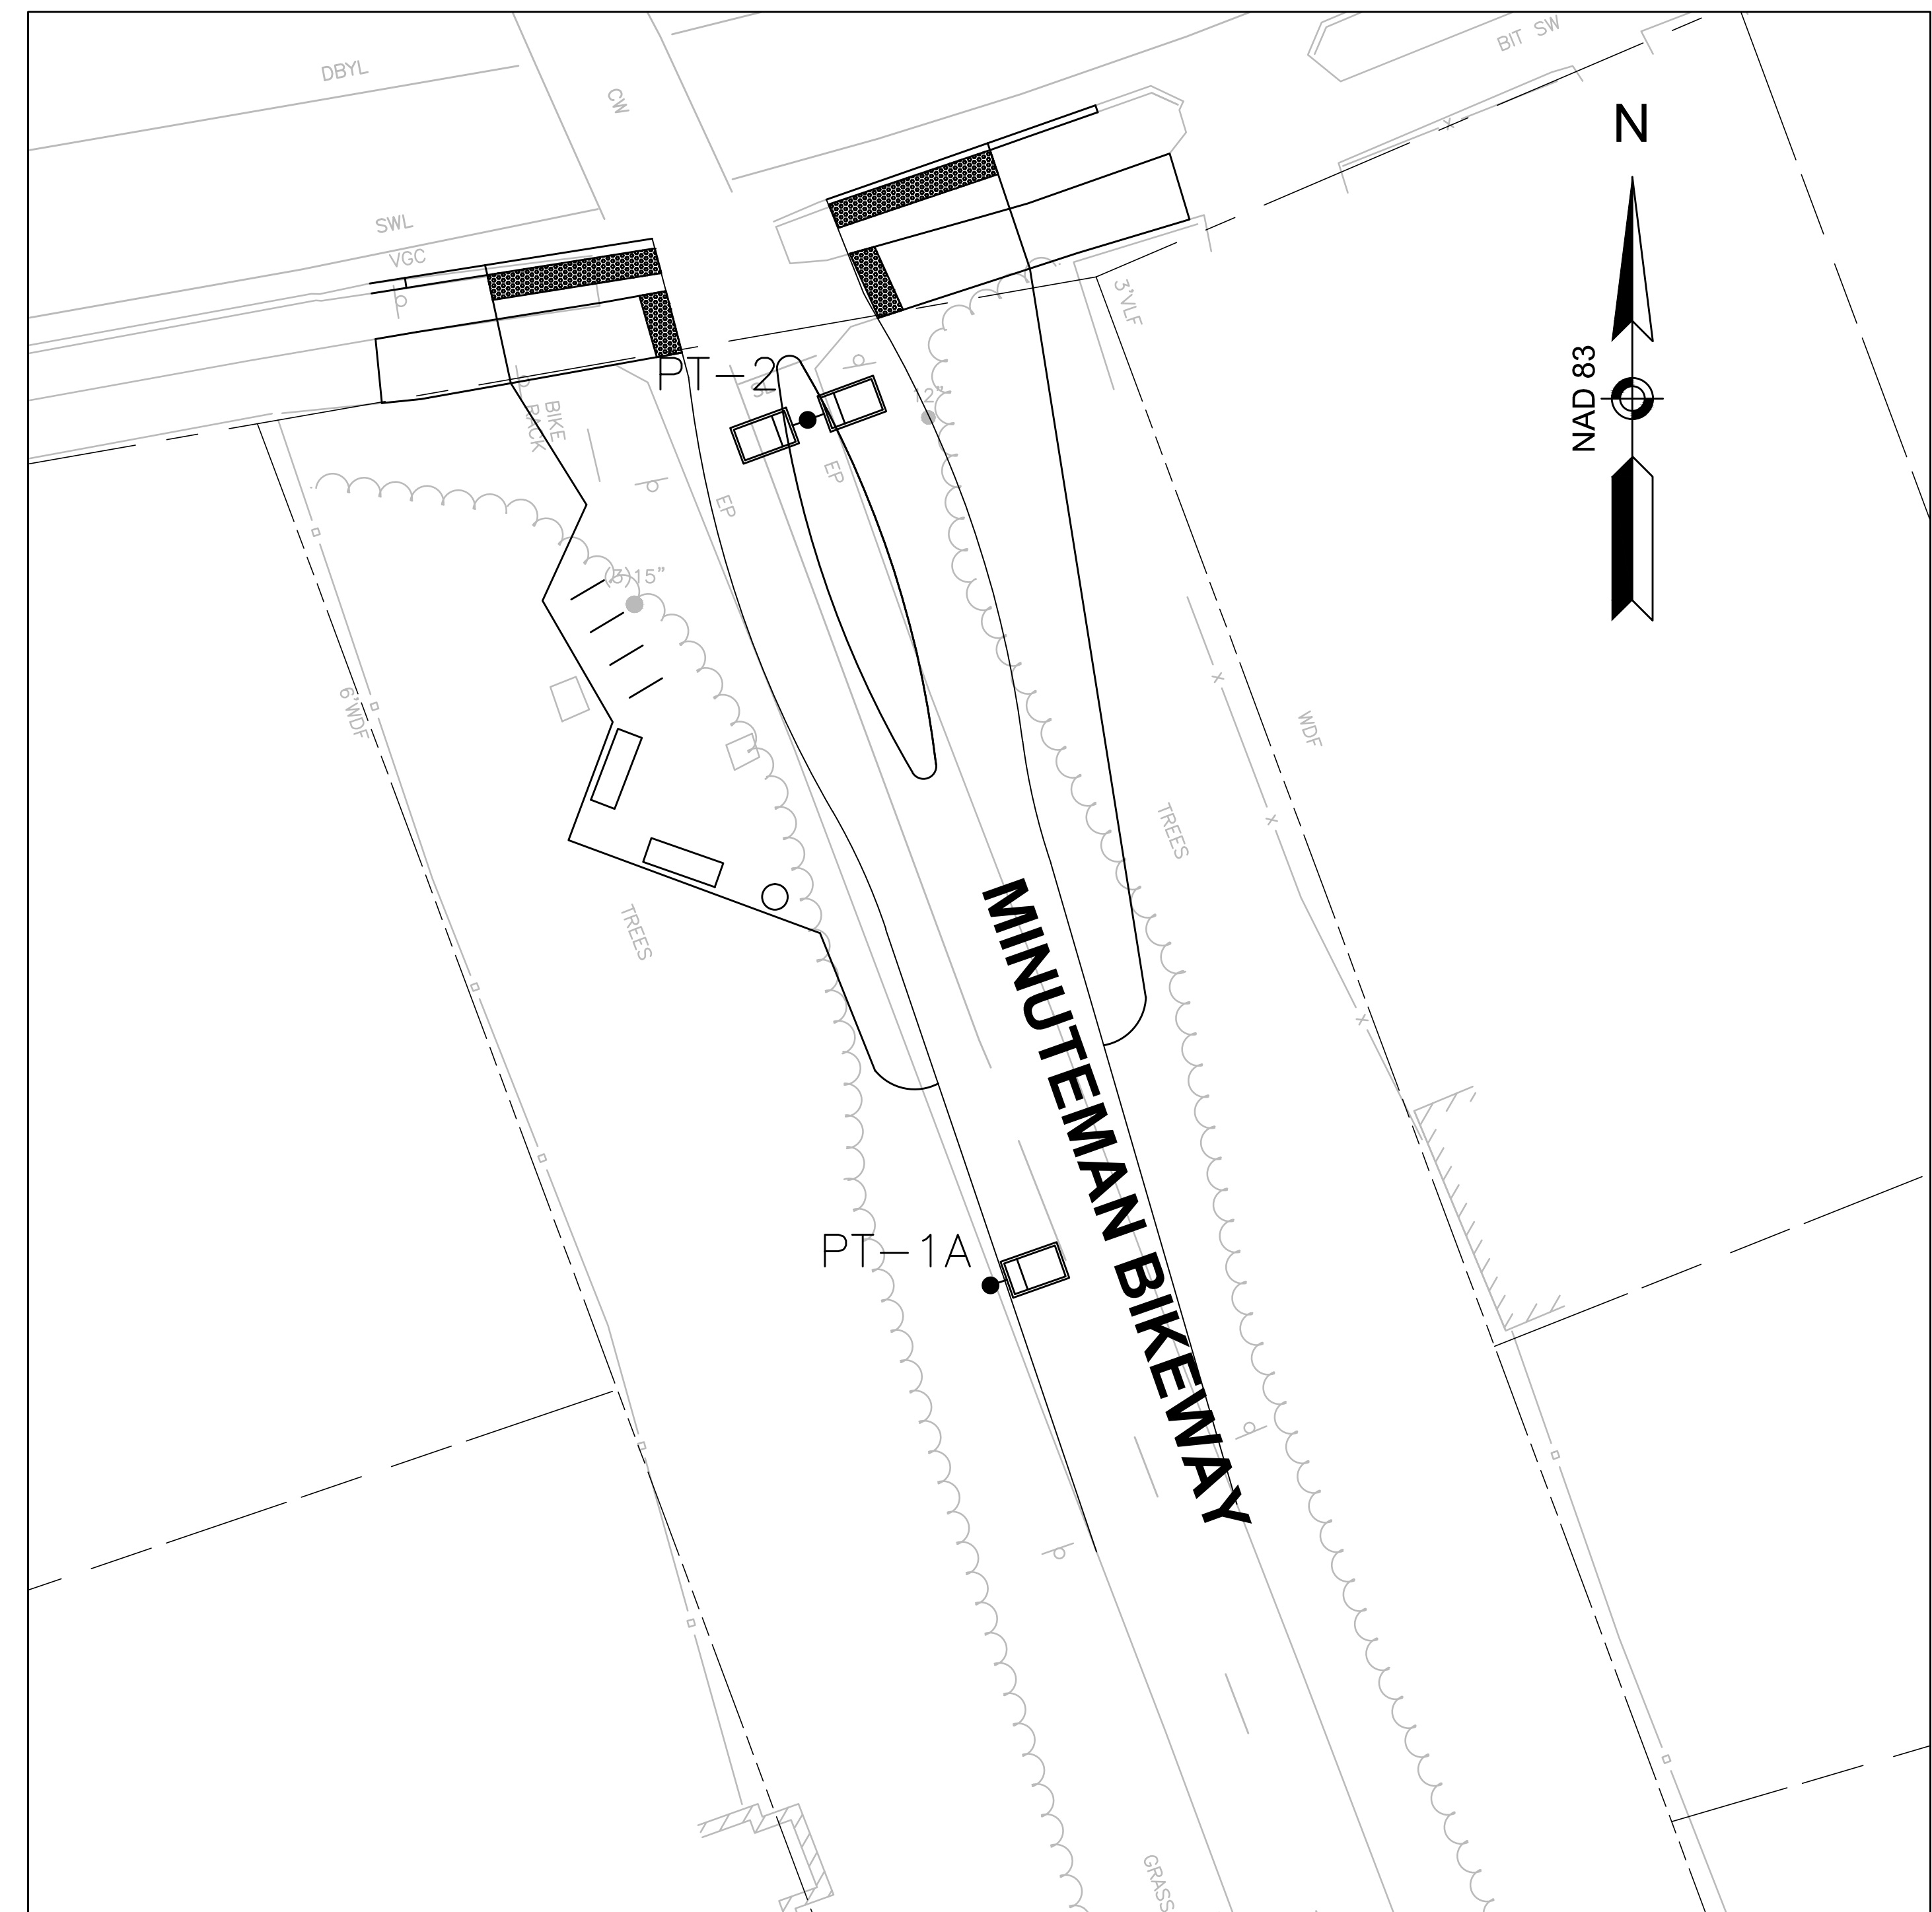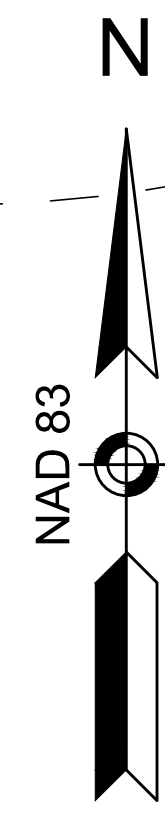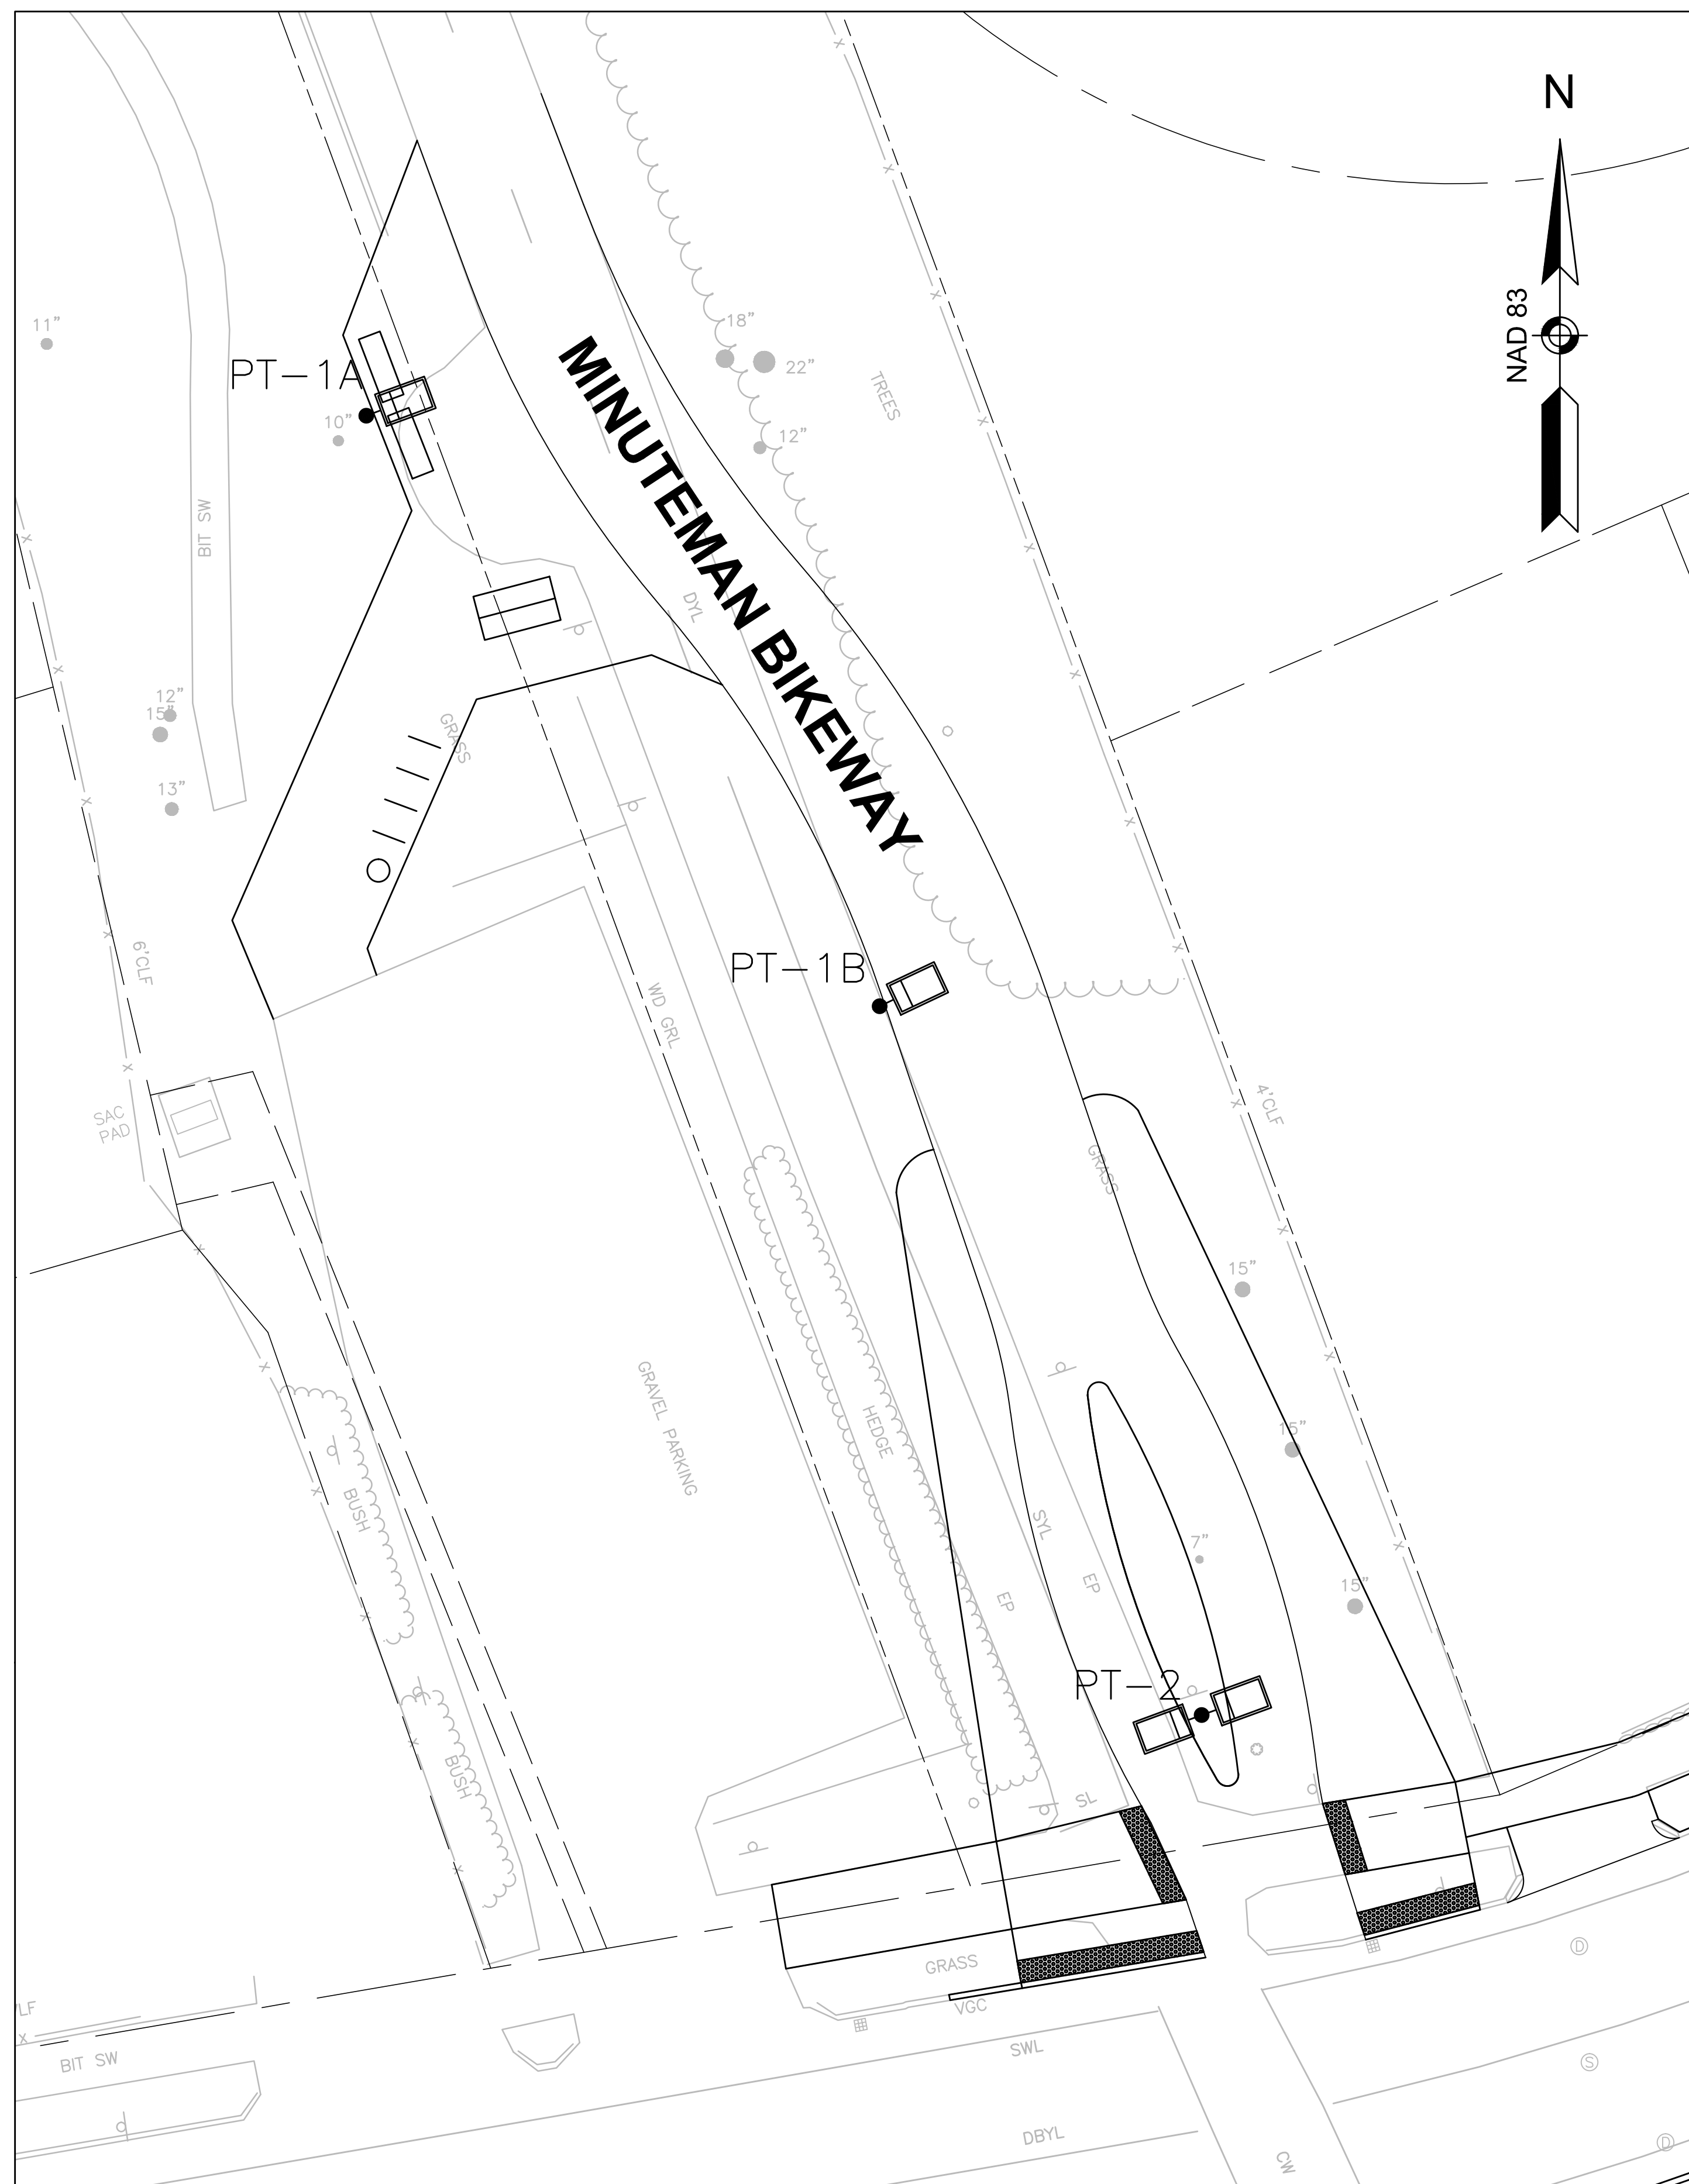

PROJECT: **MINUTEMAN BIKEWAY IMPROVEMENTS AT LAKE STREET**

DESIGN SUBMISSION: **DRAFT FINAL DESIGN**

DRAWING TITLE: **LIGHTING PLAN**

PREPARED FOR:
 **TOWN OF ARLINGTON**
 ENGINEERING DIVISION
 51 GROVE STREET
 ARLINGTON, MA 02476



PREPARED BY:
 **GREEN INTERNATIONAL AFFILIATES, INC.**
 Civil and Structural Engineers (978) 923-0400
 Westford, Massachusetts GreenIntl.com

SCALE: AS NOTED	DESIGNED BY: JG	SHEET NO. 23 OF 26
DATE: 09/15/2017	DRAWN BY: JG	
PROJECT NO. 17067.015	CHECKED BY: JS	

LIGHTING DESIGN SERVICES
 LUMEN STUDIO, INC.
 ELETRICAL WIRING DESIGN SERVICES
 ENGINEERING ADVANTAGE, INC.

NO.	DATE	REVISIONS


P:\Projects\2017\17067\CONCURRENT\DESIGN\23 LIGHTING PLAN.dwg, Plotted: 09/20/17 2:54 PM

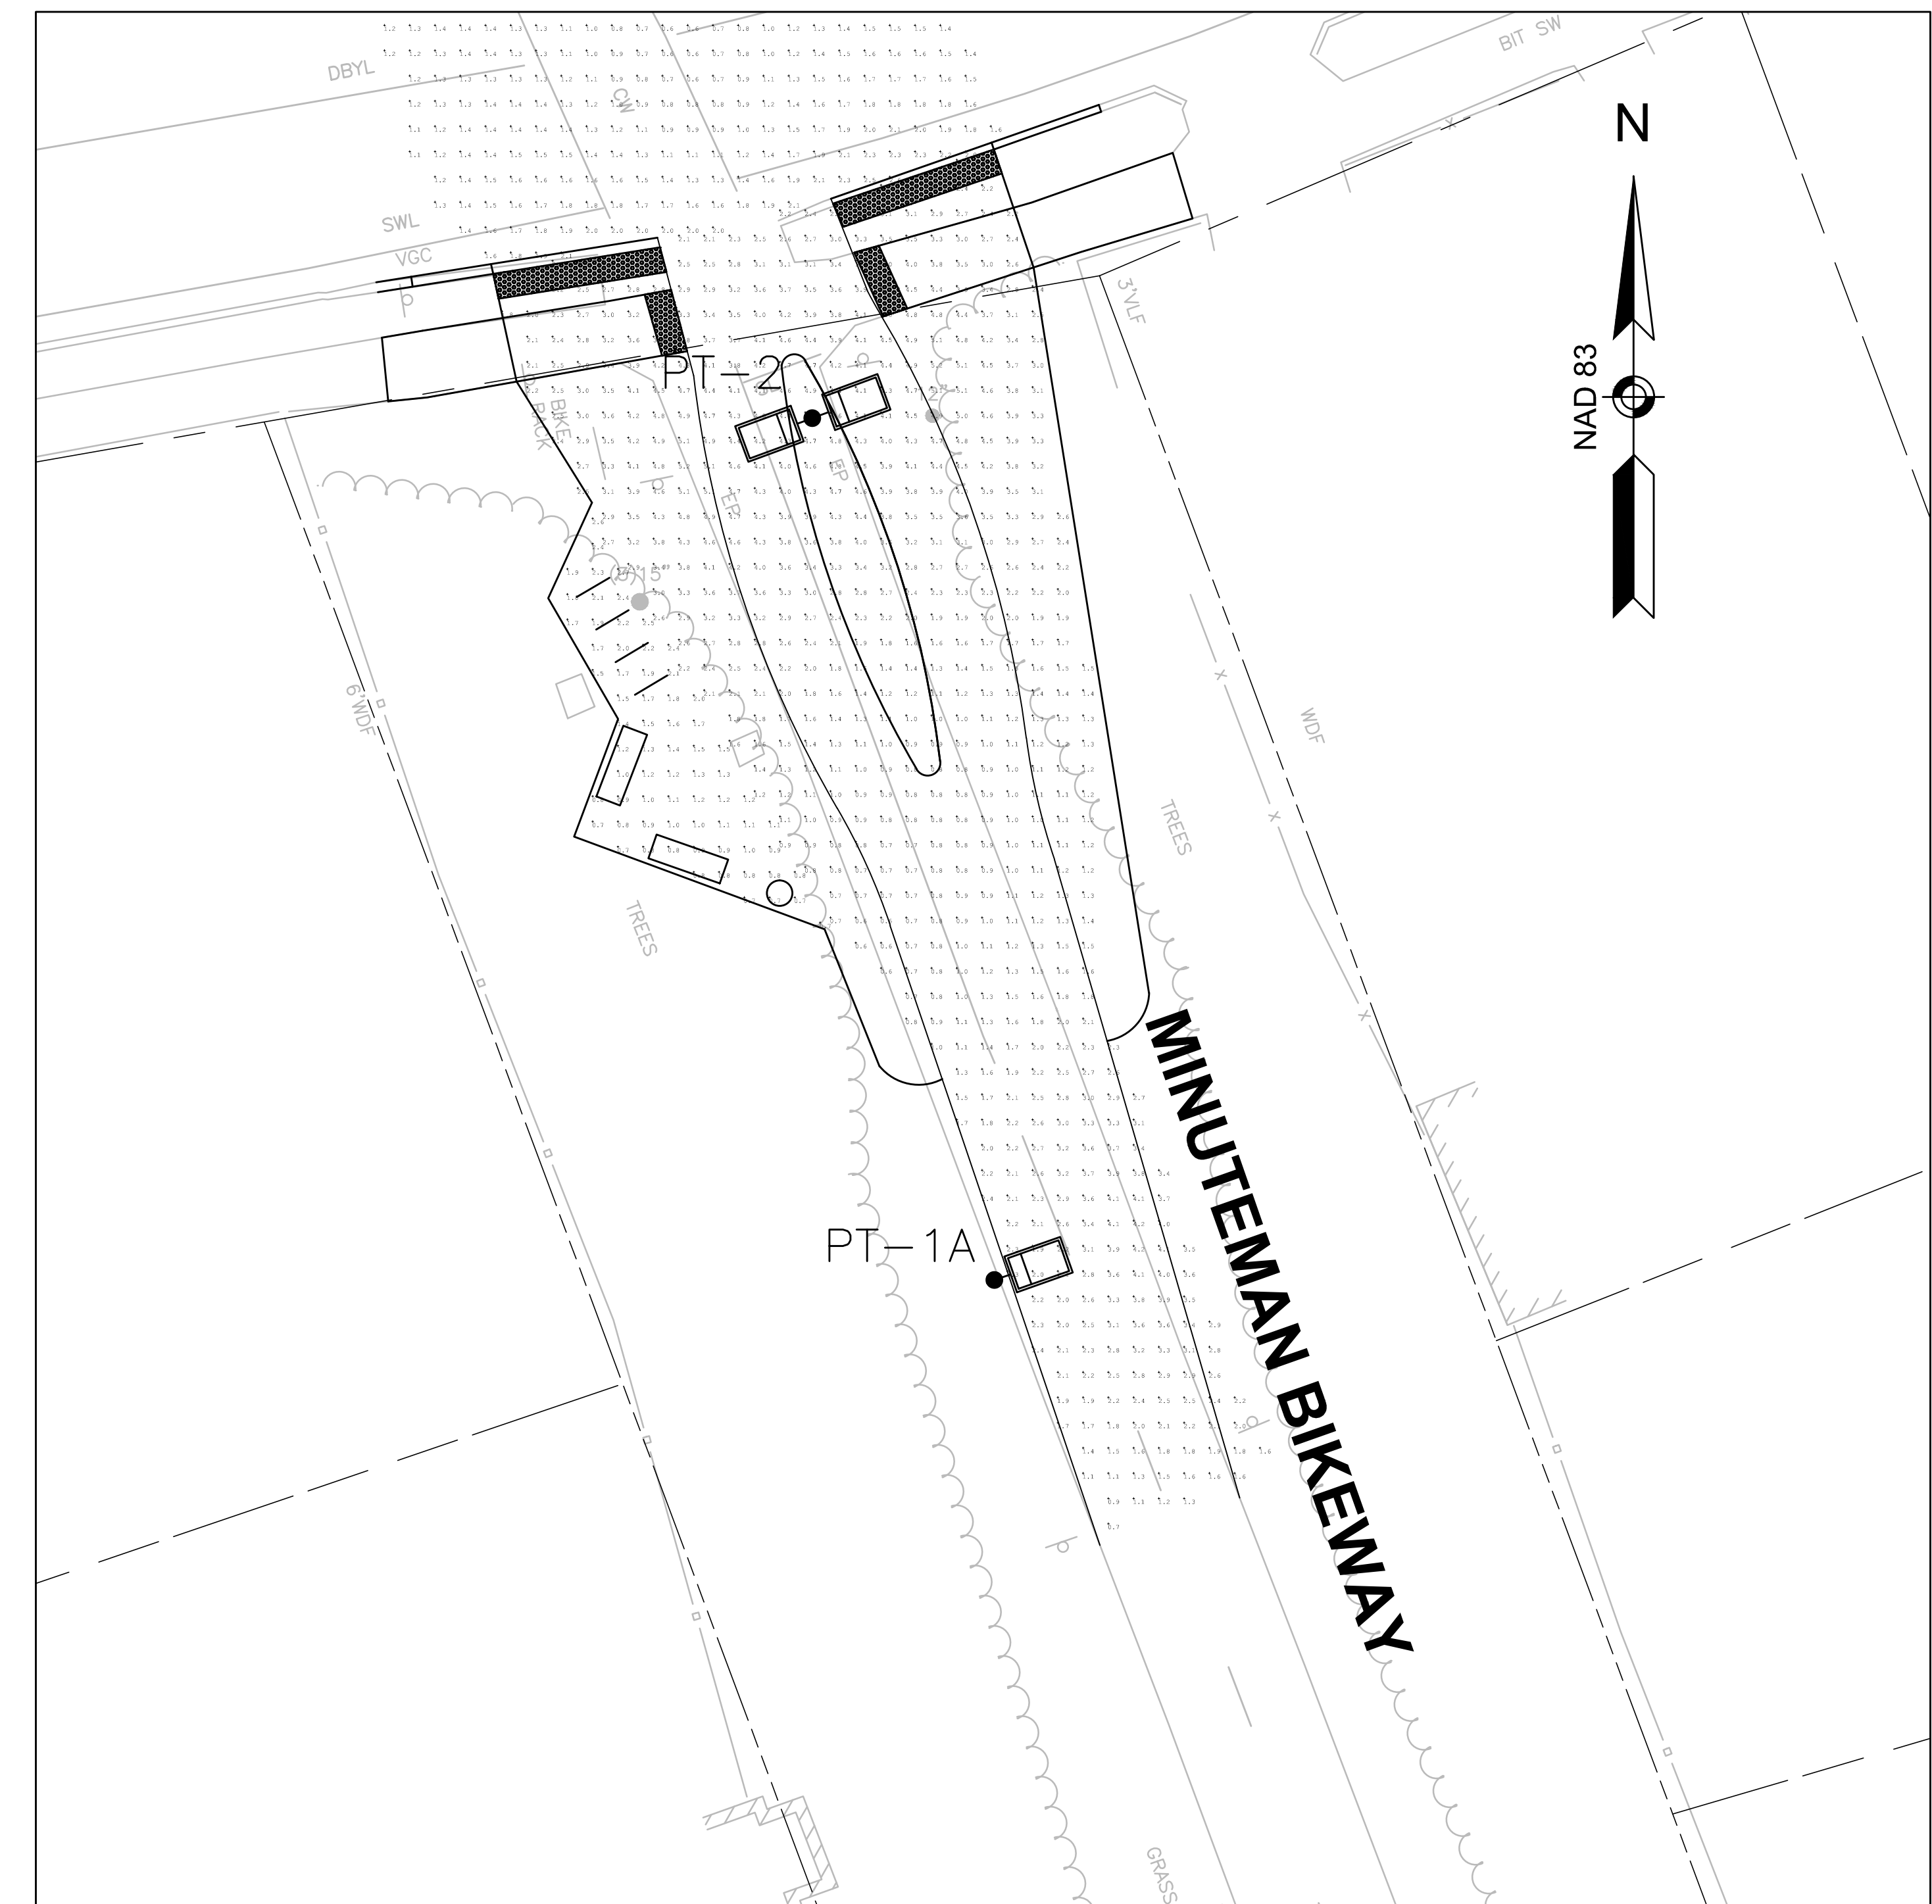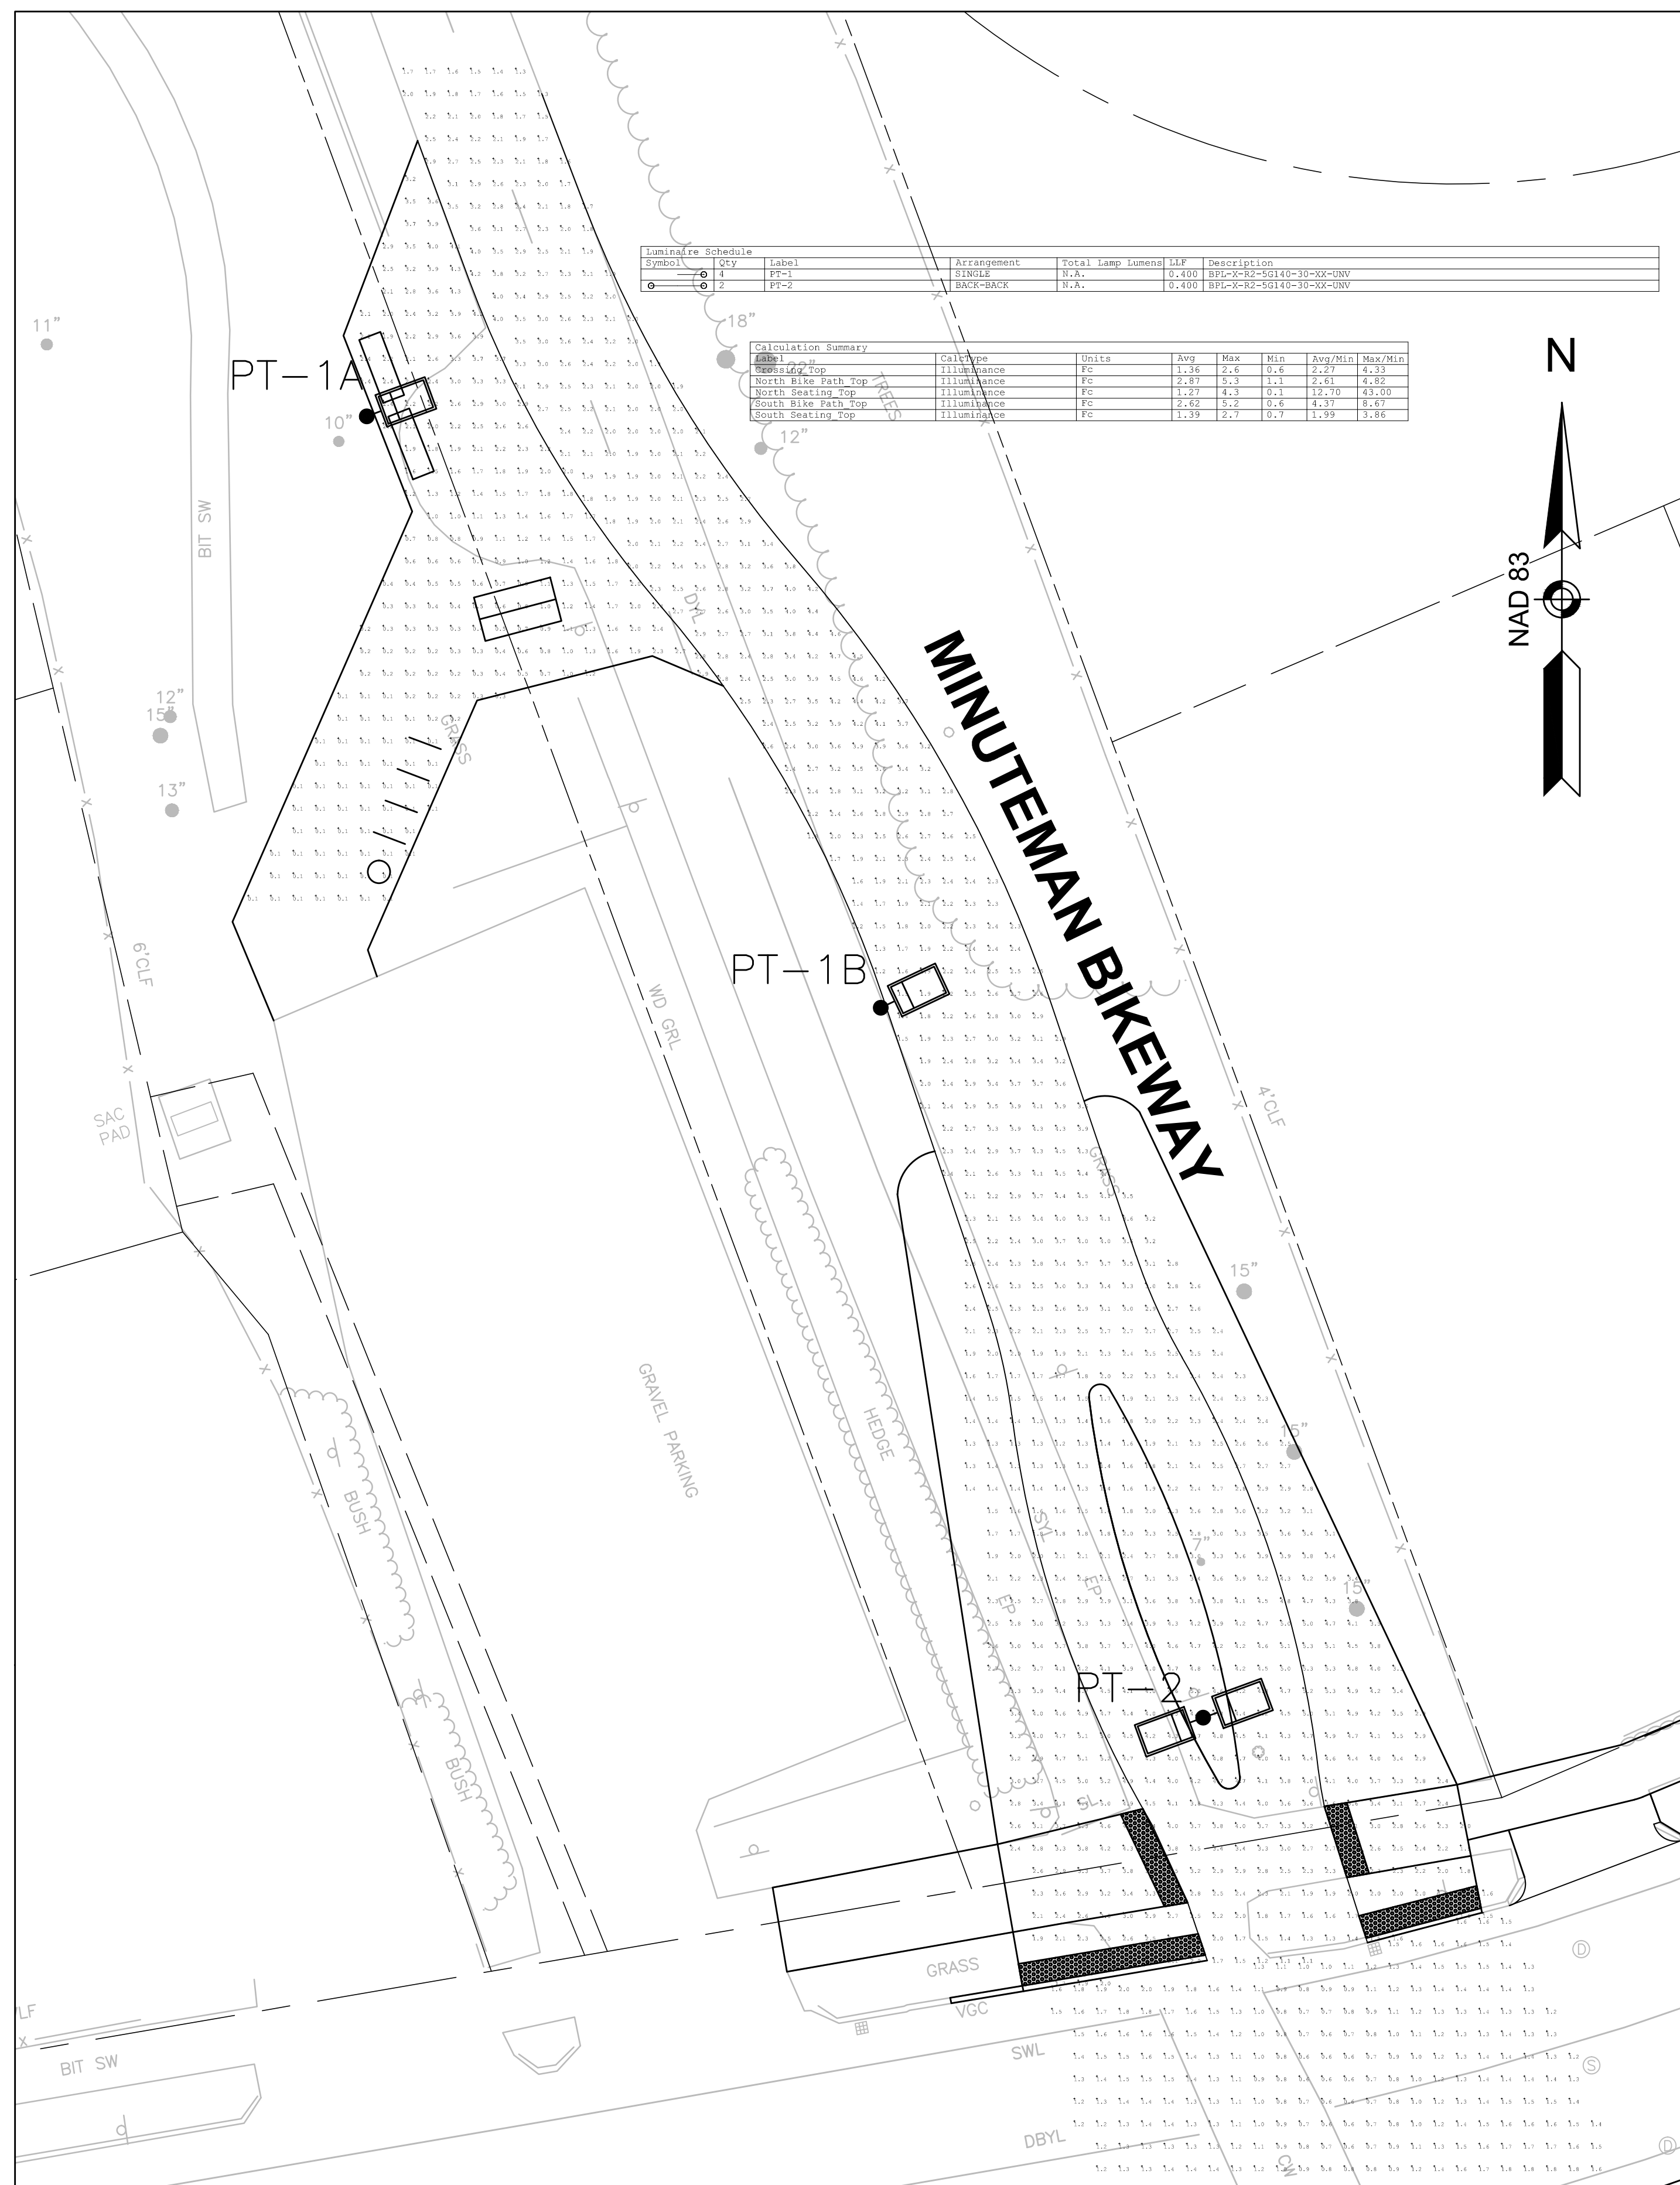


PROJECT: **MINUTEMAN BIKEWAY IMPROVEMENTS AT LAKE STREET**

DESIGN SUBMISSION: **DRAFT FINAL DESIGN**

DRAWING TITLE: **LIGHTING PHOTOMETRICS PLAN**

PREPARED FOR:
 **TOWN OF ARLINGTON**
 ENGINEERING DIVISION
 51 GROVE STREET
 ARLINGTON, MA 02476

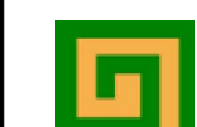PREPARED BY:
 **GREEN INTERNATIONAL AFFILIATES, INC.**
 Civil and Structural Engineers (978) 923-0400
 Westford, Massachusetts GreenIntl.com

SCALE: AS NOTED	DESIGNED BY: JG	SHEET NO. 24 OF 26
DATE: 09/15/2017	DRAWN BY: JG	
PROJECT NO. 17067.015	CHECKED BY: JS	


LIGHTING DESIGN SERVICES
 LUMEN STUDIO, INC.

ELECTRICAL WIRING DESIGN SERVICES
 ENGINEERING ADVANTAGE, INC.


NO.	DATE	REVISIONS




P:\Projects\2017\17067\CONCURRENT\DESIGN\LIGHTING\PLAN\Lighting_Photos\17067_24.dwg

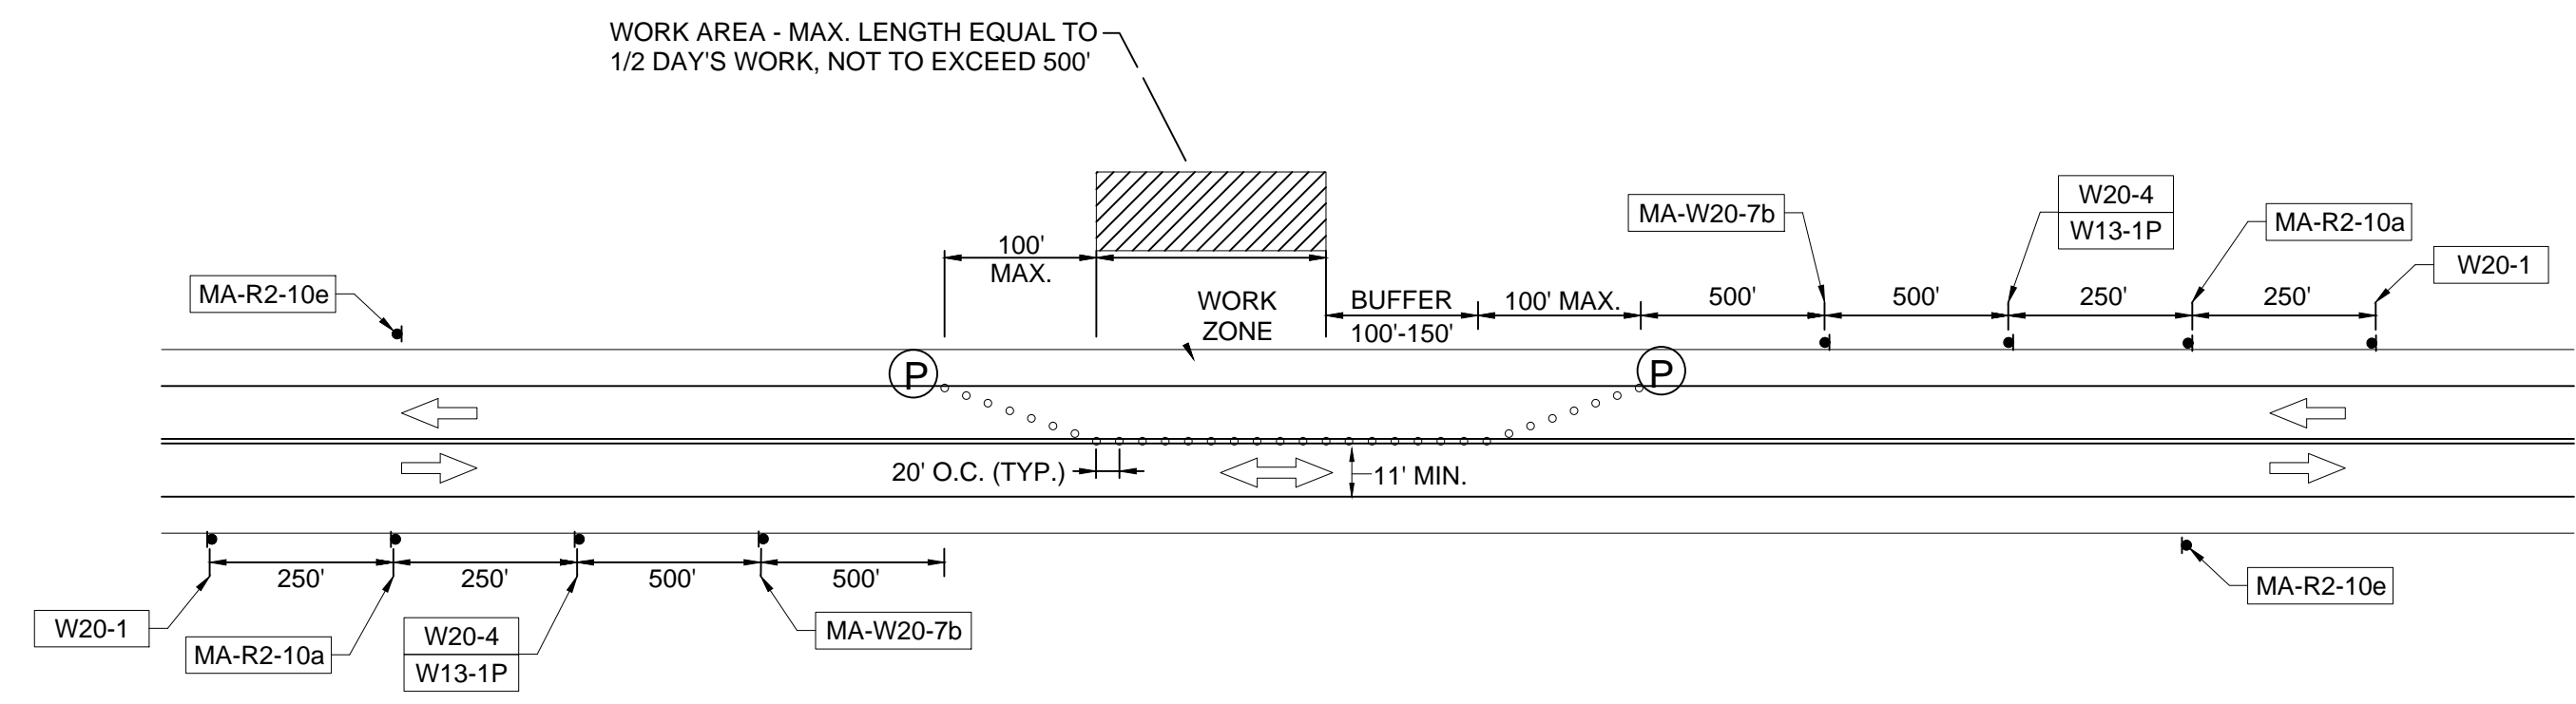

**TYPICAL APPLICATION - TWO LANE ROAD
ONE LANE ALTERNATING TRAFFIC**
NOT TO SCALE

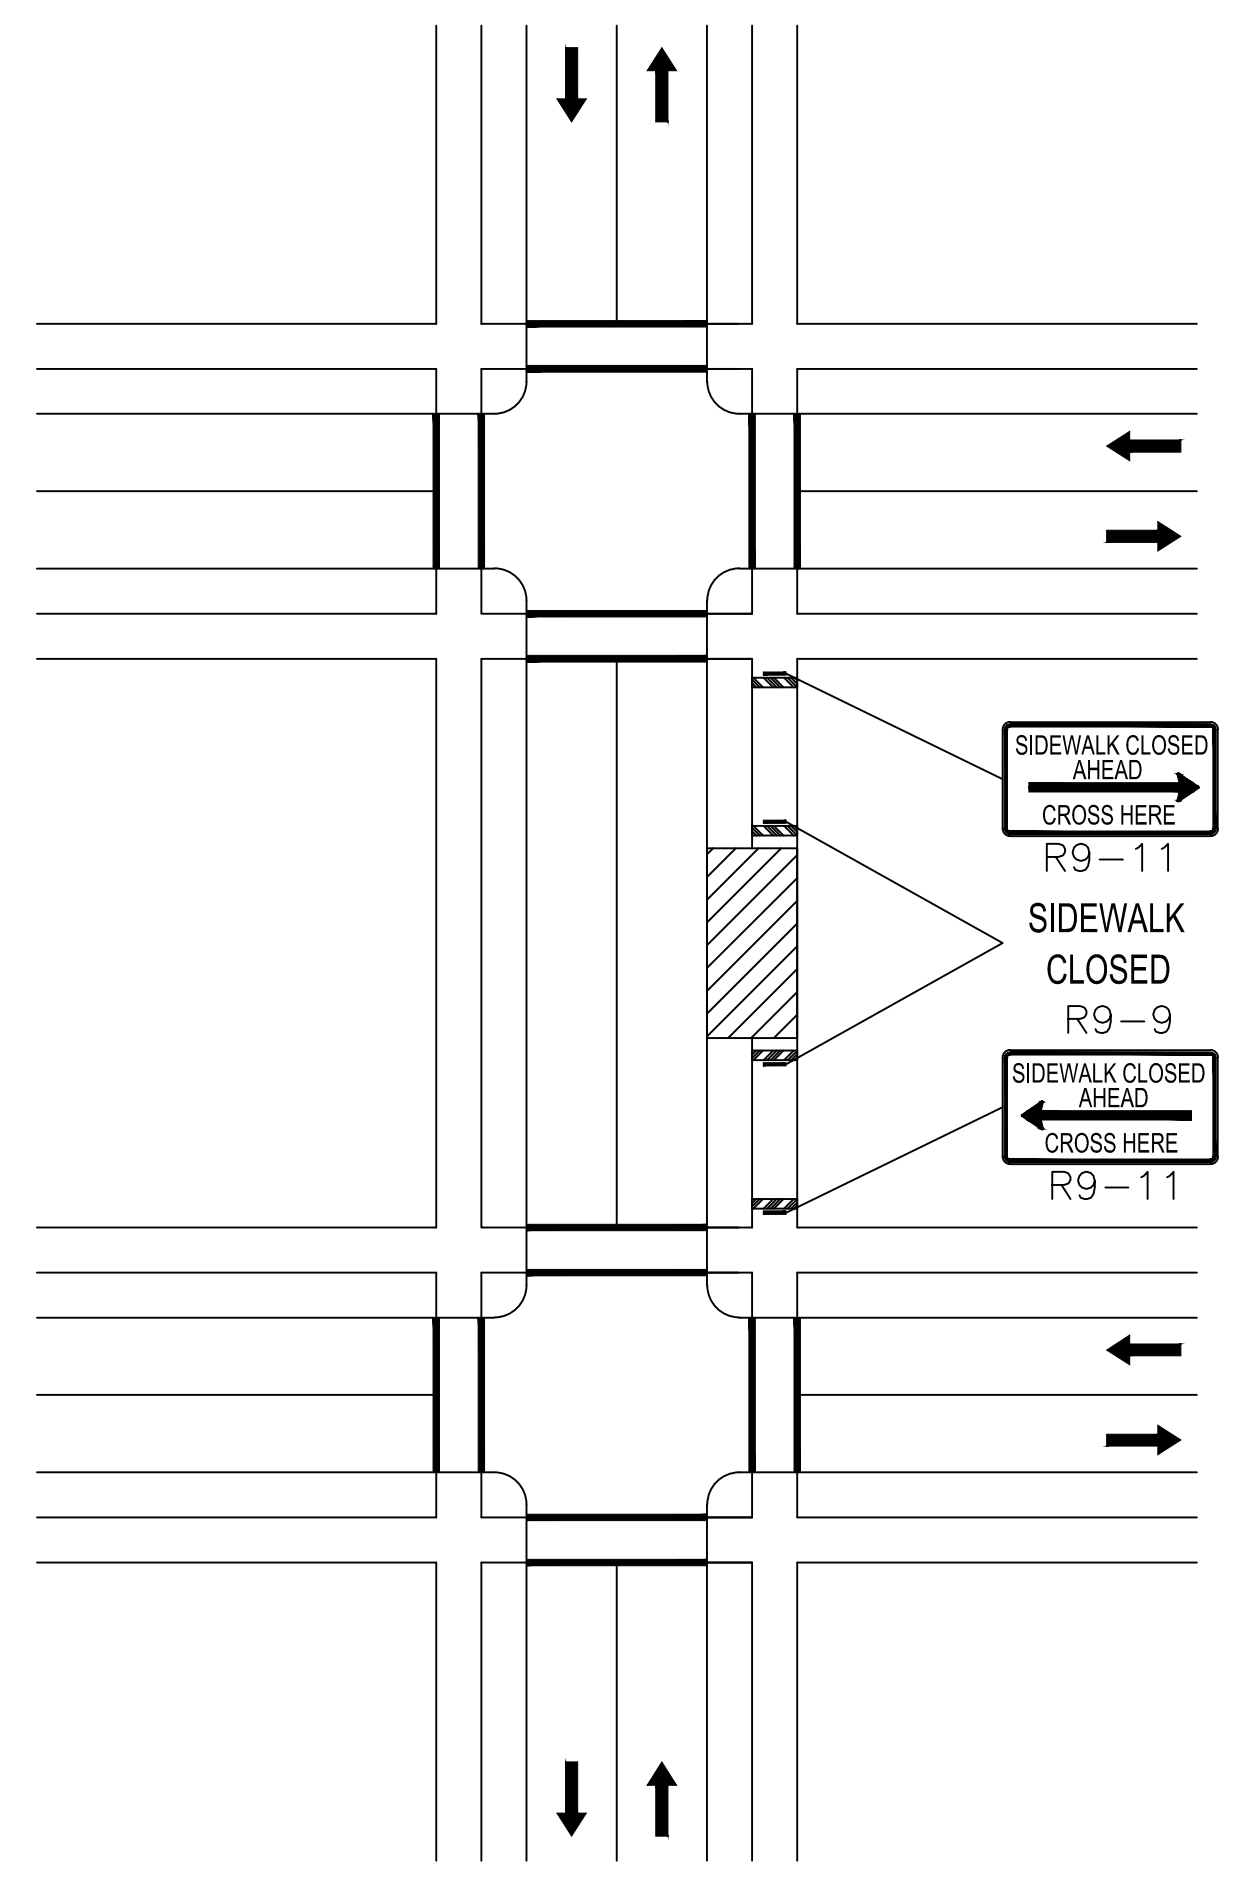

**SIDEWALK CLOSED
WITHOUT DETOUR**
NOT TO SCALE

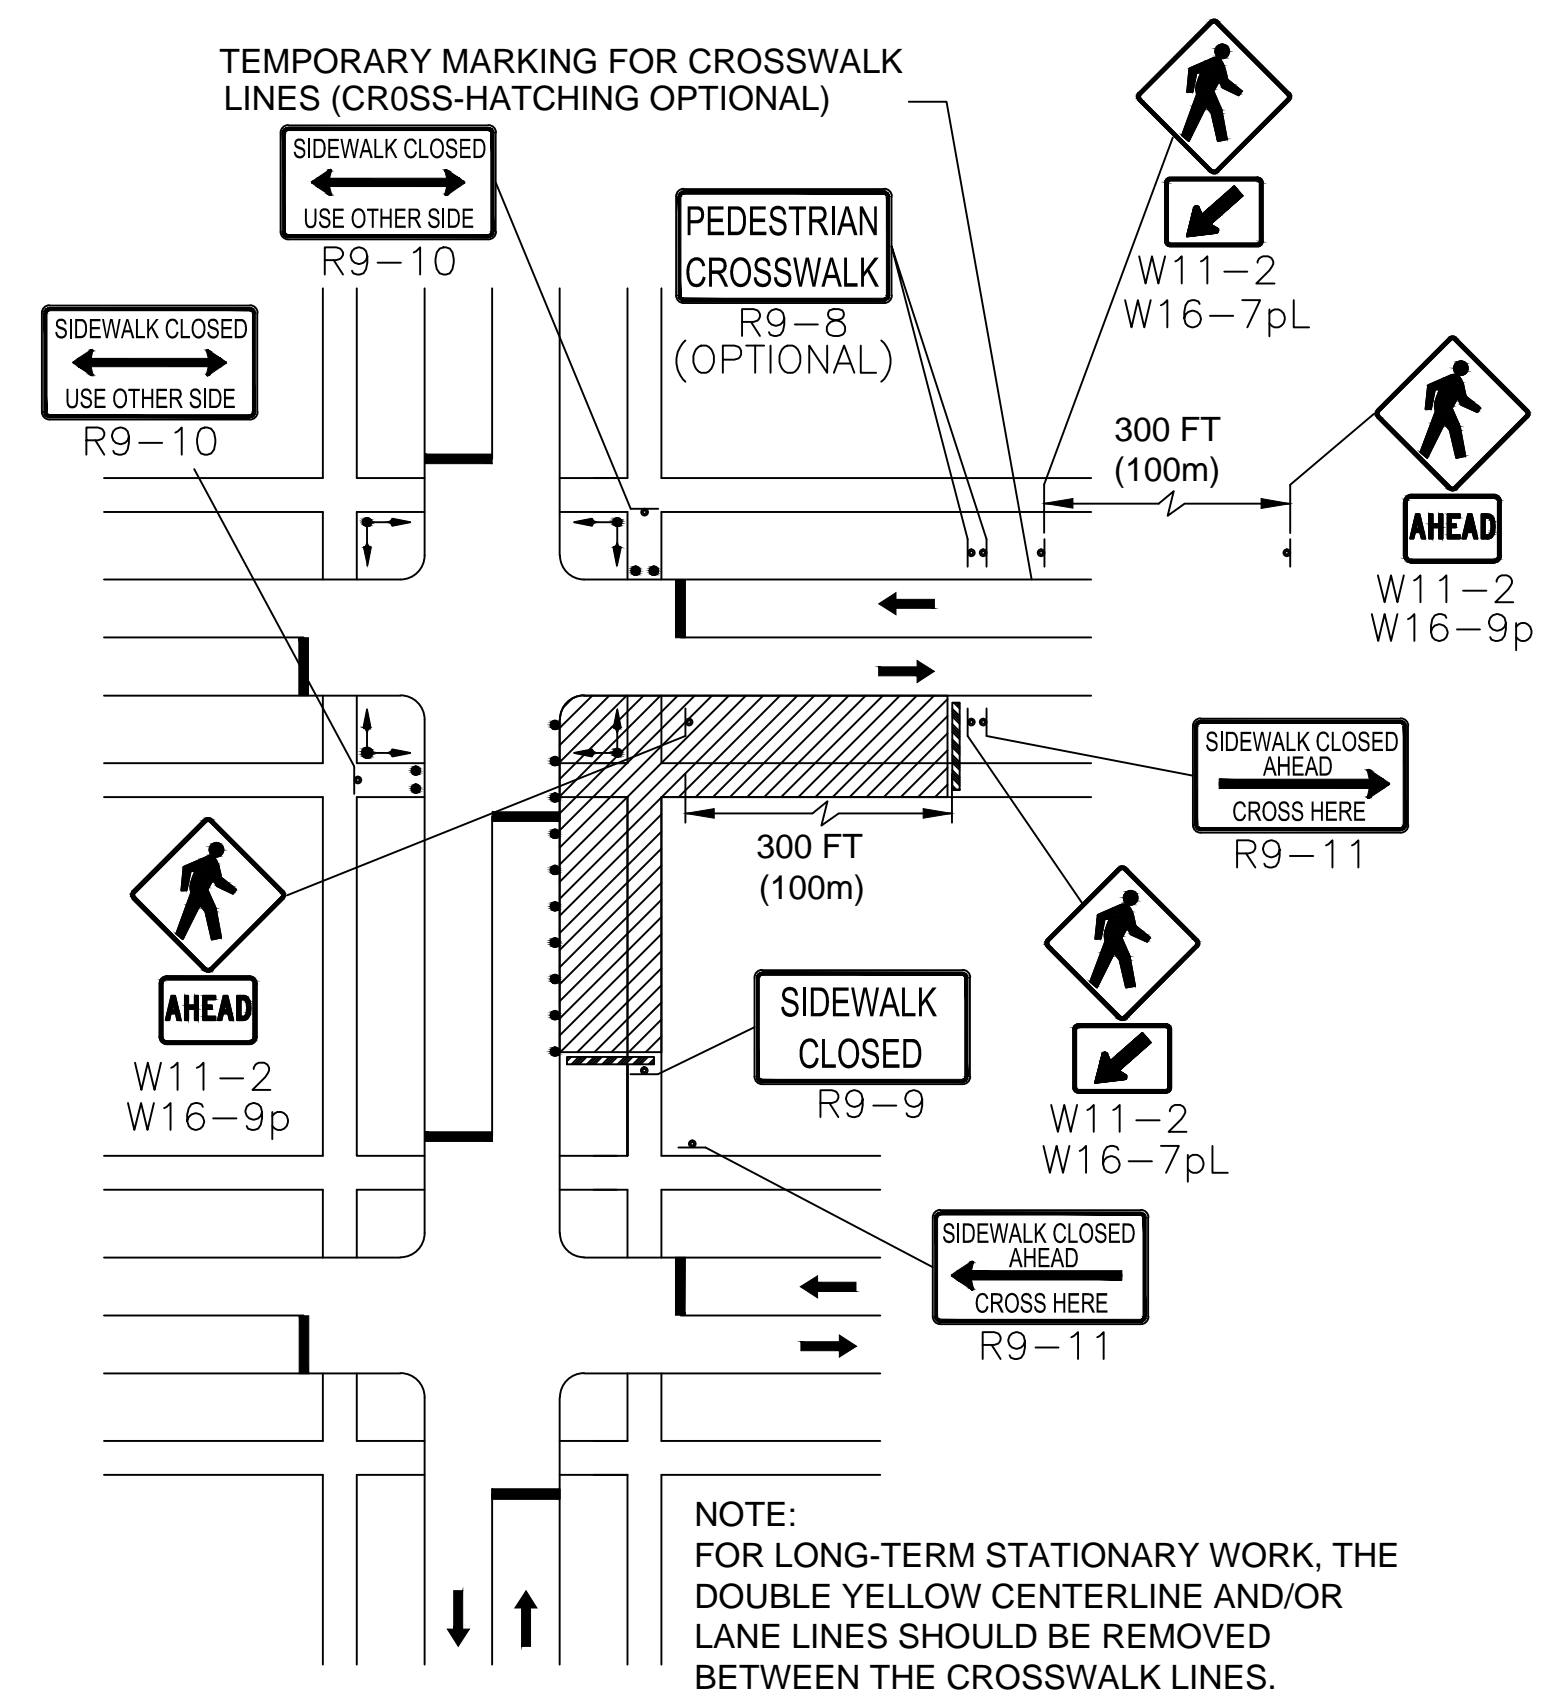


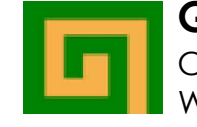
**PEDESTRIAN
DETOUR**
NOT TO SCALE

TEMPORARY TRAFFIC CONTROL NOTES:















1. MINIMUM LANE WIDTH OF 11 FEET SHALL BE MAINTAINED ALL THE TIME.
2. THESE PLANS ARE NOT INTENDED TO LIMIT THE CONTRACTOR'S APPROACH TO SCHEDULE THE WORK BUT TO OUTLINE ONE WAY OF PROGRESSING. THE CONTRACTOR IS EXPECTED TO USE KNOWLEDGE AND EXPERIENCE TO PERFORM THE WORK IN THE MOST EFFICIENT AND SAFE MANNER IN COMPLIANCE WITH THE DRAWINGS AND SPECIFICATIONS.
3. PLACE ALL SAFETY DEVICES AND CONSTRUCTION SIGNING BEFORE ACTUAL CONSTRUCTION WORK BEGINS.
4. DISTANCES ARE A GUIDE AND MAY BE ADJUSTED BASED ON FIELD CONDITIONS WITH THE APPROVAL OF THE ENGINEER.
5. EXISTING SIGNS NO LONGER APPLICABLE SHALL BE TEMPORARILY COVERED DURING CONSTRUCTION OR REMOVED AND RESET UPON COMPLETION OF CONSTRUCTION. THE COST SHALL BE INCIDENTAL TO THE CONTRACTOR.
6. SIGNS AND SIGN SUPPORTS LOCATED ON OR NEAR THE TRAVELED WAY MUST PASS THE CRITERIA SET FORTH IN THE NCHRP 350 REPORT.
7. TEMPORARY PAVEMENT MARKINGS, NO LONGER APPLICABLE, SHALL BE REMOVED. CONTRACTOR SHALL RECORD EXISTING PAVEMENT MARKINGS AND RESTORE ALL MARKINGS TO EXISTING CONDITIONS AT THE CONCLUSION OF CONSTRUCTION AT EACH LOCATION.
8. ALL TRAFFIC CONTROL DEVICES SHALL BE REMOVED IMMEDIATELY WHEN NO LONGER NEEDED.
9. UNLESS OTHERWISE NOTED, ALL PAVEMENT MARKINGS, SIGNS AND OTHER TRAFFIC EQUIPMENT REMOVED OR DAMAGED AS A RESULT OF THE CONTRACTOR'S OPERATIONS SHALL BE REPLACED IN CONFORMANCE WITH THE CONTACT DOCUMENTS.
10. CONTRACTOR SHALL INSTALL, RENEW AND MAINTAIN ALL TRAFFIC CONTROL DEVICES AS SHOWN ON THE DRAWINGS IN ACCORDANCE WITH THE CONTRACT DOCUMENTS.
11. ACCESS/EGRESS TO ALL ABUTTERS SHALL BE MAINTAINED AT ALL TIMES DURING CONSTRUCTION. CONTRACTOR SHALL MAINTAIN EMERGENCY PASSAGE AT ALL TIMES TO BUILDINGS WITHIN AND ADJACENT TO THE PROJECT LIMITS AS WELL AS A LARGER AREA IF AFFECTED BY CONSTRUCTION CONDITIONS. CONTRACTOR SHALL MAINTAIN 24 HOUR EMERGENCY VEHICLE ACCESS TO CONSTRUCTION AREAS.
12. SIDEWALK ACCESS SHALL BE MAINTAINED AT ALL TIMES ON AT LEAST ONE SIDE OF THE STREET
13. CONTRACTOR SHALL COORDINATE WITH ABUTTERS FOR THE PROPOSED WORK AND SHALL NOTIFY EACH ABUTTER AT LEAST 24 HOURS IN ADVANCE OF THE START OF THE WORK THAT WILL REQUIRE TEMPORARY CLOSURE OF ACCESS TO THEIR PROPERTY.
14. THE CONTRACTOR SHALL COORDINATE THE WORK WITH ALL ABUTTING PROJECTS.

NOTE: IF A MINIMUM WIDTH OF 48" OF SOLID SMOOTH UNOBSTRUCTED SURFACE REMAINS ALONG THE WORK AREA THEN THE DETAIL CAN BE DISREGARDED. DELINEATION OF THE WORK AREA WILL STILL BE REQUIRED. ALL PEDESTRIAN DETOUR ROUTES SHALL BE ADA/MAAB COMPLIANT IN THEIR ENTIRETY.

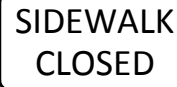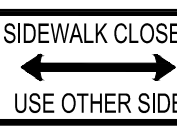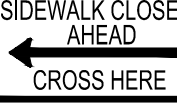P:\PROJECTS\2017\CONCURRENT DESIGN\TRAFFIC MANAGEMENT PLAN.dwg, Penum, FILED 01/13/18, PM

PROJECT: MINUTEMAN BIKEWAY IMPROVEMENTS AT LAKE STREET	
DESIGN SUBMISSION: DRAFT FINAL DESIGN	
DRAWING TITLE: TRAFFIC MANAGEMENT PLAN 1	
PREPARED FOR:  TOWN OF ARLINGTON ENGINEERING DIVISION 51 GROVE STREET ARLINGTON, MA 02476	
PREPARED BY:  GREEN INTERNATIONAL AFFILIATES, INC. Civil and Structural Engineers (978) 923-0400 Westford, Massachusetts GreenIntl.com	
LIGHTING DESIGN SERVICES LUMEN STUDIO, INC.	SCALE: AS NOTED
ELECTRICAL WIRING DESIGN SERVICES ENGINEERING ADVANTAGE, INC.	DESIGNED BY: JG
	DATE: 09/15/2017
	DRAWN BY: JG
	CHECKED BY: JS
	PROJECT NO. 17067.015
	NO. DATE REVISIONS
	SHEET NO. 25 OF 26


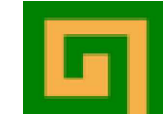
CONSTRUCTION SIGN SUMMARY

IDENTIFICATION NUMBER	SIZE OF SIGN (INCHES)		TEXT	TEXT DIMENSIONS (INCHES)			COLOR			POST SIZE AND NUMBER REQUIRED	NUMBER OF SIGNS REQUIRED	UNIT AREA (S.F.)	TOTAL AREA (S.F.)
	WIDTH	HEIGHT		LETTER HEIGHT	VERTICAL SPACING	ARROW RTE. MKR.	BACK-GROUND	LEGEND	BORDER				
MA-R2-10a	48	36		SEE MASSDOT STANDARD DETAIL			SEE MASSDOT STD. DETAIL			MASSDOT SPEC. MOUNT ON POST	2	12.00	24.00
MA-R2-10e	36	48									2	12.00	24.00
MA-W20-7b	36	36									2	9.00	18.00
R9-8	36	18		SEE MUTCD STANDARD DETAIL			SEE MUTCD STD. DETAIL			MUTCD SPEC. MOUNT ON POST	2	4.50	9.00
R9-9	24	12									2	2.00	4.00
R9-10	24	12									2	2.00	4.00
R9-11L	24	18									2	3.00	6.00
R9-11R	24	18									2	3.00	6.00
W11-2	30	30									4	6.25	25.00
W16-7P	24	12									2	2.00	4.00
W16-9P	24	12									2	2.00	4.00
W13-1P	24	24									2	4.00	8.00
W20-1	36	36									2	9.00	18.00
W20-4	36	36									2	9.00	18.00
											297.50		

NOTES:

- SEE THE 2009 "MANUAL ON UNIFORM TRAFFIC CONTROL DEVICES" (MUTCD) AND ITS REVISIONS, THE 2012 MASSACHUSETTS AMENDMENTS TO THE 2009 MUTCD, AND THE STANDARD MUNICIPAL TRAFFIC CODE FOR LATEST SPECIFICATION ON TEXT, DIMENSIONS AND COLOR. ALSO REFER TO 2015 MASSACHUSETTS DEPARTMENT OF TRANSPORTATION SUPPLEMENTAL SPECIFICATIONS.
- UNLESS OTHERWISE NOTED, ALL POSTS TO BE P-5.

PROJECT:	MINUTEMAN BIKEWAY IMPROVEMENTS AT LAKE STREET
DESIGN SUBMISSION:	DRAFT FINAL DESIGN
DRAWING TITLE:	TRAFFIC MANAGEMENT PLAN 2

LIGHTING DESIGN SERVICES LUMEN STUDIO, INC. ELETRICAL WIRING DESIGN SERVICES ENGINEERING ADVANTAGE, INC.	PREPARED FOR:  TOWN OF ARLINGTON ENGINEERING DIVISION 51 GROVE STREET ARLINGTON, MA 02476															
<table border="1" style="width: 100%; border-collapse: collapse;"> <tr><td style="width: 10%;">NO.</td><td style="width: 10%;">DATE</td><td style="width: 80%;">REVISIONS</td></tr> <tr><td> </td><td> </td><td> </td></tr> <tr><td> </td><td> </td><td> </td></tr> <tr><td> </td><td> </td><td> </td></tr> <tr><td> </td><td> </td><td> </td></tr> </table>	NO.	DATE	REVISIONS													PREPARED BY:  GREEN INTERNATIONAL AFFILIATES, INC. Civil and Structural Engineers (978) 923-0400 Westford, Massachusetts GreenIntl.com
NO.	DATE	REVISIONS														
SCALE: AS NOTED	DESIGNED BY: JG	SHEET NO. 26 OF 26														
DATE: 09/15/2017	DRAWN BY: JG	PROJECT NO. 17067.015														
	CHECKED BY: JS															