

Town of Arlington, Massachusetts

MILL BROOK CORRIDOR & WELLINGTON PARK REVITALIZATION PROJECT

35 Grove Street Arlington, Massachusetts

TOWN OF ARLINGTON, MASSACHUSETTS

ADAM W. CHAPDELAINE TOWN MANAGER 730 MASSACHUSETTS AVE ARLINGTON, MASSACHUSETTS, 02476 PHONE: 781-316-3010



FOR ILLUSTRATIVE PURPOSES ONL

SHEET INDEX


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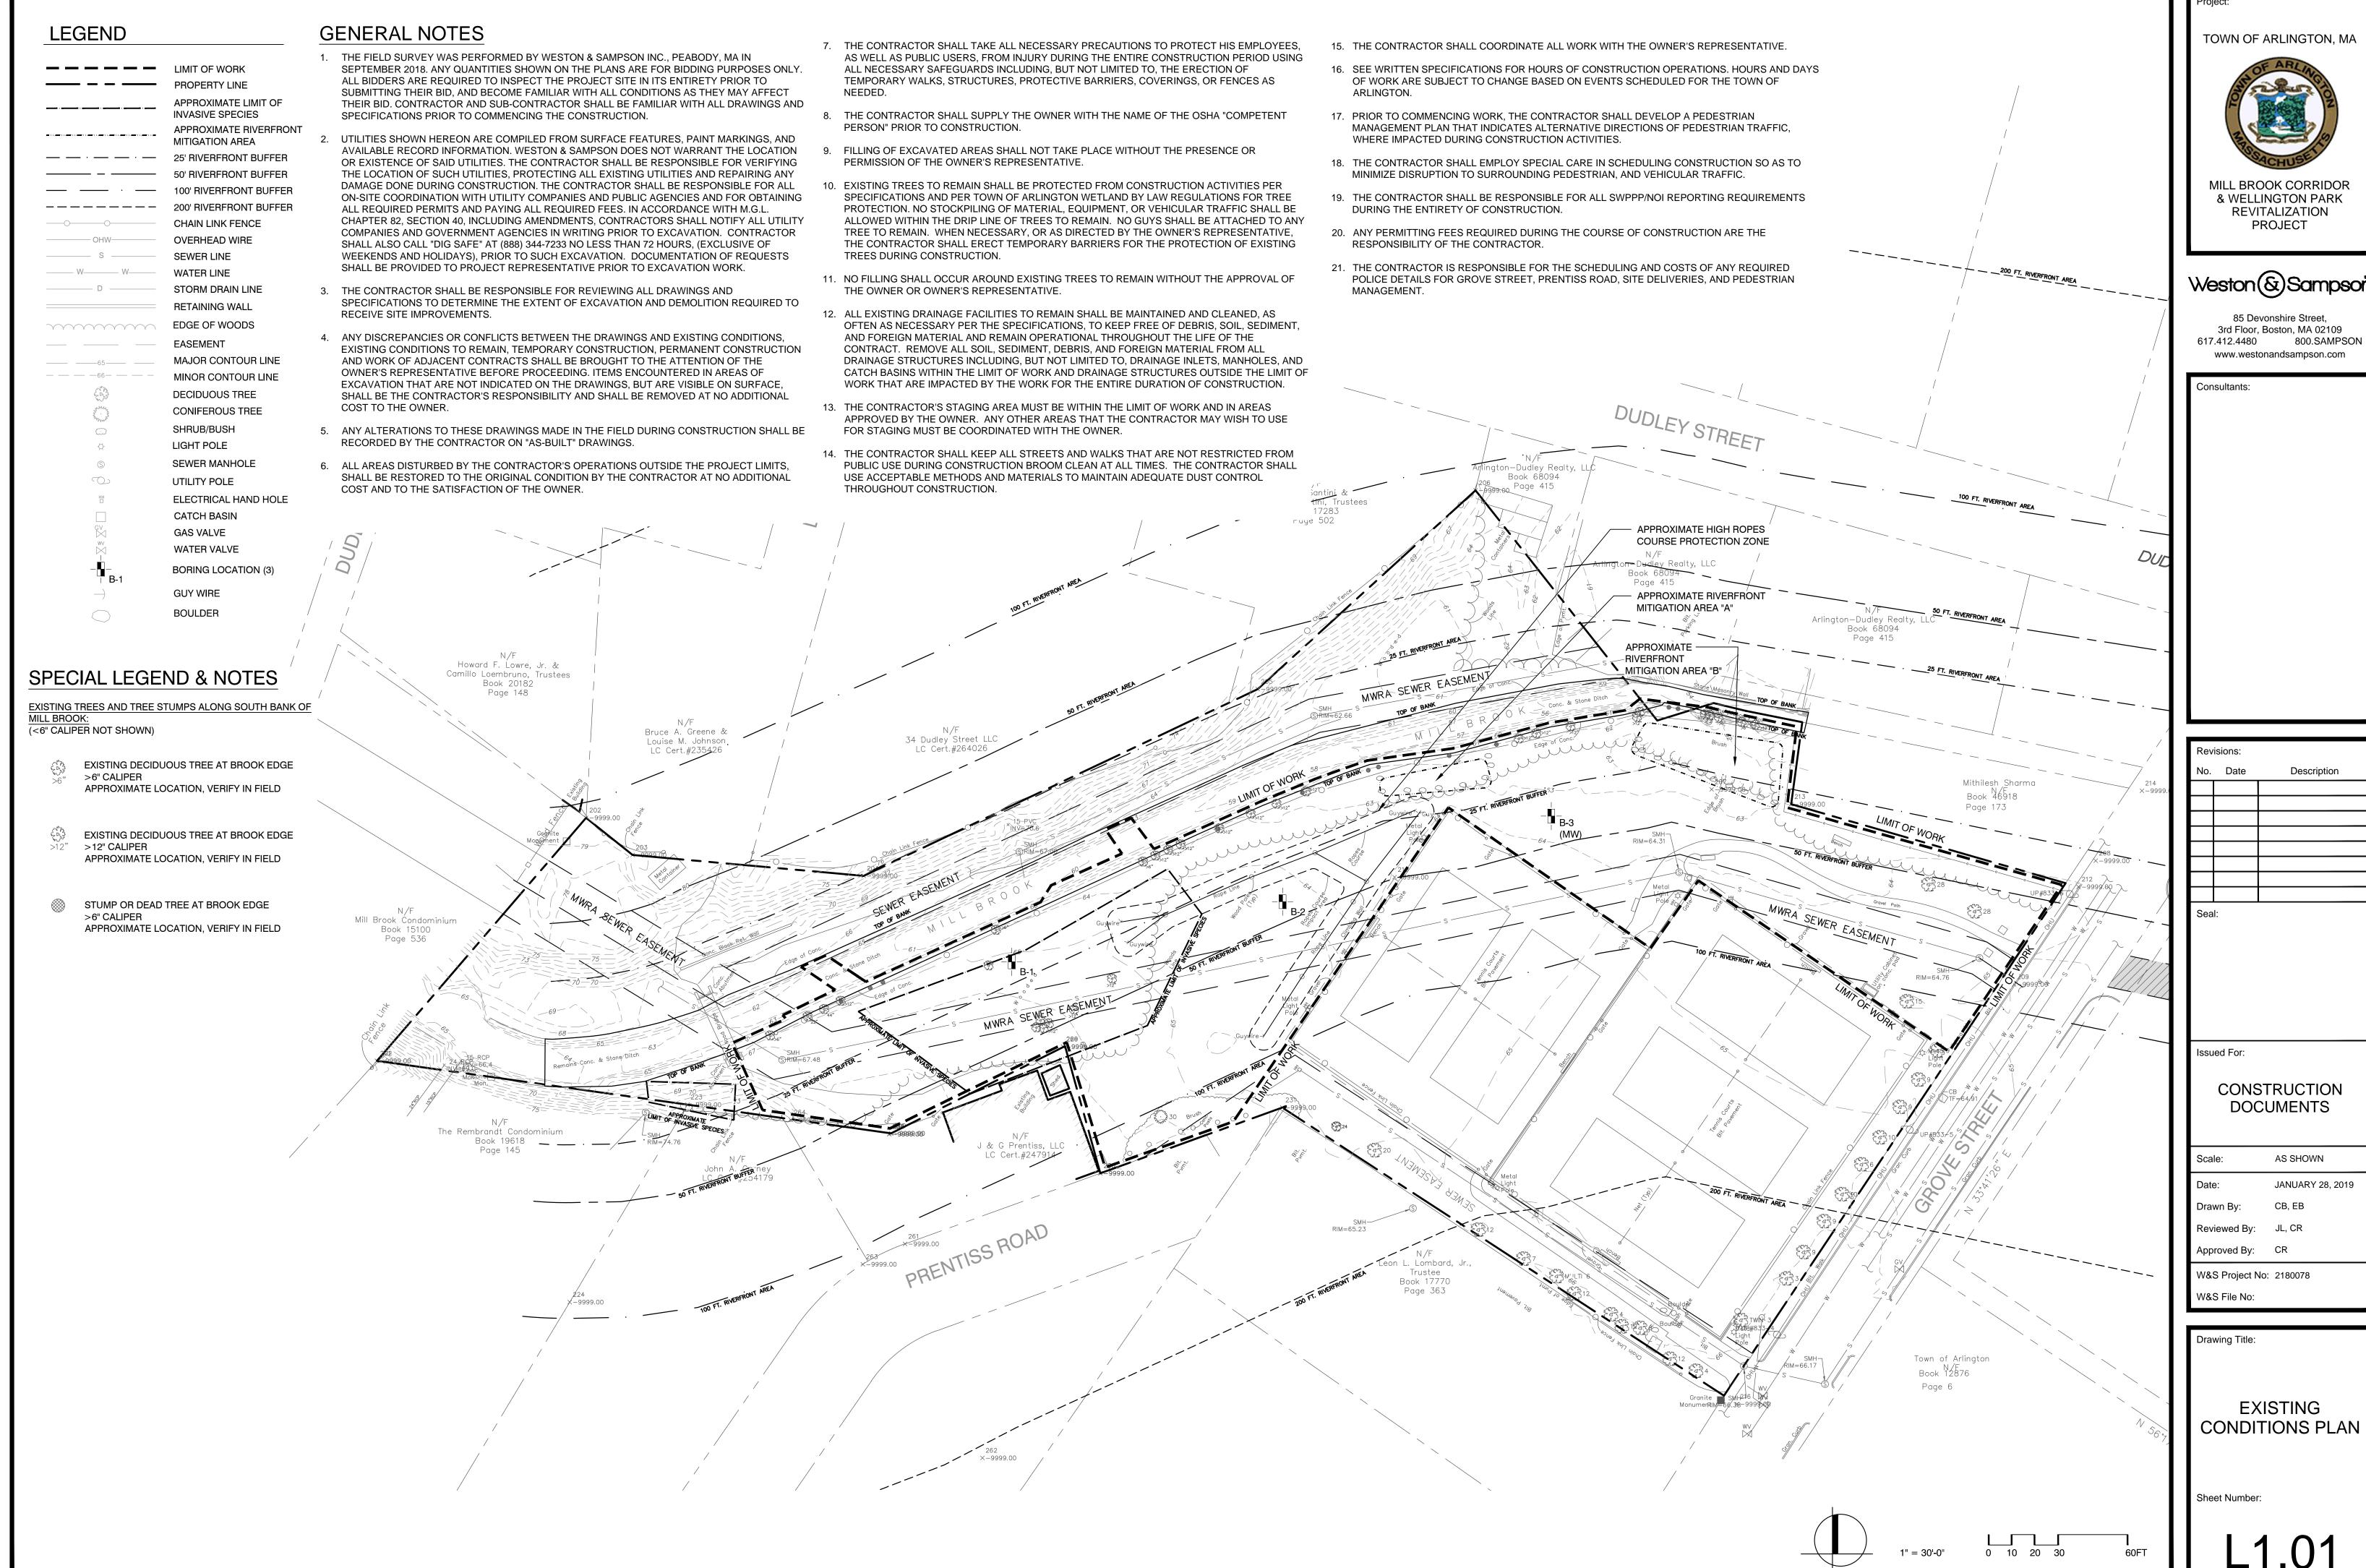


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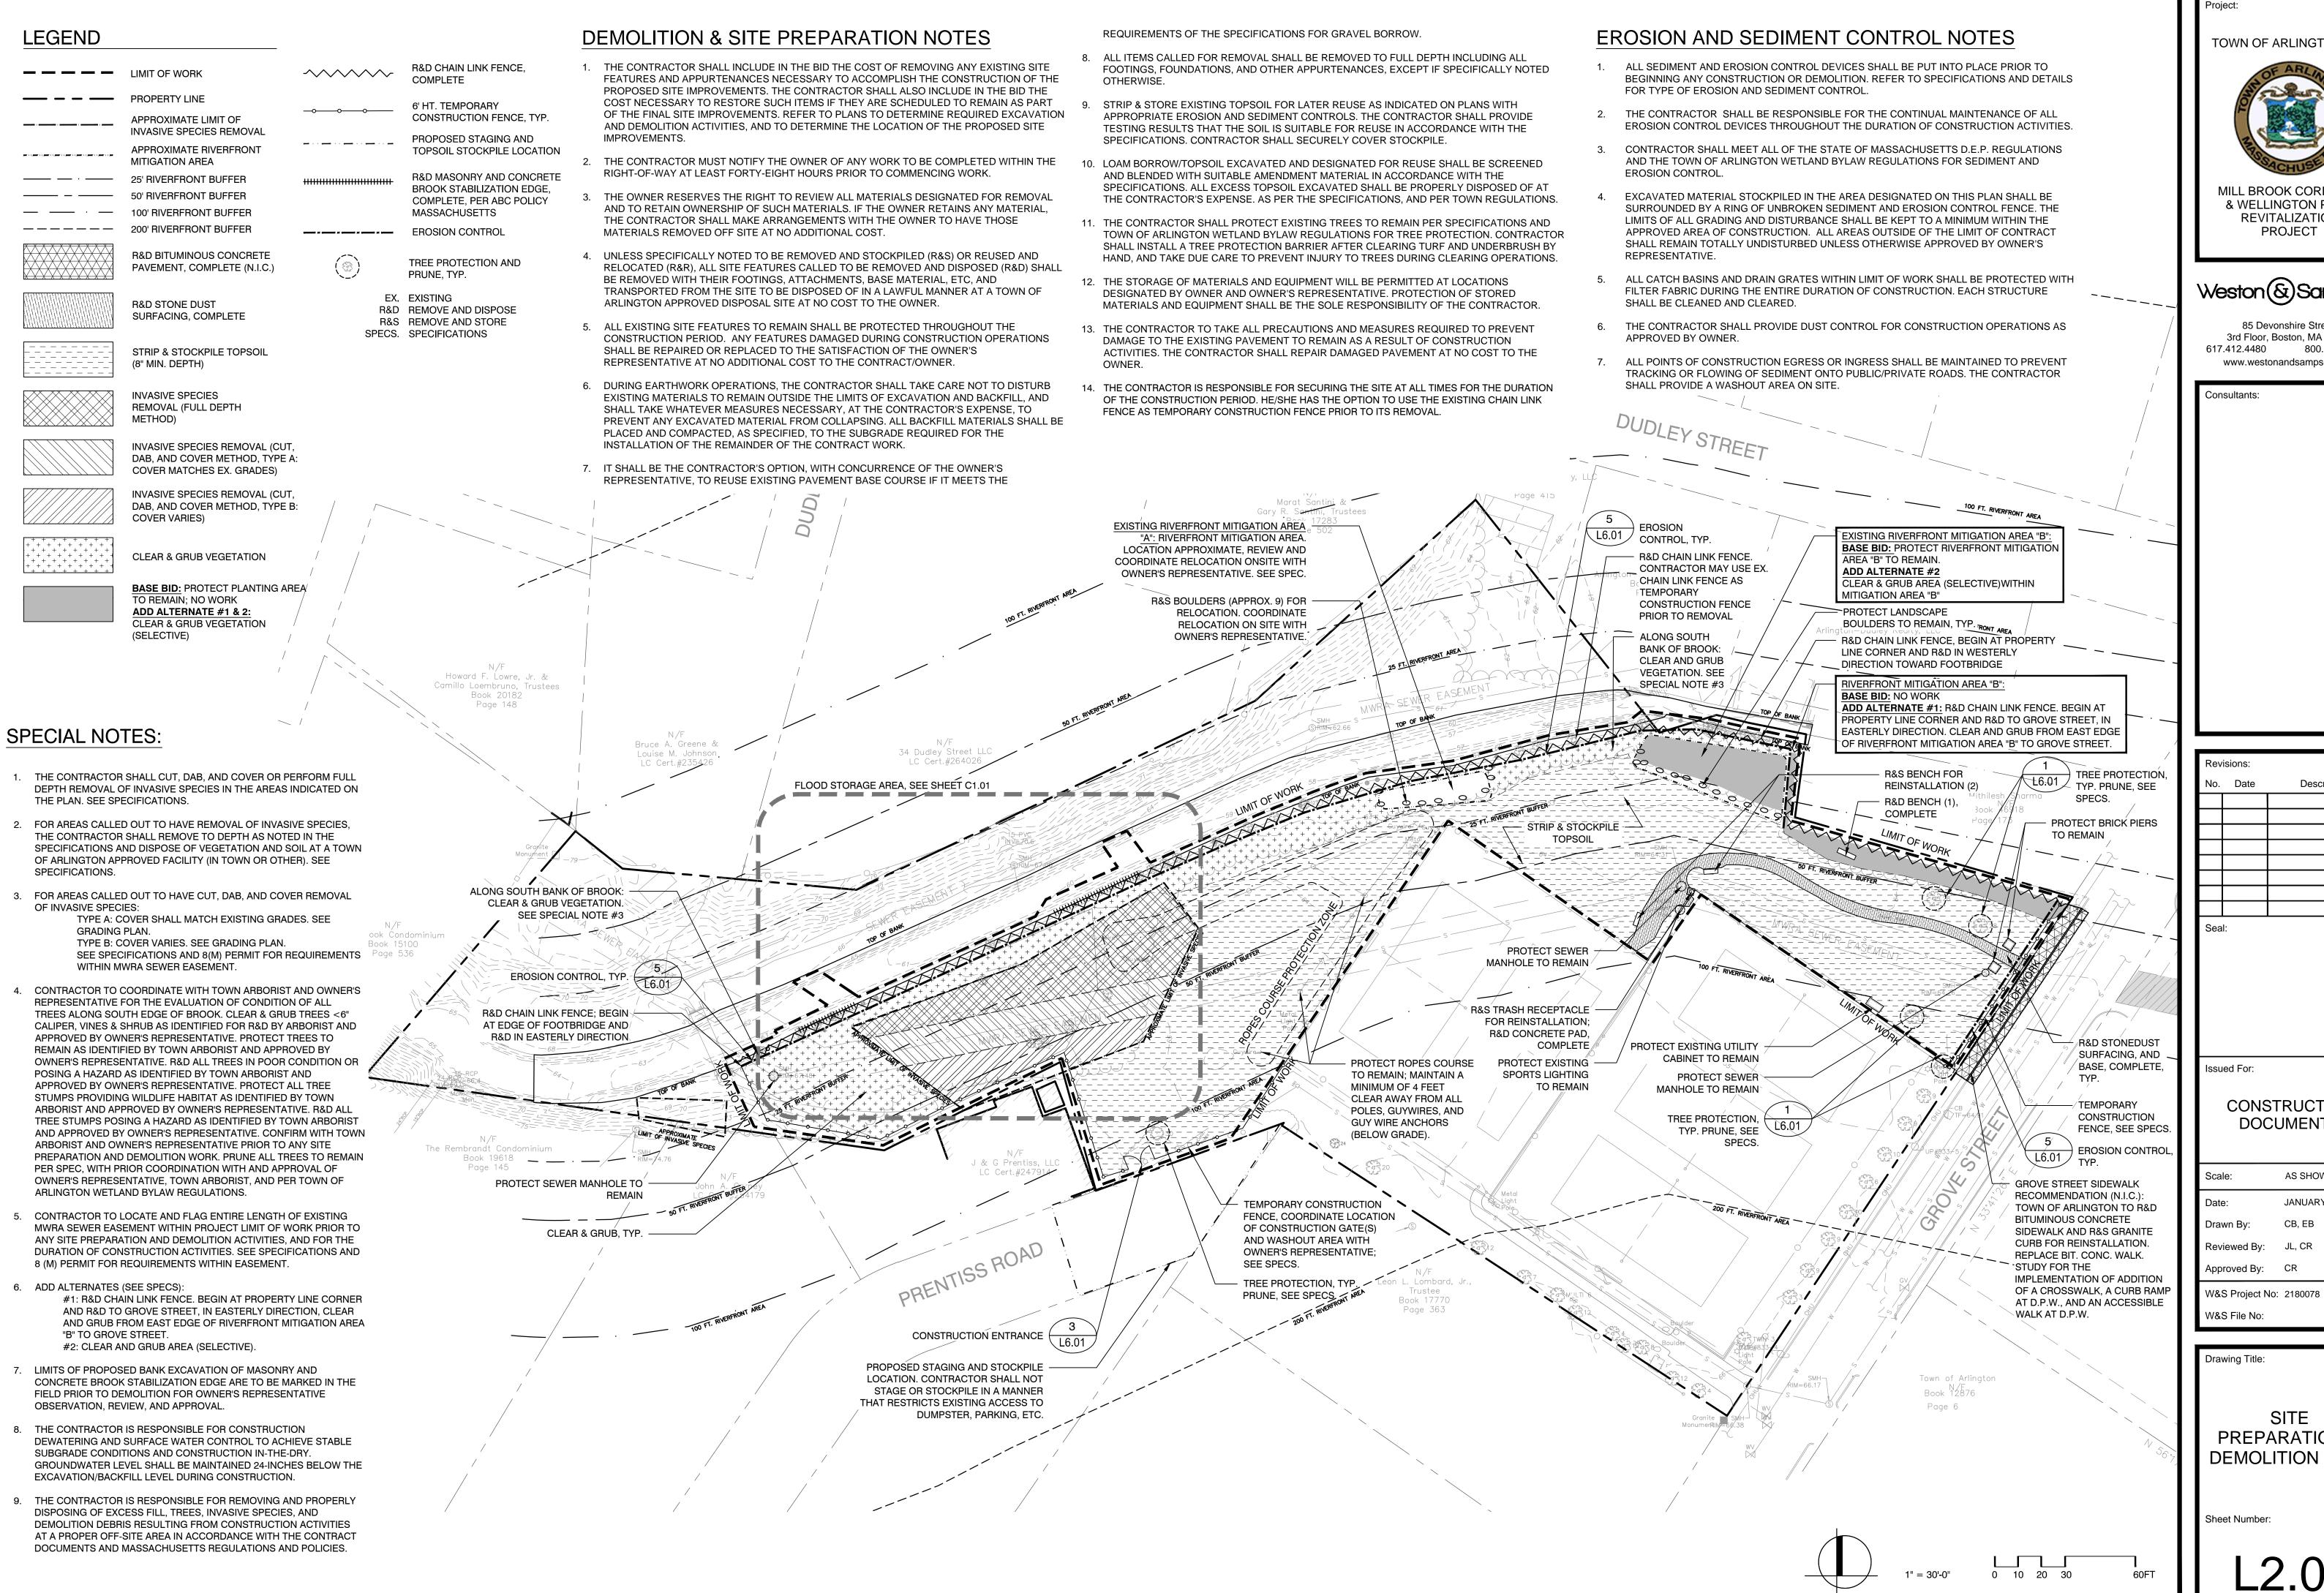


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800.SAMPSON



TOWN OF ARLINGTON, MA

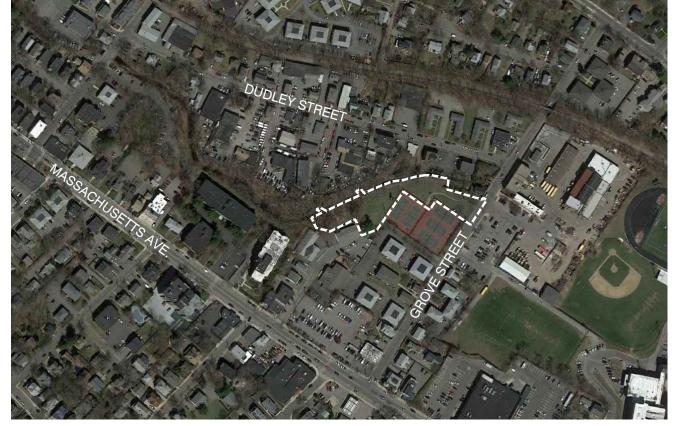

MILL BROOK CORRIDOR & WELLINGTON PARK REVITALIZATION **PROJECT**

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Issued For: CONSTRUCTION

Description

AS SHOWN JANUARY 28, 2019

DOCUMENTS


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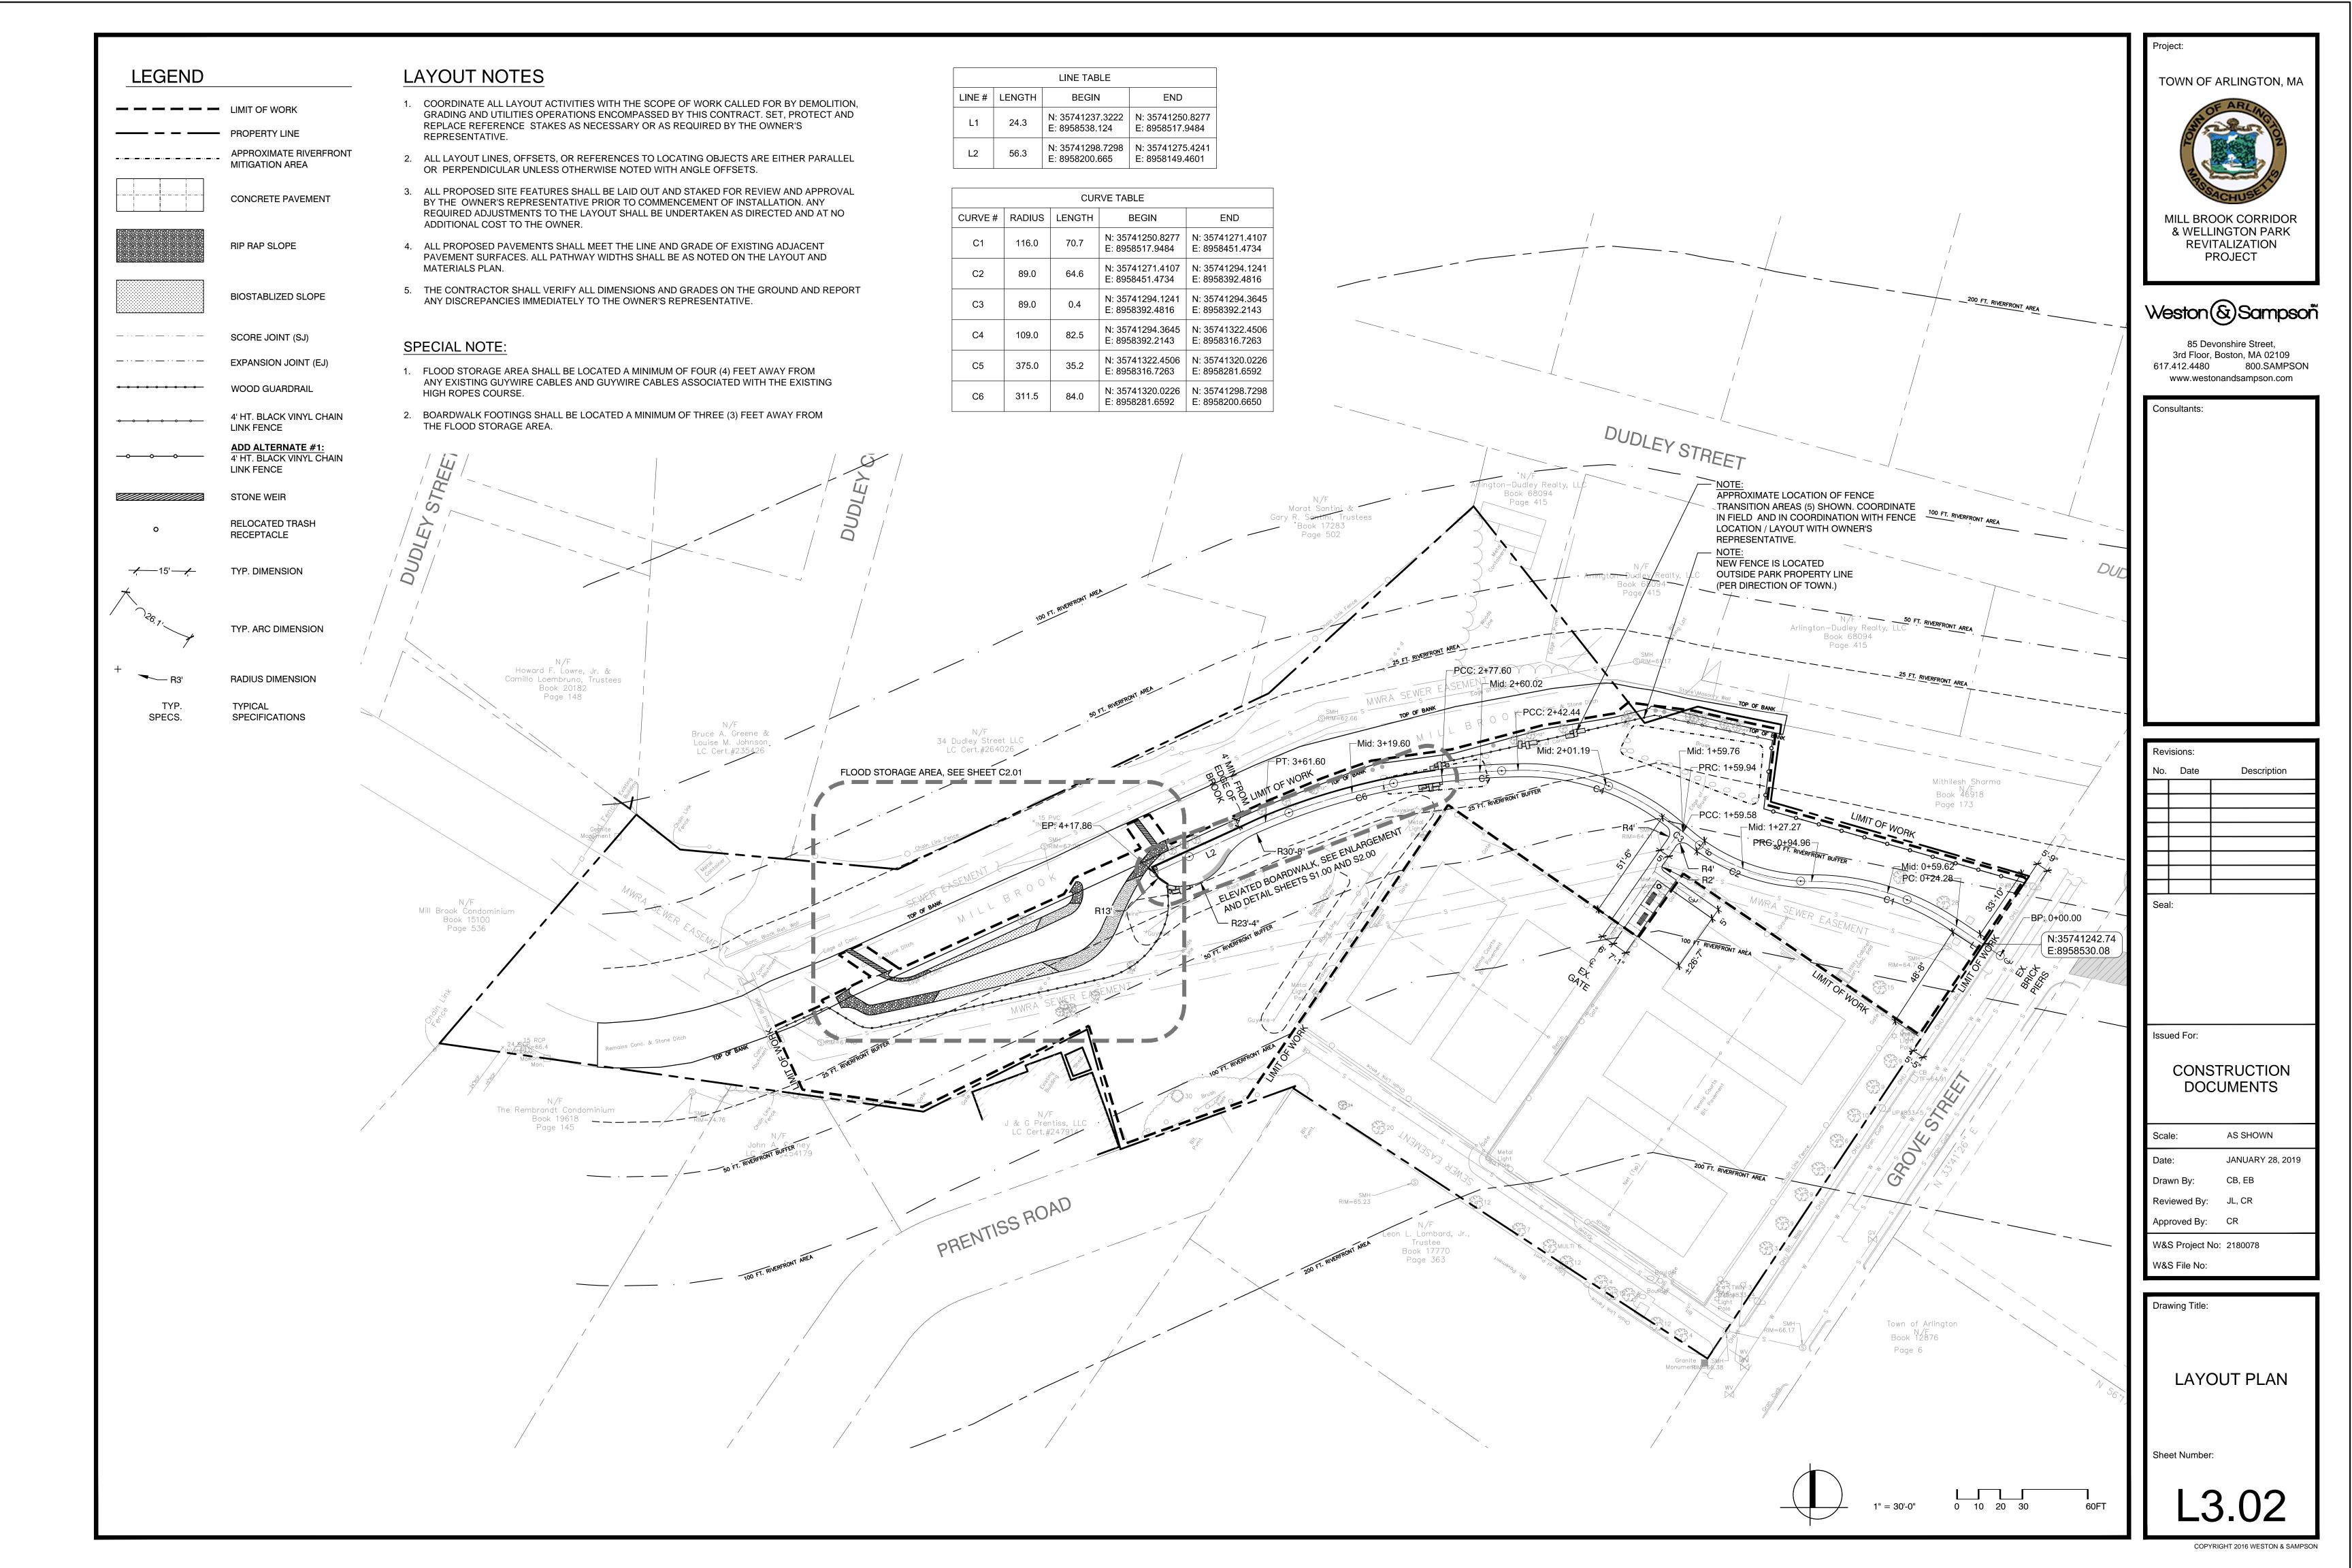
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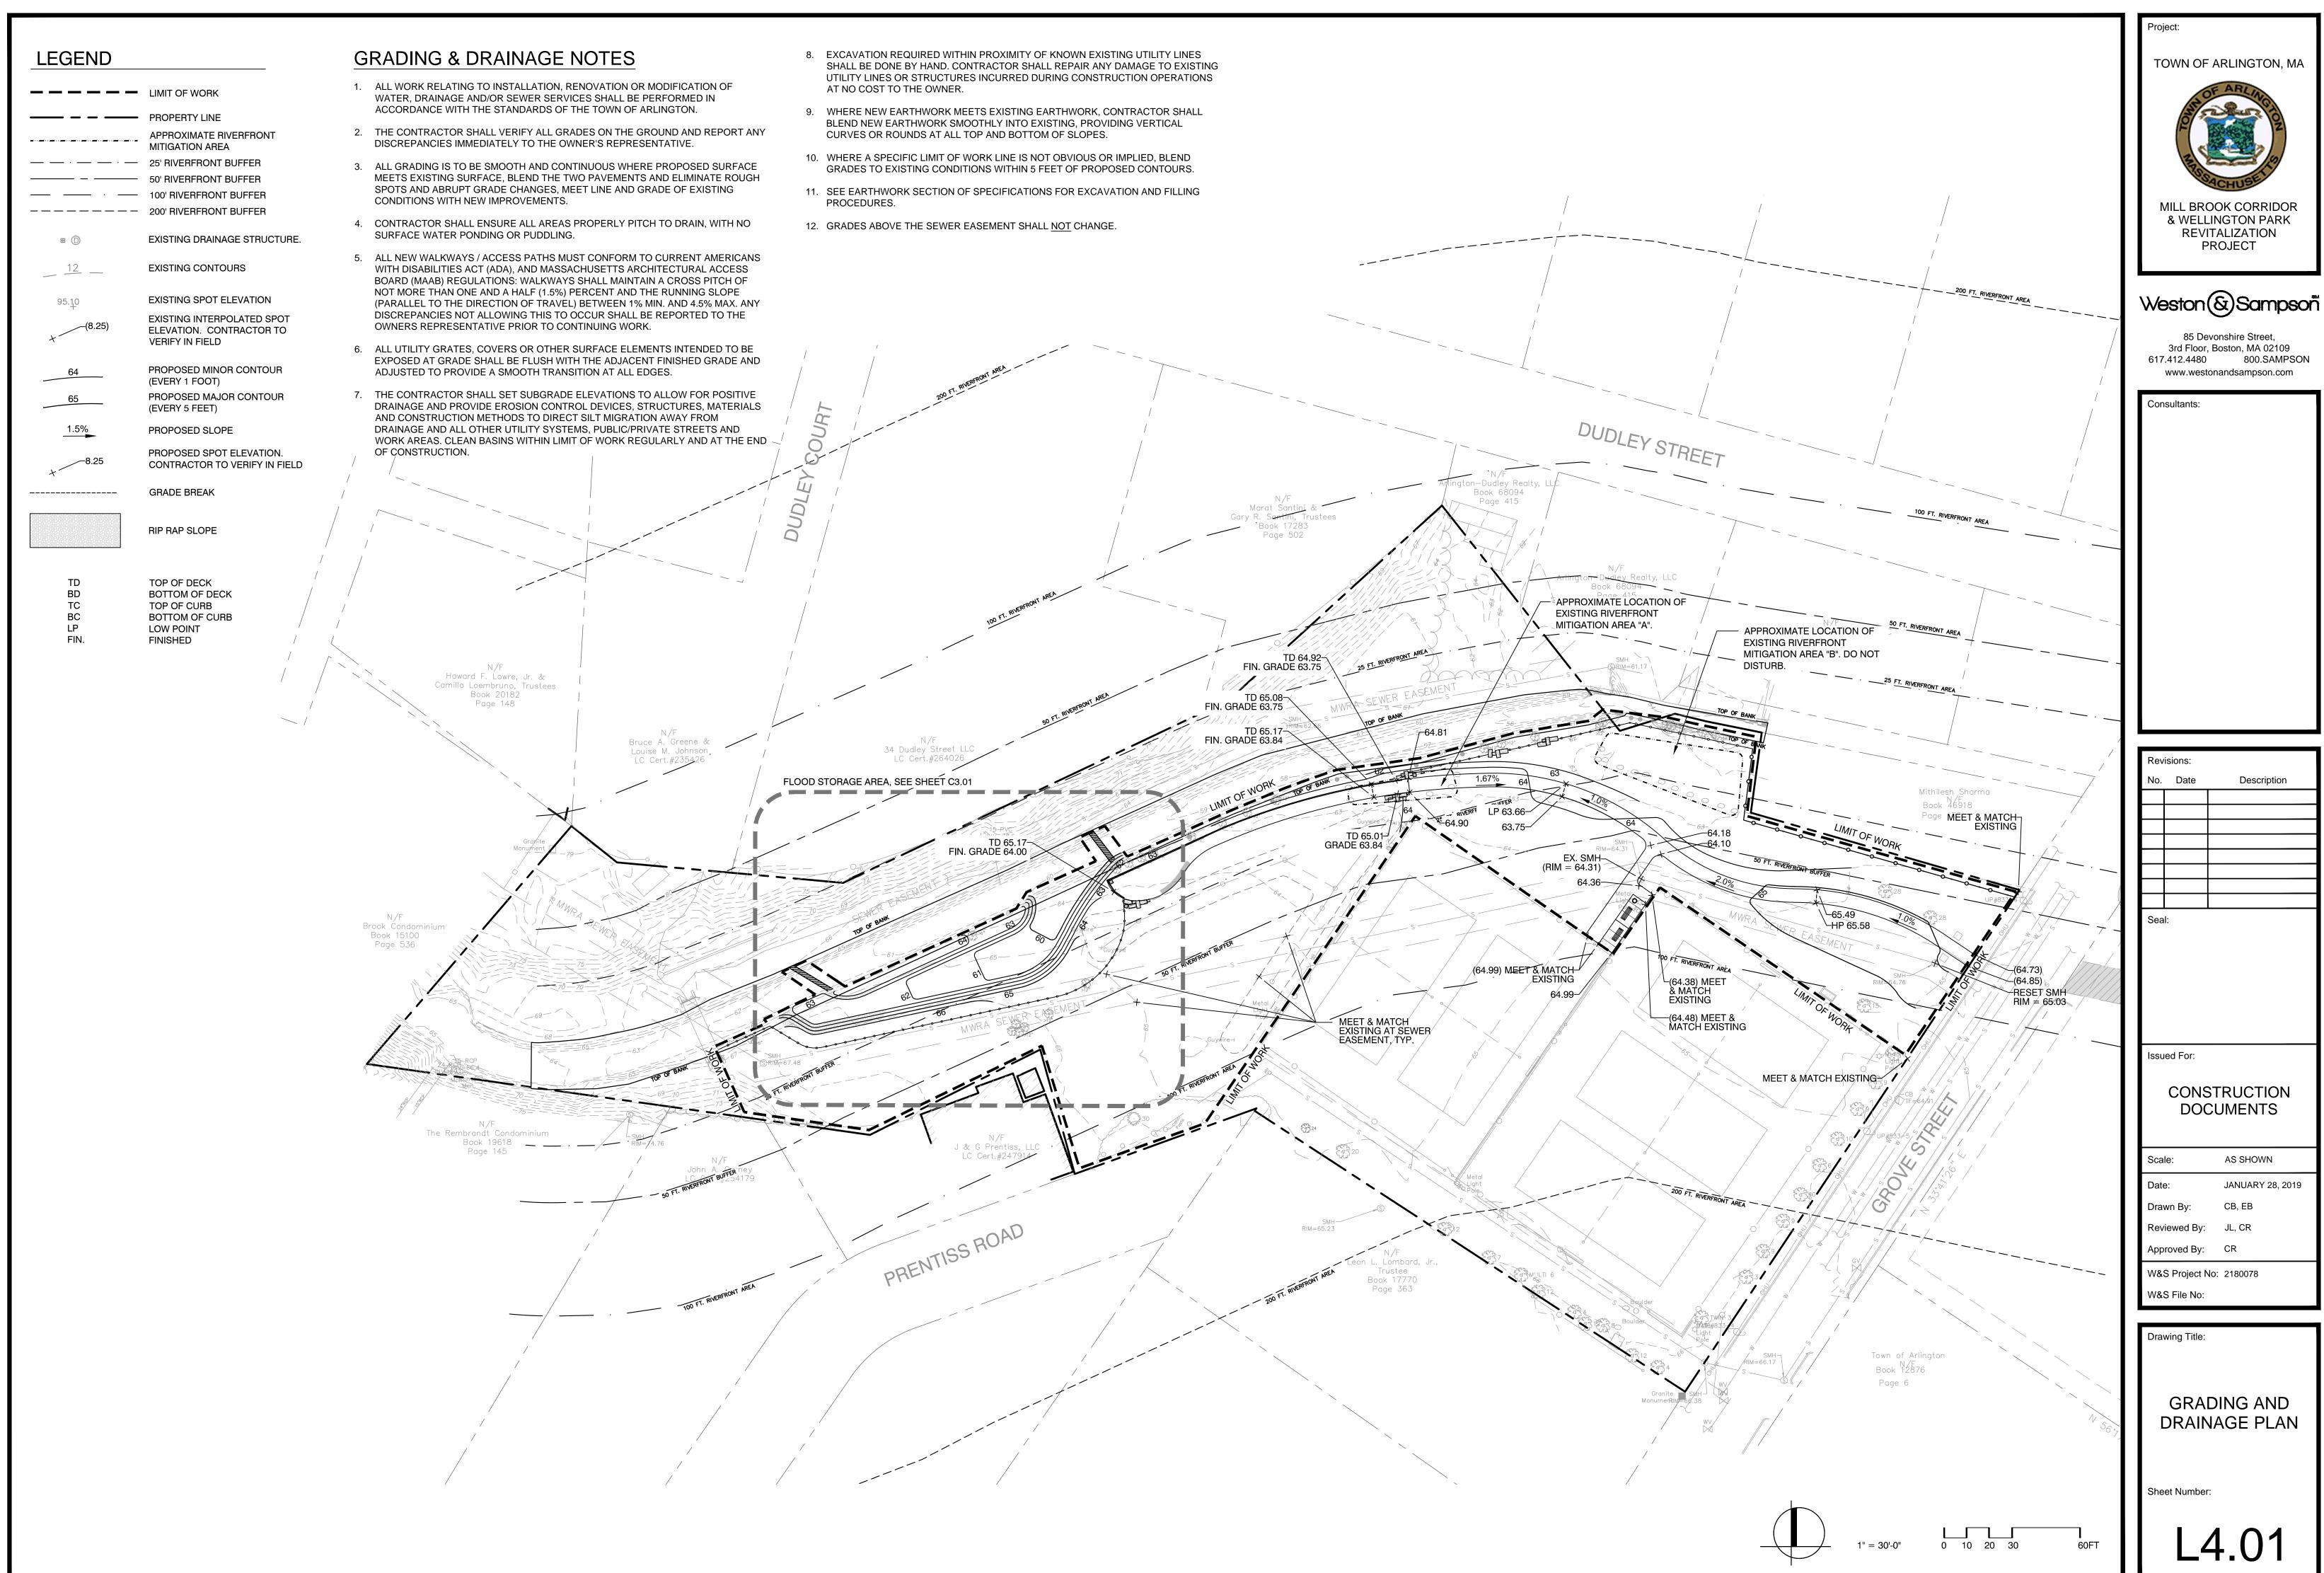
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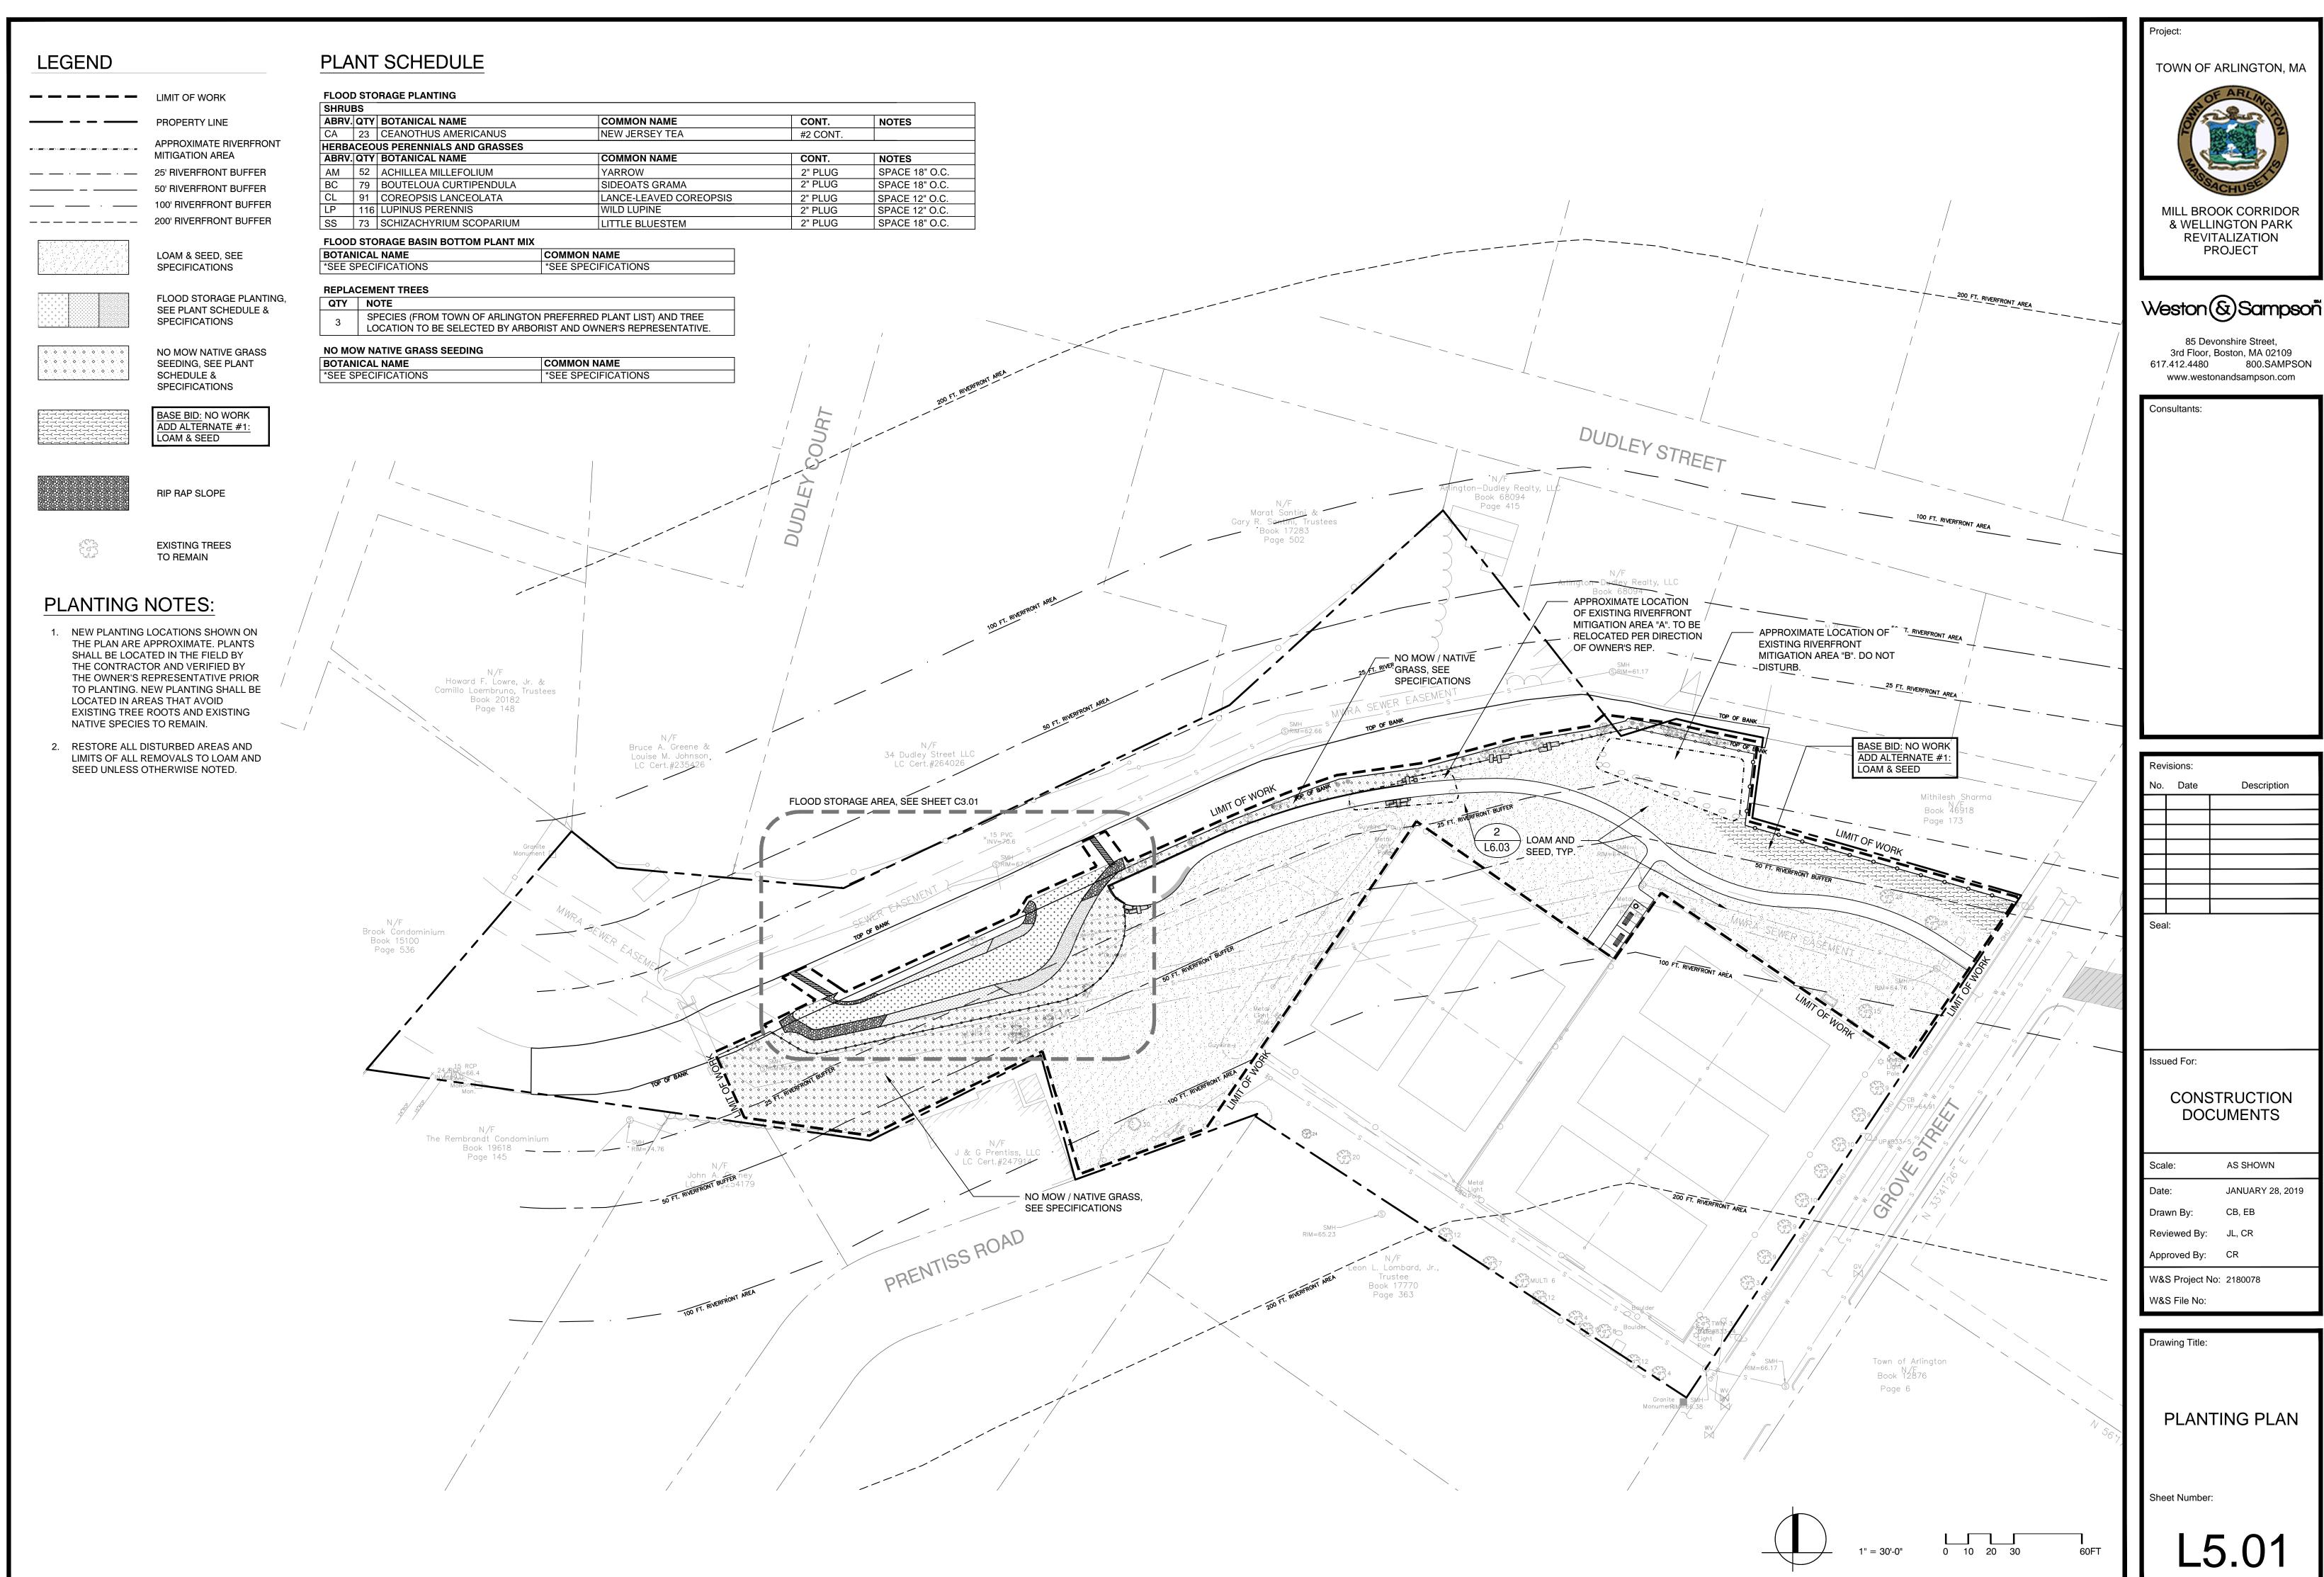
PREPARATION & **DEMOLITION PLAN**

Sheet Number:







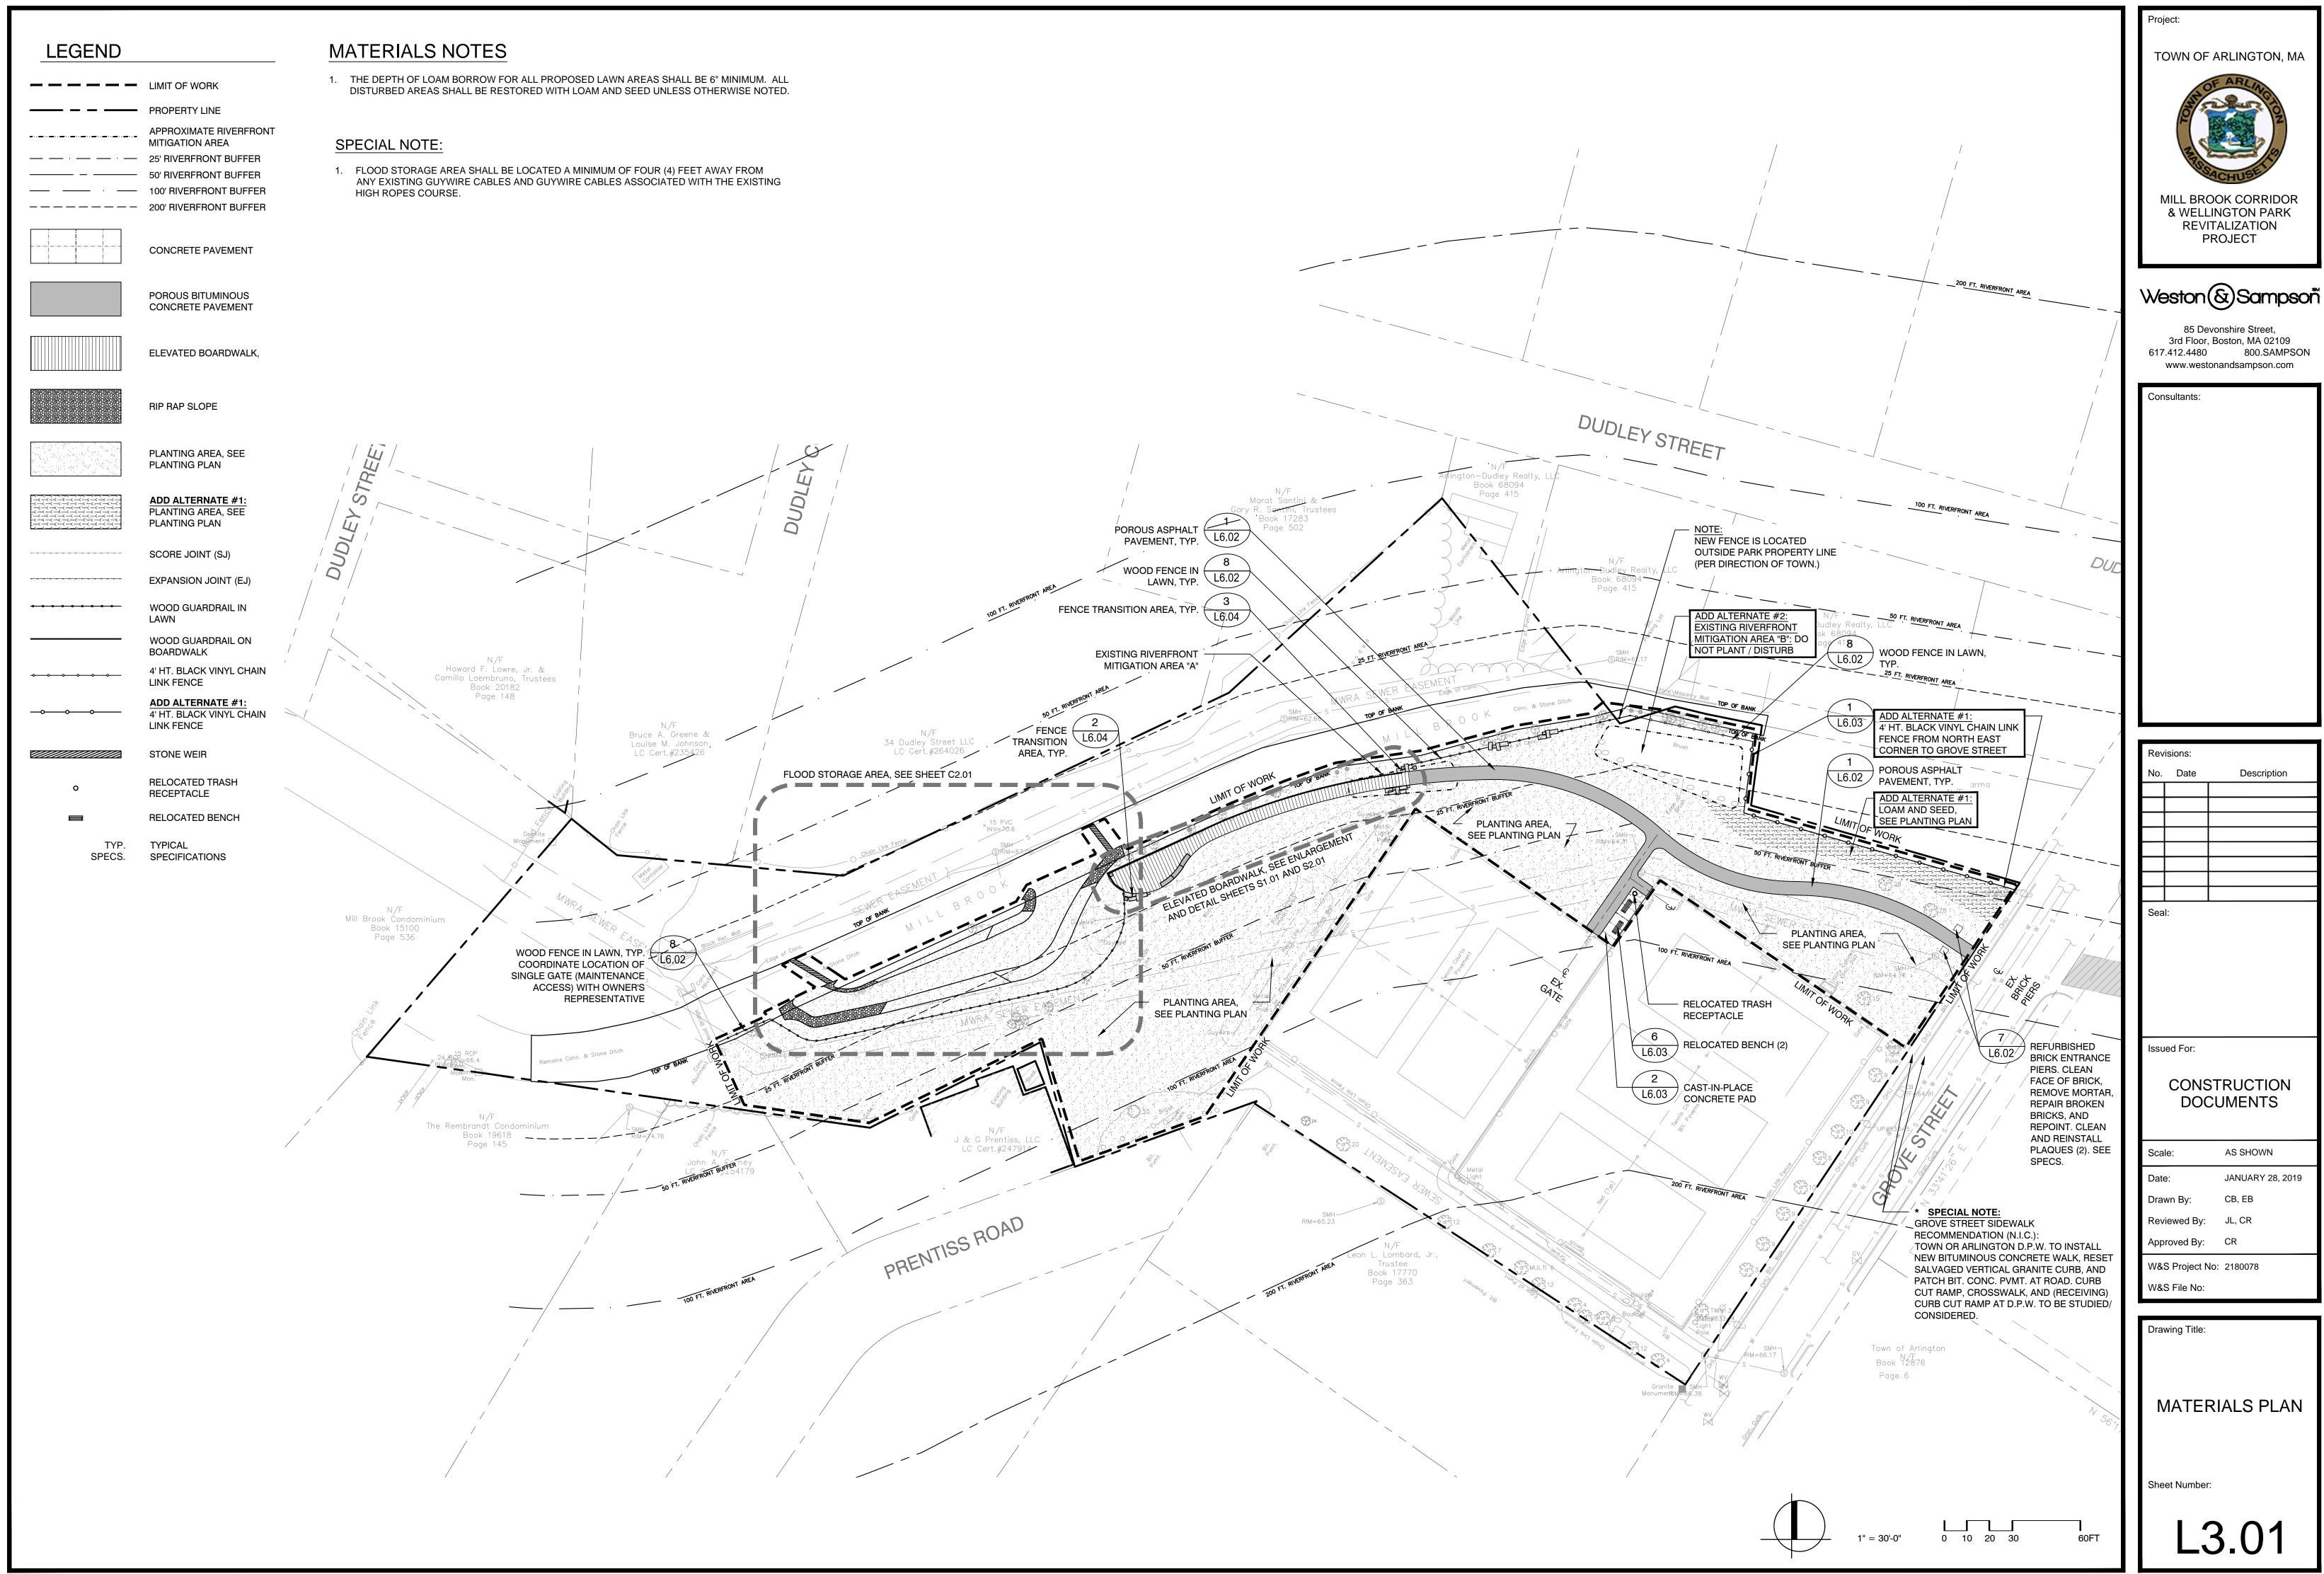

LEGEND DEMOLITION & SITE PREPARATION NOTES EROSION AND SEDIMENT CONTROL NOTES REQUIREMENTS OF THE SPECIFICATIONS FOR GRAVEL BORROW. ALL ITEMS CALLED FOR REMOVAL SHALL BE REMOVED TO FULL DEPTH INCLUDING ALL THE CONTRACTOR SHALL INCLUDE IN THE BID THE COST OF REMOVING ANY EXISTING SITE ALL SEDIMENT AND EROSION CONTROL DEVICES SHALL BE PUT INTO PLACE PRIOR TO FOOTINGS, FOUNDATIONS, AND OTHER APPURTENANCES, EXCEPT IF SPECIFICALLY NOTED BEGINNING ANY CONSTRUCTION OR DEMOLITION. REFER TO SPECIFICATIONS AND DETAILS FEATURES AND APPURTENANCES NECESSARY TO ACCOMPLISH THE CONSTRUCTION OF THE OTHERWISE. FOR TYPE OF EROSION AND SEDIMENT CONTROL. PROPOSED SITE IMPROVEMENTS. THE CONTRACTOR SHALL ALSO INCLUDE IN THE BID THE COST NECESSARY TO RESTORE SUCH ITEMS IF THEY ARE SCHEDULED TO REMAIN AS PART STRIP & STORE EXISTING TOPSOIL FOR LATER REUSE AS INDICATED ON PLANS WITH OF THE FINAL SITE IMPROVEMENTS. REFER TO PLANS TO DETERMINE REQUIRED EXCAVATION THE CONTRACTOR SHALL BE RESPONSIBLE FOR THE CONTINUAL MAINTENANCE OF ALL APPROPRIATE EROSION AND SEDIMENT CONTROLS. THE CONTRACTOR SHALL PROVIDE AND DEMOLITIONACTIVITIES, AND TO DETERMINE THE LOCATION OF THE PROPOSED SITE EROSION CONTROL DEVICES THROUGHOUT THE DURATION OF CONSTRUCTION ACTIVITIES. TESTING RESULTS THAT THE SOIL IS SUITABLE FOR REUSE IN ACCORDANCE WITH THE APPROXIMATE LIMIT OF IMPROVEMENTS. SPECIFICATIONS. CONTRACTOR SHALL SECURELY COVER STOCKPILE. **INVASIVE SPECIES REMOVAL** CONTRACTOR SHALL MEET ALL OF THE STATE OF MASSACHUSETTS D.E.P. REGULATIONS 2. THE CONTRACTOR MUST NOTIFY THE OWNER OF ANY WORK TO BE COMPLETED WITHIN THE AND THE TOWN OF ARLINGTON WETLAND BYLAW REGULATIONS FOR SEDIMENT AND 10. LOAM BORROW/TOPSOIL EXCAVATED AND DESIGNATED FOR REUSE SHALL BE SCREENED STRIP & STOCKPILE TOPSOIL RIGHT-OF-WAY AT LEAST FORTY-EIGHT HOURS PRIOR TO COMMENCING WORK. EROSION CONTROL. AND BLENDED WITH SUITABLE AMENDMENT MATERIAL IN ACCORDANCE WITH THE (8" MIN. DEPTH) SPECIFICATIONS. ALL EXCESS TOPSOIL EXCAVATED SHALL BE PROPERLY DISPOSED OF AT 3. THE OWNER RESERVES THE RIGHT TO REVIEW ALL MATERIALS DESIGNATED FOR REMOVAL EXCAVATED MATERIAL STOCKPILED IN THE AREA DESIGNATED ON THIS PLAN SHALL BE THE CONTRACTOR'S EXPENSE. AS PER THE SPECIFICATIONS, AND PER TOWN REGULATIONS. AND TO RETAIN OWNERSHIP OF SUCH MATERIALS. IF THE OWNER RETAINS ANY MATERIAL. SURROUNDED BY A RING OF UNBROKEN SEDIMENT AND EROSION CONTROL FENCE. THE **INVASIVE SPECIES** THE CONTRACTOR SHALL MAKE ARRANGEMENTS WITH THE OWNER TO HAVE THOSE LIMITS OF ALL GRADING AND DISTURBANCE SHALL BE KEPT TO A MINIMUM WITHIN THE 11. THE CONTRACTOR SHALL PROTECT EXISTING TREES TO REMAIN PER SPECIFICATIONS AND REMOVAL (FULL DEPTH MATERIALS REMOVED OFF SITE AT NO ADDITIONAL COST. APPROVED AREA OF CONSTRUCTION. ALL AREAS OUTSIDE OF THE LIMIT OF CONTRACT TOWN OF ARLINGTON WETLAND BYLAW REGULATIONS FOR TREE PROTECTION. CONTRACTOR METHOD) SHALL REMAIN TOTALLY UNDISTURBED UNLESS OTHERWISE APPROVED BY OWNER'S SHALL INSTALL A TREE PROTECTION BARRIER AFTER CLEARING TURF AND UNDERBRUSH BY REPRESENTATIVE. 4. UNLESS SPECIFICALLY NOTED TO BE REMOVED AND STOCKPILED (R&S) OR REUSED AND HAND, AND TAKE DUE CARE TO PREVENT INJURY TO TREES DURING CLEARING OPERATIONS. INVASIVE SPECIES REMOVAL (CUT, RELOCATED (R&R), ALL SITE FEATURES CALLED TO BE REMOVED AND DISPOSED (R&D) SHALL DAB, AND COVER METHOD, TYPE A: BE REMOVED WITH THEIR FOOTINGS, ATTACHMENTS, BASE MATERIAL, ETC, AND ALL CATCH BASINS AND DRAIN GRATES WITHIN LIMIT OF WORK SHALL BE PROTECTED WITH 12. THE STORAGE OF MATERIALS AND EQUIPMENT WILL BE PERMITTED AT LOCATIONS COVER MATCHES EX. GRADES) FILTER FABRIC DURING THE ENTIRE DURATION OF CONSTRUCTION. EACH STRUCTURE TRANSPORTED FROM THE SITE TO BE DISPOSED OF IN A LAWFUL MANNER AT A TOWN OF DESIGNATED BY OWNER AND OWNER'S REPRESENTATIVE. PROTECTION OF STORED SHALL BE CLEANED AND CLEARED. ARLINGTON APPROVED DISPOSAL SITE AT NO COST TO THE OWNER. MATERIALS AND EQUIPMENT SHALL BE THE SOLE RESPONSIBILITY OF THE CONTRACTOR INVASIVE SPECIES REMOVAL (CUT, DAB, AND COVER METHOD, TYPE B: ALL EXISTING SITE FEATURES TO REMAIN SHALL BE PROTECTED THROUGHOUT THE 6. THE CONTRACTOR SHALL PROVIDE DUST CONTROL FOR CONSTRUCTION OPERATIONS AS 13. THE CONTRACTOR TO TAKE ALL PRECAUTIONS AND MEASURES REQUIRED TO PREVENT COVER VARIES) APPROVED BY OWNER. CONSTRUCTION PERIOD. ANY FEATURES DAMAGED DURING CONSTRUCTION OPERATIONS DAMAGE TO THE EXISTING PAVEMENT TO REMAIN AS A RESULT OF CONSTRUCTION SHALL BE REPAIRED OR REPLACED TO THE SATISFACTION OF THE OWNER'S ACTIVITIES. THE CONTRACTOR SHALL REPAIR DAMAGED PAVEMENT AT NO COST TO THE ALL POINTS OF CONSTRUCTION EGRESS OR INGRESS SHALL BE MAINTAINED TO PREVENT REPRESENTATIVE AT NO ADDITIONAL COST TO THE CONTRACT/OWNER. TRACKING OR FLOWING OF SEDIMENT ONTO PUBLIC/PRIVATE ROADS. THE CONTRACTOR **CLEAR & GRUB VEGETATION** 6. DURING EARTHWORK OPERATIONS, THE CONTRACTOR SHALL TAKE CARE NOT TO DISTURB SHALL PROVIDE A WASHOUT AREA ON SITE. 14. THE CONTRACTOR IS RESPONSIBLE FOR SECURING THE SITE AT ALL TIMES FOR THE DURATION EXISTING MATERIALS TO REMAIN OUTSIDE THE LIMITS OF EXCAVATION AND BACKFILL, AND OF THE CONSTRUCTION PERIOD. HE/SHE HAS THE OPTION TO USE THE EXISTING CHAIN LINK SHALL TAKE WHATEVER MEASURES NECESSARY. AT THE CONTRACTOR'S EXPENSE, TO FENCE AS TEMPORARY CONSTRUCTION FENCE PRIOR TO ITS REMOVAL R&D CHAIN LINK FENCE, **^** PREVENT ANY EXCAVATED MATERIAL FROM COLLAPSING. ALL BACKFILL MATERIALS SHALL BE EXISTING TREES AND TREE PLACED AND COMPACTED, AS SPECIFIED, TO THE SUBGRADE REQUIRED FOR THE STUMPS. LOCATION AND INSTALLATION OF THE REMAINDER OF THE CONTRACT WORK. **R&D MASONRY AND CONCRETE** CONDITION TO BE EVALUATED BROOK STABILIZATION EDGE, BY ARBORIST AND OWNER'S 7. IT SHALL BE THE CONTRACTOR'S OPTION, WITH CONCURRENCE OF THE OWNER'S COMPLETE REP. SEE NOTES AND SPECS. REPRESENTATIVE, TO REUSE EXISTING PAVEMENT BASE COURSE IF IT MEETS THE EROSION CONTROL PRUNE, TYP. R&D MASONRY AND EX. EXISTING CONCRETE BROOK R&D REMOVE AND DISPOSE STABILIZATION EDGE, R&S REMOVE AND STORE EXISTING TREES AND TREE STUMPS. LOCATION COMPLETE. SEE SPECS. SPECIFICATIONS AND CONDITION TO BE EVALUATED BY SPECIAL NOTE # 6 ARBORIST AND OWNER'S REP. SEE NOTES AND **SPECS** EXISTING TREES IS LOCATED CLOSE TO EDGE OF SPECIAL NOTES: PROPOSED FLOOD STORAGE AREA. COORDINATE EVALUATION OF CONDITION AND REMOVAL OR PROTECTION WITH ARBORIST AND OWNER'S REPRESENTATIVE. THE CONTRACTOR SHALL CUT. DAB. AND COVER OR PERFORM FULL DEPTH REMOVAL OF INVASIVE SPECIES IN THE AREAS INDICATED ON THE PLAN. SEE SPECIFICATIONS. **EROSION CONTROL, TYP** 2. FOR AREAS CALLED OUT TO HAVE REMOVAL OF INVASIVE SPECIES, THE CONTRACTOR SHALL REMOVE TO DEPTH AS NOTED IN THE SPECIFICATIONS AND DISPOSE OF VEGETATION PROTECT ROPES COURSE TO AND SOIL AT A TOWN OF ARLINGTON APPROVED FACILITY (IN TOWN OR OTHER). SEE R&D CHAIN LINK FENCE; BEGIN REMAIN; MAINTAIN A MINIMUM SPECIFICATIONS. AT EAST EDGE OF FOOTBRIDGE OF 4 FEET CLEAR AWAY FROM AND R&D IN EASTERLY ALL POLES, GUYWIRES, AND 3. FOR AREAS CALLED OUT TO HAVE CUT, DAB, AND COVER REMOVAL OF INVASIVE SPECIES: **DIRECTION TOWARD GROVE GUY WIRE ANCHORS (BELOW** TYPE A: COVER SHALL MATCH EXISTING GRADES. SEE GRADING PLAN. STREET GRADE) TYPE B: COVER VARIES. SEE GRADING PLAN. SEE SPECIFICATIONS AND 8(M) PERMIT FOR REQUIREMENTS WITHIN MWRA SEWER **EXISTING TREES AND TREE** STUMPS. LOCATION AND 4. CONTRACTOR TO COORDINATE WITH TOWN ARBORIST AND OWNER'S REPRESENTATIVE FOR CONDITION TO BE EVALUATED THE EVALUATION OF CONDITION OF ALL TREES ALONG SOUTH EDGE OF BROOK. CLEAR & FOR REMOVAL OR PROTECTION GRUB TREES <6" CALIPER, VINES & SHRUB AS IDENTIFIED FOR R&D BY ARBORIST AND BY ARBORIST AND OWNER'S APPROVED BY OWNER'S REPRESENTATIVE. PROTECT TREES TO REMAIN AS IDENTIFIED BY REP. SEE NOTES AND SPECS. TOWN ARBORIST AND APPROVED BY OWNER'S REPRESENTATIVE. R&D ALL TREES IN POOR CONDITION OR POSING A HAZARD AS IDENTIFIED BY TOWN ARBORIST AND APPROVED BY OWNER'S REPRESENTATIVE. PROTECT ALL TREE STUMPS PROVIDING WILDLIFE HABITAT AS IDENTIFIED BY TOWN ARBORIST AND APPROVED BY OWNER'S REPRESENTATIVE. R&D ALL TREE STUMPS POSING A HAZARD AS IDENTIFIED BY TOWN ARBORIST AND APPROVED BY OWNER'S REPRESENTATIVE. CONFIRM WITH TOWN ARBORIST AND OWNER'S INVASIVE SPECIES REPRESENTATIVE PRIOR TO ANY SITE PREPARATION AND DEMOLITION WORK. PRUNE ALL REMOVAL (FULL DEPTH TREES TO REMAIN PER SPEC, WITH PRIOR COORDINATION WITH AND APPROVAL OF METHOD), SEE SPECS. OWNER'S REPRESENTATIVE, TOWN ARBORIST, AND PER TOWN OF ARLINGTON WETLAND BYLAW REGULATIONS. INVASIVE SPECIES REMOVAL (CUT, **R&D MASONRY AND CONCRETE** CONTRACTOR TO LOCATE AND FLAG ENTIRE LENGTH OF EXISTING MWRA SEWER EASEMENT DAB. AND COVER METHOD. TYPE A BROOK STABILIZATION EDGE, WITHIN PROJECT LIMIT OF WORK PRIOR TO ANY SITE PREPARATION AND DEMOLITION COMPLETE. SEE SPECIAL NOTE #6 COVER MATCHES EX. GRADES), SEE ACTIVITIES, AND FOR THE DURATION OF CONSTRUCTION ACTIVITIES. SEE SPECIFICATIONS SPECS. & GRADING PLAN AND 8 (M) PERMIT FOR REQUIREMENTS WITHIN EASEMENT. **EXISTING TREES AND TREE** STUMPS. LOCATION AND 6. ADD ALTERNATES (SEE SPECS): CONDITION TO BE EVALUATED #1: R&D CHAIN LINK FENCE. BEGIN AT PROPERTY LINE CORNER AND R&D TO GROVE FOR REMOVAL OR PROTECTION TREE PROTECTION, TYP. (LOCATION STREET, IN EASTERLY DIRECTION, CLEAR AND GRUB FROM EAST EDGE OF BY ARBORIST AND OWNER'S APPROXIMATE, VERIFY IN FIELD) RIVERFRONT MITIGATION AREA "B" TO GROVE STREET. REP. SEE NOTES AND SPECS. #2: CLEAR AND GRUB AREA (SELECTIVE). 7. LIMITS OF PROPOSED BANK EXCAVATION OF MASONRY AND CONCRETE BROOK STABILIZATION EDGE ARE TO BE MARKED IN THE FIELD PRIOR TO DEMOLITION FOR OWNER'S REPRESENTATIVE OBSERVATION, REVIEW, AND APPROVAL. INVASIVE SPECIES REMOVAL (CUT, DAB, AND COVER METHOD, TYPE B: 8. THE CONTRACTOR IS RESPONSIBLE FOR CONSTRUCTION DEWATERING AND SURFACE COVER VARIES), SEE SPECS. & WATER CONTROL TO ACHIEVE STABLE SUBGRADE CONDITIONS AND CONSTRUCTION GRADING PLAN IN-THE-DRY. GROUNDWATER LEVEL SHALL BE MAINTAINED 24-INCHES BELOW THE EXCAVATION/BACKFILL LEVEL DURING CONSTRUCTION. STRIP & STOCKPILE 9. THE CONTRACTOR IS RESPONSIBLE FOR REMOVING AND PROPERLY DISPOSING OF EXCESS TOPSOIL (8" MIN. FILL, TREES, INVASIVE SPECIES, AND DEMOLITION DEBRIS RESULTING FROM CONSTRUCTION ACTIVITIES AT A PROPER OFF-SITE AREA IN ACCORDANCE WITH THE CONTRACT DOCUMENTS AND MASSACHUSETTS REGULATIONS AND POLICIES. TREE PROTECTION, TYP. ALONG WEST AND SOUTH PROPERTY LINE. FLOOD STORAGE AREA SITE PREPARATION AND DEMOLITION PLAN SCALE: 1" = 10'-0"

TOWN OF ARLINGTON, MA

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MILL BROOK CORRIDOR & WELLINGTON PARK REVITALIZATION PROJECT

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FLOOD STORAGE AREA SITE PREPARATION & DEMOLITION PLAN

Sheet Number:

C1.01

LEGEND ----- PROPERTY LINE ——□—□— WOOD FENCE IN LAWN RIP RAP SLOPE BIOSTABILIZED SLOPE WITH REVETMENT MAT BIOSTABILIZED SLOPE RUBBER MAT/PLANTING + + + + AREA + + + PLANTING AREA ENVIRONMENTAL INTERPRETIVE SIGNAGE STONE WEIR TYP. DIMENSION TYP. ARC DIMENSION **RADIUS DIMENSION** TYP. **TYPICAL** SPECS. **SPECIFICATIONS**

LAYOUT & MATERIALS NOTES

- COORDINATE ALL LAYOUT ACTIVITIES WITH THE SCOPE OF WORK CALLED FOR BY DEMOLITION, GRADING AND UTILITIES OPERATIONS ENCOMPASSED BY THIS CONTRACT. SET, PROTECT AND REPLACE REFERENCE STAKES AS NECESSARY OR AS REQUIRED BY THE OWNER'S REPRESENTATIVE.
- 2. ALL LAYOUT LINES, OFFSETS, OR REFERENCES TO LOCATING OBJECTS ARE EITHER PARALLEL OR PERPENDICULAR UNLESS OTHERWISE NOTED WITH ANGLE OFFSETS.
- 3. ALL PROPOSED SITE FEATURES SHALL BE LAID OUT AND STAKED FOR REVIEW AND APPROVAL BY THE OWNER'S REPRESENTATIVE PRIOR TO COMMENCEMENT OF INSTALLATION. ANY REQUIRED ADJUSTMENTS TO THE LAYOUT SHALL BE UNDERTAKEN AS DIRECTED AND AT NO ADDITIONAL COST TO THE OWNER.
- 4. ALL PROPOSED PAVEMENTS SHALL MEET THE LINE AND GRADE OF EXISTING ADJACENT PAVEMENT SURFACES. ALL PATHWAY WIDTHS SHALL BE AS NOTED ON THE LAYOUT AND MATERIALS PLAN.
- 5. THE CONTRACTOR SHALL VERIFY ALL DIMENSIONS AND GRADES ON THE GROUND AND REPORT ANY DISCREPANCIES IMMEDIATELY TO THE OWNER'S REPRESENTATIVE.
- 6. THE DEPTH OF LOAM BORROW FOR ALL PROPOSED LAWN AREAS SHALL BE 6" MINIMUM. ALL DISTURBED AREAS SHALL BE RESTORED WITH LOAM AND SEED UNLESS OTHERWISE NOTED.

SPECIAL NOTE:

STORAGE AREA.

1. FLOOD STORAGE AREA SHALL BE LOCATED A MINIMUM OF FOUR (4) FEET AWAY FROM ANY EXISTING GUYWIRE CABLES AND GUYWIRE CABLES ASSOCIATED WITH THE EXISTING HIGH ROPES STRUCTURE.

FLOOD STORAGE AREA STABILIZATION - BIOSTABILIZATION AT **BOTTOM OF STORAGE AREA:**

- 1. CONTRACTOR TO MARK EXACT LOCATION IN FIELD WITH OWNER'S REPRESENTATIVE PRIOR TO CONSTRUCTION.
- 2. OWNER'S REPRESENTATIVE TO OBSERVE EXCAVATION ACTIVITIES WITHIN FLOOD
- 3. BIOSTABILIZED SLOPE PROTECTION MUST BE RATED TO WITHSTAND SHEAR STRESSES OF UP TO THREE (3) POUNDS PER SQUARE FOOT (PSF) AND VELOCITIES OF UP TO TEN (10) FEET PER SECOND (FPS).
- 4. BIOSTABILIZED SLOPE PROTECTION MUST BE RATED FOR FUNCTIONAL LONGEVITY UP TO

FLOOD STORAGE AREA STABILIZATION - RIP RAP AT BOTTOM OF STORAGE AREA:

- 1. CONTRACTOR TO MARK EXACT LOCATION IN FIELD WITH OWNER'S REPRESENTATIVE PRIOR TO CONSTRUCTION.
- 2. OWNER'S REPRESENTATIVE TO OBSERVE EXCAVATION ACTIVITIES WITHIN FLOOD STORAGE AREA.
- 3. RIP RAP SHALL BE PLACED AT EACH PINCH POINT CREATED BY THE FLOOD STORAGE AREA INLET AND OUTLET.
- 4. RIP RAP SHALL BE PLACED SO THAT IT BLENDS INTO EXISTING RIVERBANK, PROPOSED WEIRS, PROPOSED SLOPES, AND PROPOSED BIOSTABILIZATION ALONG THE BOTTOM OF THE FLOOD STORAGE AREA.

WITH THE MINIMUM AND MAXIMUM SLOPES SPECIFIED

IN THE CONTRACT DOCUMENTS AND AS REQUIRED BY

BIOSTABILIZED SLOPE PROTECTION MUST BE RATED

5. BIOSTABILIZED SLOPE PROTECTION MUST BE RATED

TO WITHSTAND SHEAR STRESSES OF UP TO 3 POUNDS

PER SQUARE FOOT (PSF) AND VELOCITIES OF UP TO 10

(HORIZONTAL: VERTICAL) AND FUNCTIONAL LONGEVITY

STATE OR FEDERAL EXCAVATION SAFETY

FOR SLOPE INCLINATIONS UP TO 1.5H:1V


REGULATIONS.

FEET PER SECOND (FPS).

UP TO THREE-YEARS.

SCALE: 1" = 10'-0"

RIP RAP SHALL BE PLACED SO THAT IT IS WELL KEYED AND DENSE

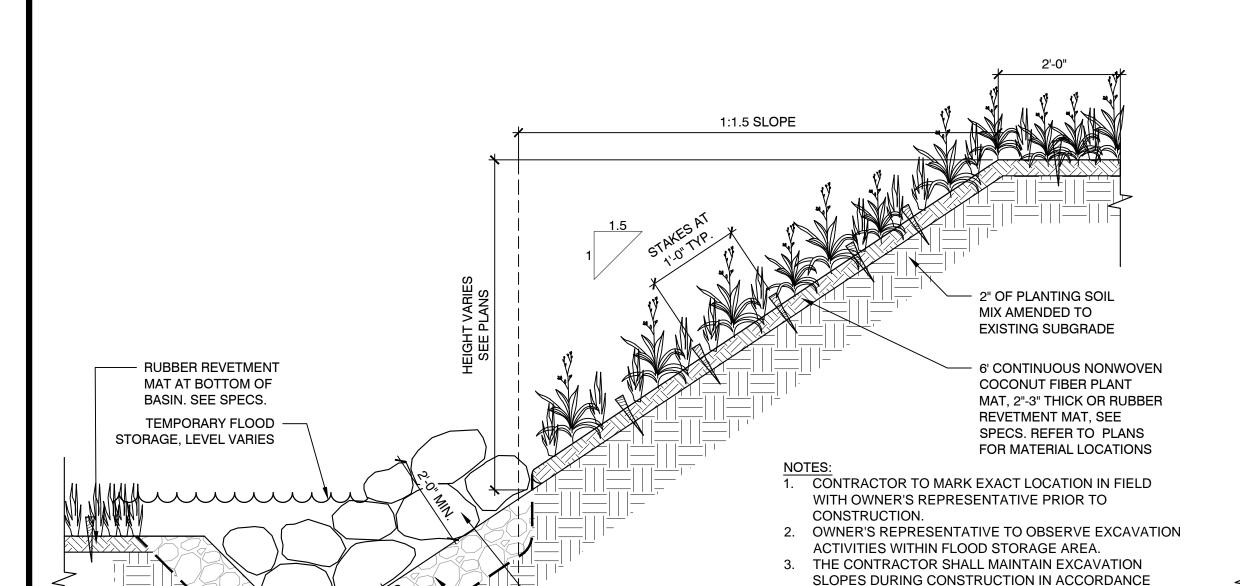

RIP RAP (MAX. DIAMETER 12"),


BOULDER SIZES AND SHAPE


REFER TO SPECS FOR

4" CRUSHED STONE


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FLOOD STORAGE AREA BANK STABILIZATION - BIOSTABILIZED SLOPE SCALE: N.T.S.



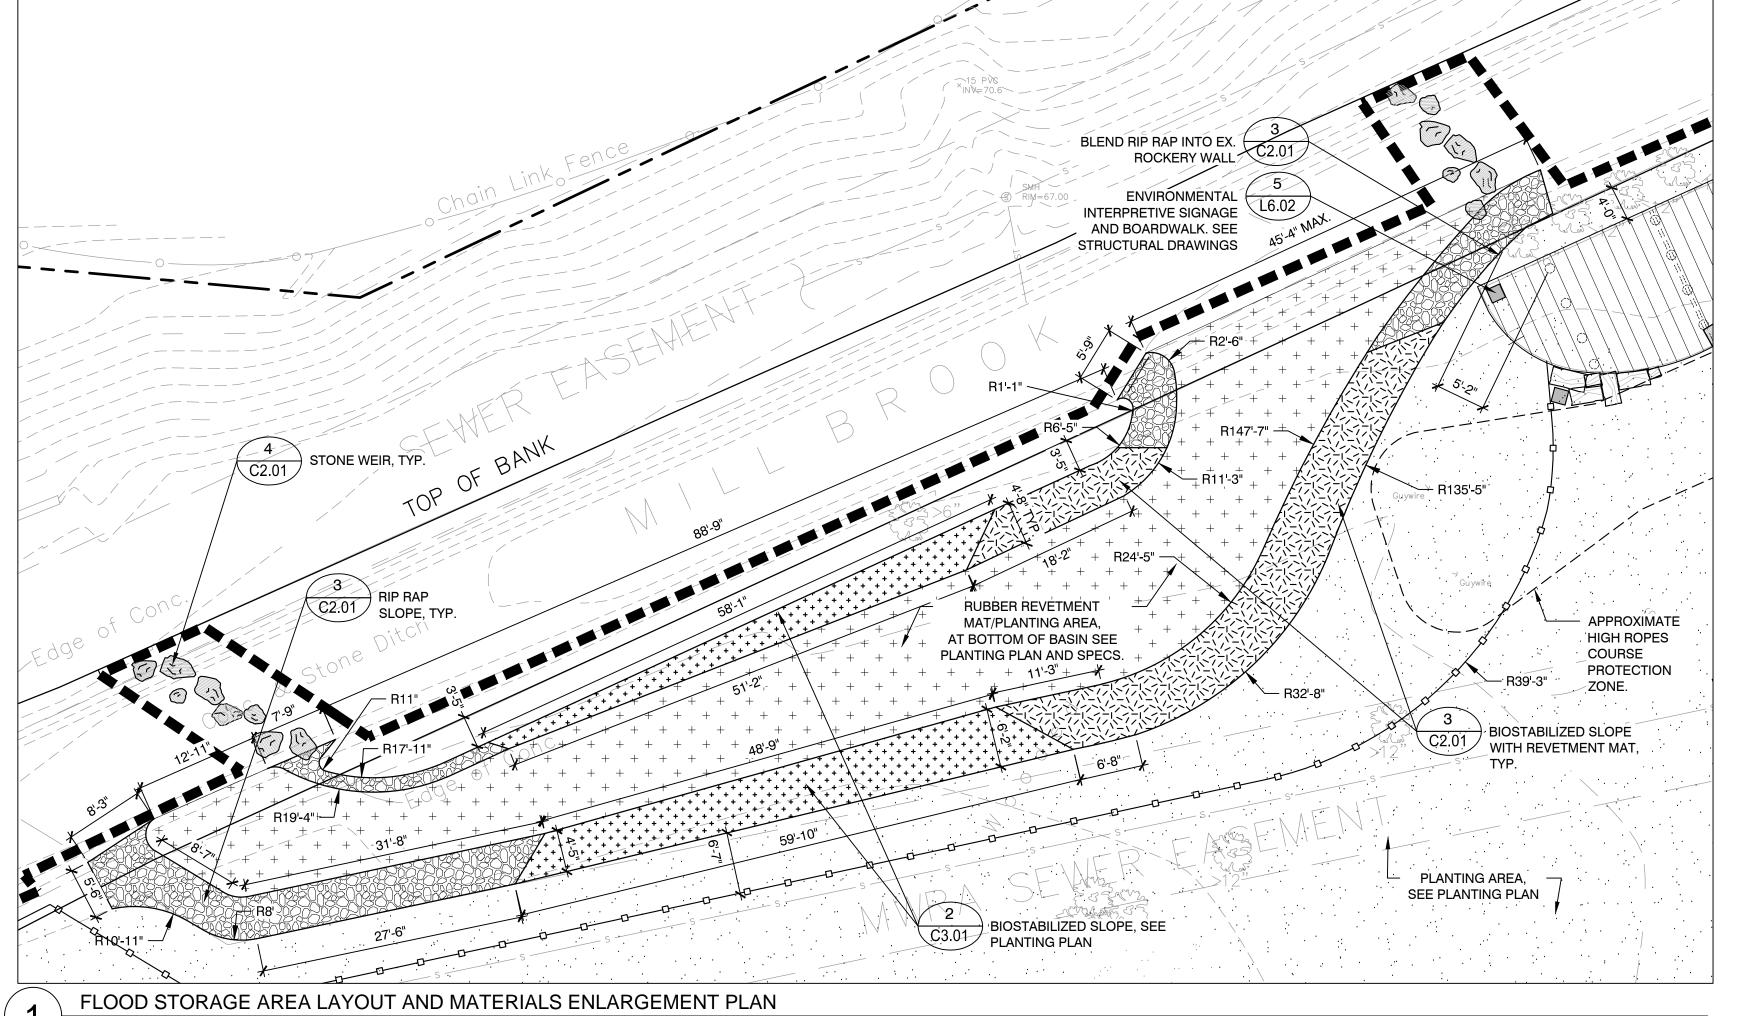

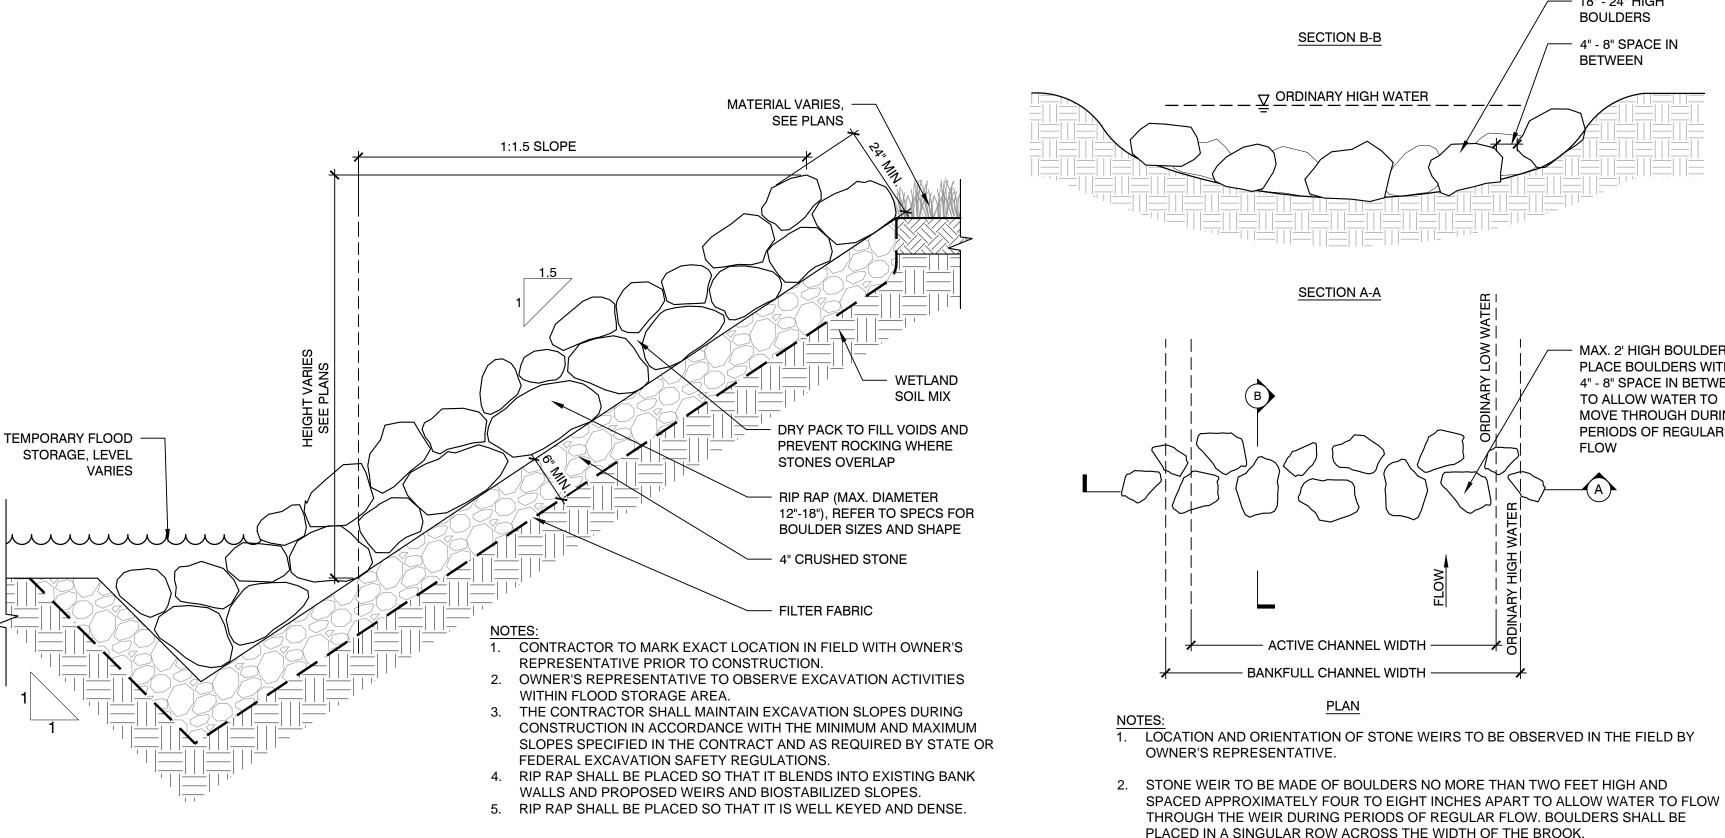FLOOD STORAGE AREA BANK STABILIZATION - RIP RAP AT CRITICAL SLOPES

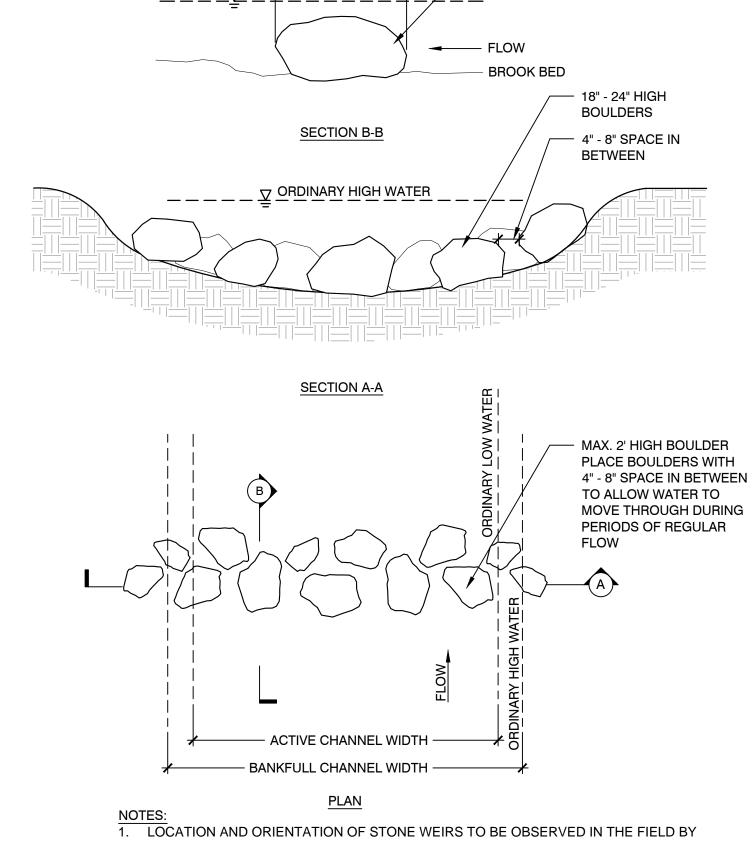

APPROX. 3'

WATER


STONE WEIR


LARGE BOULDER

MINIMUM 3' LONG

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FLOOD STORAGE

AREA LAYOUT & MATERIALS PLAN & DETAILS

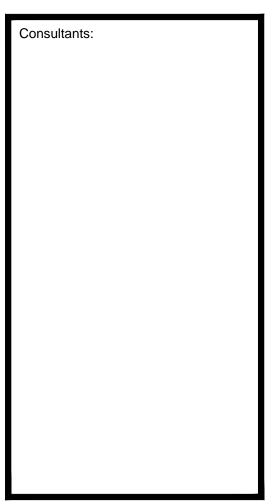Sheet Number:

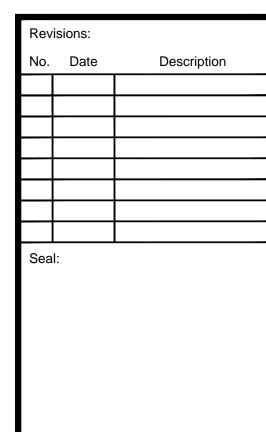GRADING & DRAINAGE NOTES LEGEND 1. ALL WORK RELATING TO INSTALLATION, RENOVATION OR MODIFICATION OF WATER, DRAINAGE AND/OR SEWER SERVICES SHALL BE PERFORMED IN ACCORDANCE WITH THE STANDARDS OF THE TOWN OF ARLINGTON. 2. THE CONTRACTOR SHALL VERIFY ALL GRADES ON THE GROUND AND REPORT ANY - PROPERTY LINE DISCREPANCIES IMMEDIATELY TO THE OWNER'S REPRESENTATIVE. 3. ALL GRADING IS TO BE SMOOTH AND CONTINUOUS WHERE PROPOSED SURFACE MEETS WOOD FENCE IN LAWN EXISTING SURFACE, BLEND THE TWO PAVEMENTS AND ELIMINATE ROUGH SPOTS AND ABRUPT GRADE CHANGES, MEET LINE AND GRADE OF EXISTING CONDITIONS WITH NEW IMPROVEMENTS. EXISTING DRAINAGE STRUCTURE. 4. CONTRACTOR SHALL ENSURE ALL AREAS PROPERLY PITCH TO DRAIN, WITH NO SURFACE WATER PONDING OR PUDDLING. **EXISTING CONTOURS** 5. ALL NEW WALKWAYS / ACCESS PATHS MUST CONFORM TO CURRENT AMERICANS WITH DISABILITIES ACT (ADA), AND MASSACHUSETTS ARCHITECTURAL ACCESS BOARD (MAAB) EXISTING SPOT ELEVATION 95.<u>1</u>0 REGULATIONS: WALKWAYS SHALL MAINTAIN A CROSS PITCH OF NOT MORE THAN ONE AND A EXISTING INTERPOLATED SPOT HALF (1.5%) PERCENT AND THE RUNNING SLOPE (PARALLEL TO THE DIRECTION OF TRAVEL) ELEVATION. CONTRACTOR TO BETWEEN 1% MIN. AND 4.5% MAX. ANY DISCREPANCIES NOT ALLOWING THIS TO OCCUR SHALL **VERIFY IN FIELD** BE REPORTED TO THE OWNERS REPRESENTATIVE PRIOR TO CONTINUING WORK. 6. ALL UTILITY GRATES, COVERS OR OTHER SURFACE ELEMENTS INTENDED TO BE EXPOSED AT PROPOSED MINOR CONTOUR GRADE SHALL BE FLUSH WITH THE ADJACENT FINISHED GRADE AND ADJUSTED TO PROVIDE A (EVERY 1 FOOT) SMOOTH TRANSITION AT ALL EDGES. PROPOSED MAJOR CONTOUR (EVERY 5 FEET) 7. THE CONTRACTOR SHALL SET SUBGRADE ELEVATIONS TO ALLOW FOR POSITIVE DRAINAGE AND PROVIDE EROSION CONTROL DEVICES, STRUCTURES, MATERIALS AND CONSTRUCTION 1.5% PROPOSED SLOPE METHODS TO DIRECT SILT MIGRATION AWAY FROM DRAINAGE AND OTHER UTILITY SYSTEMS, PUBLIC/PRIVATE STREETS AND WORK AREAS. CLEAN BASINS REGULARLY AND AT THE END OF PROPOSED SPOT ELEVATION. CONSTRUCTION. CONTRACTOR TO VERIFY IN FIELD 8. EXCAVATION REQUIRED WITHIN PROXIMITY OF KNOWN EXISTING UTILITY LINES SHALL BE DONE BY HAND. CONTRACTOR SHALL REPAIR ANY DAMAGE TO EXISTING UTILITY LINES OR STONE WEIR STRUCTURES INCURRED DURING CONSTRUCTION OPERATIONS AT NO COST TO THE OWNER. 9. WHERE NEW EARTHWORK MEETS EXISTING EARTHWORK, CONTRACTOR SHALL BLEND NEW EARTHWORK SMOOTHLY INTO EXISTING, PROVIDING VERTICAL CURVES OR ROUNDS AT ALL RIP RAP SLOPE TOP AND BOTTOM OF SLOPES. 10. WHERE A SPECIFIC LIMIT OF WORK LINE IS NOT OBVIOUS OR IMPLIED, BLEND GRADES TO TD TOP OF DECK EXISTING CONDITIONS WITHIN 5 FEET OF PROPOSED CONTOURS. BD BOTTOM OF DECK TOP OF CURB 11. SEE EARTHWORK SECTION OF SPECIFICATIONS FOR EXCAVATION AND FILLING PROCEDURES. BOTTOM OF CURB LOW POINT 12. GRADES ABOVE THE SEWER EASEMENT SHALL <u>NOT</u> CHANGE. **FINISHED** LOAM & SEED, SEE SPECIFICATIONS SPECIAL NOTE: 1. FLOOD STORAGE AREA SHALL BE LOCATED A MINIMUM OF FOUR (4) FEET AWAY FROM **NO-MOW NATIVE GRASS** ANY EXISTING GUYWIRE CABLES/ ANCHORS. SEEDING, SEE PLANT

PLANT SCHEDULE

SCHEDULE

RUBBER MAT/WETLAND

PLANT MIX, SEE SPECS.

SHRUB PLANTING

+ + + + + + +

FLOOD STORAGE PLANTING

FLOOL	7 210	RAGE PLANTING			
SHRU	BS				
ABRV.	QTY	BOTANICAL NAME	COMMON NAME	CONT.	NOTES
CA	23	CEANOTHUS AMERICANUS	NEW JERSEY TEA	#2 CONT.	
HERBA	CEO	US PERENNIALS AND GRASSES		•	
ABRV.	QTY	BOTANICAL NAME	COMMON NAME	CONT.	NOTES
AM	52	ACHILLEA MILLEFOLIUM	YARROW	2" PLUG	SPACE 18" O.C.
ВС	79	BOUTELOUA CURTIPENDULA	SIDEOATS GRAMA	2" PLUG	SPACE 18" O.C.
CL	91	COREOPSIS LANCEOLATA	LANCE-LEAVED COREOPSIS	2" PLUG	SPACE 12" O.C.
LP	116	LUPINUS PERENNIS	WILD LUPINE	2" PLUG	SPACE 12" O.C.
SS	73	SCHIZACHYRIUM SCOPARIUM	LITTLE BLUESTEM	2" PLUG	SPACE 18" O.C.


BOTANICAL NAME	COMMON NAME
*SEE SPECIFICATIONS	*SEE SPECIFICATIONS


REPLACEMENT TREES QTY NOTE 3 SPECIES (FROM TOWN OF ARLINGTON PREFERRED PLANT LIST) AND TREE LOCATION TO BE SELECTED BY ARBORIST AND OWNER'S REPRESENTATIVE.

NO MOW NATIVE GRASS SEEDING	
BOTANICAL NAME	COMMON NAME
*SEE SPECIFICATIONS	*SEE SPECIFICATIONS


PLANTING NOTES:

- 1. NEW PLANTING LOCATIONS SHOWN ON THE PLAN ARE APPROXIMATE. PLANTS SHALL BE LOCATED IN THE FIELD BY THE CONTRACTOR AND VERIFIED BY THE OWNER'S REPRESENTATIVE PRIOR TO PLANTING. NEW PLANTING SHALL BE LOCATED IN AREAS THAT AVOID EXISTING TREE ROOTS AND EXISTING NATIVE SPECIES TO REMAIN.
- 2. RESTORE ALL DISTURBED AREAS AND LIMITS OF ALL REMOVALS TO LOAM AND SEED UNLESS OTHERWISE NOTED.

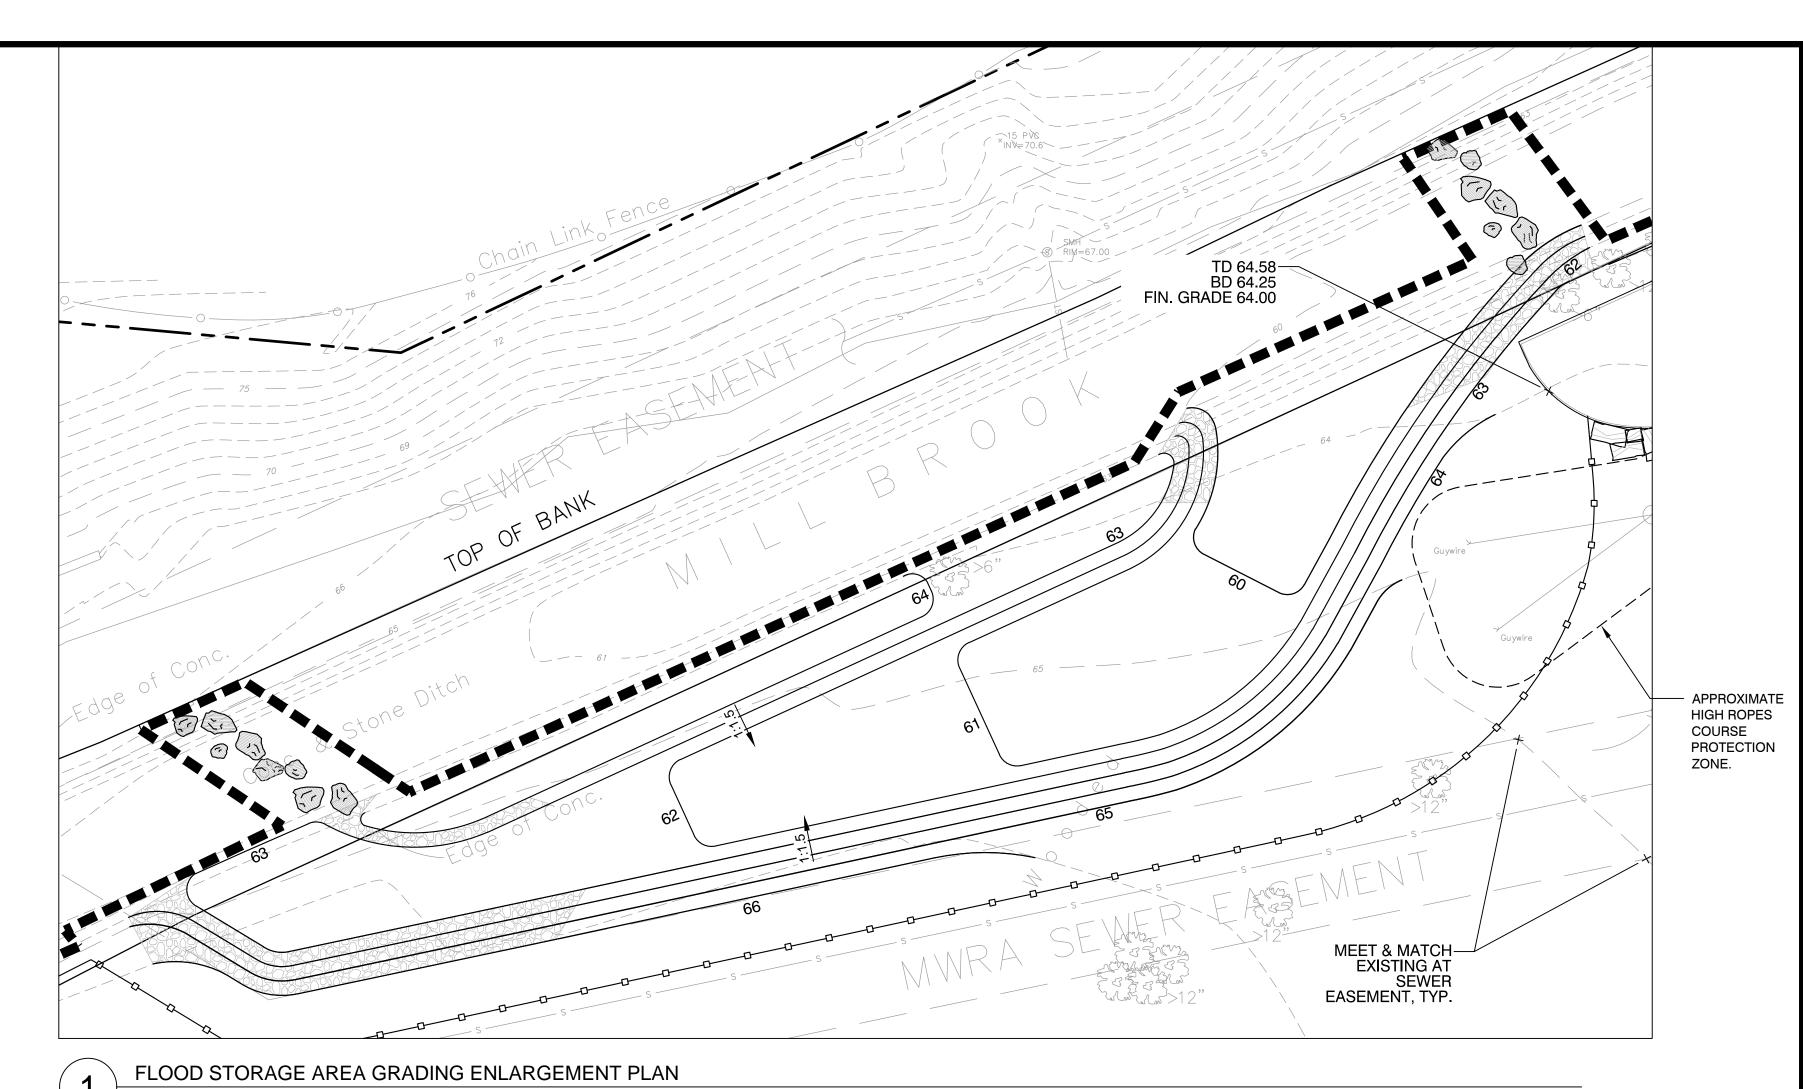

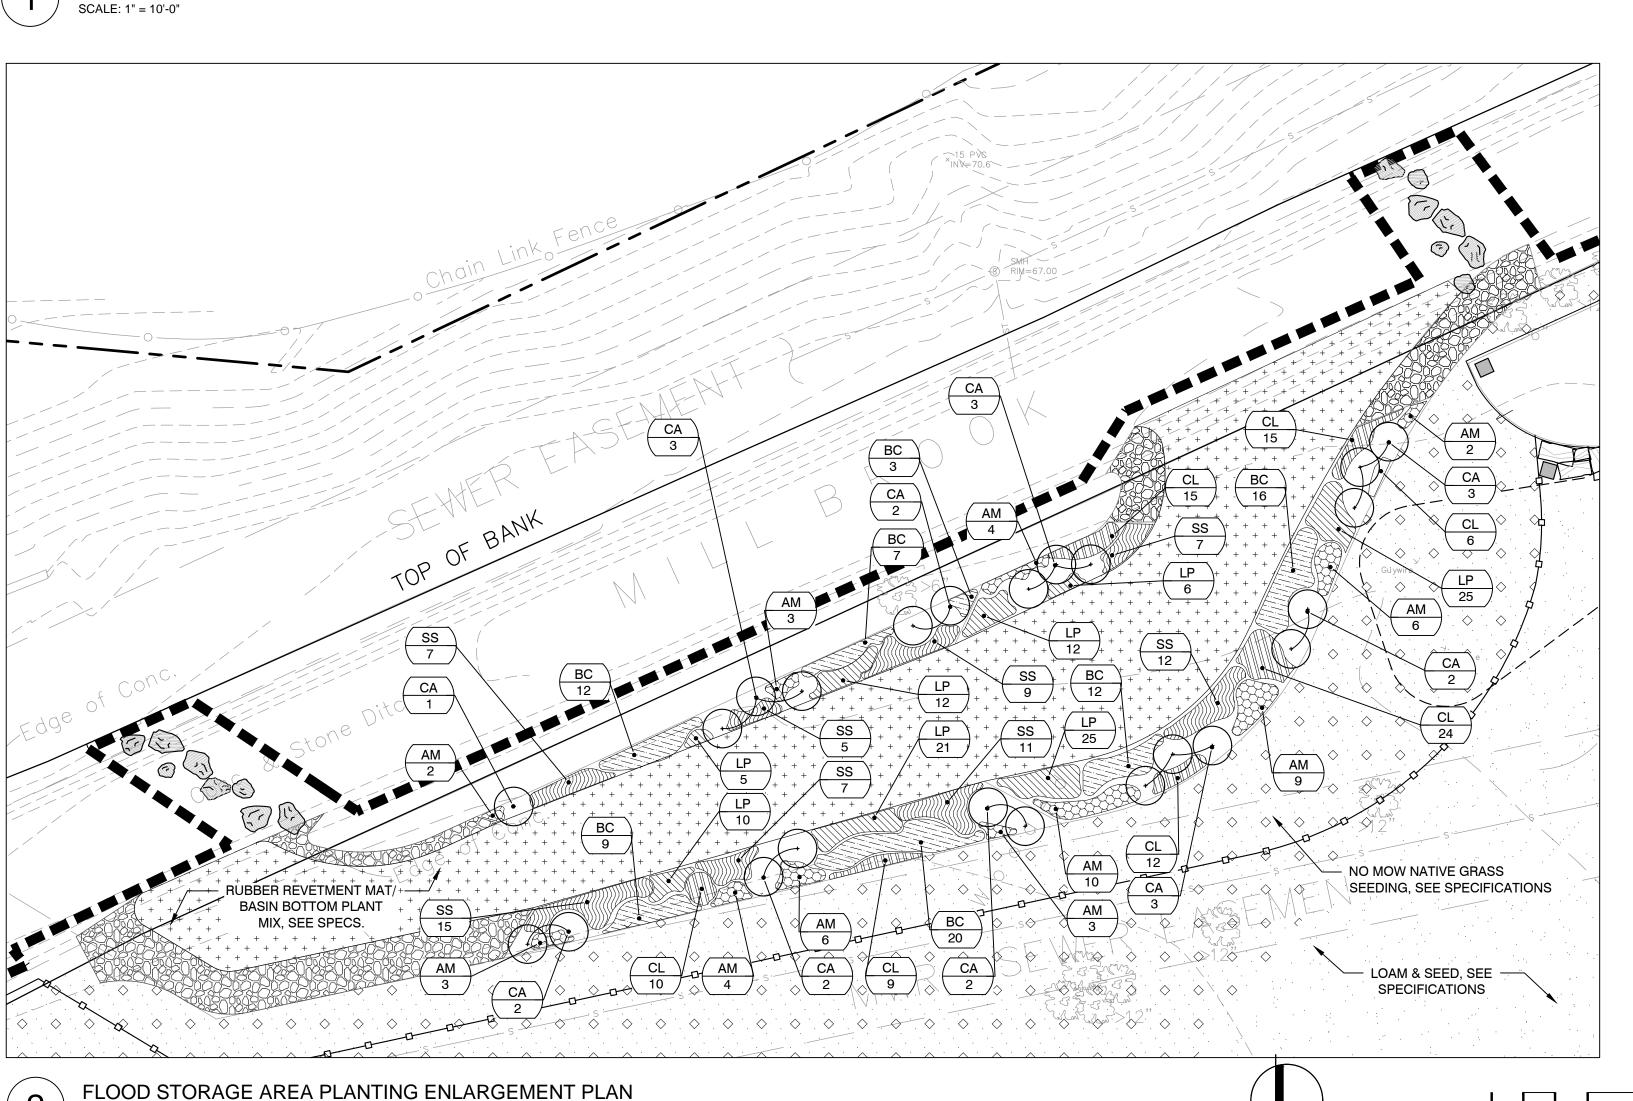

SCALE: 1" = 10'-0"

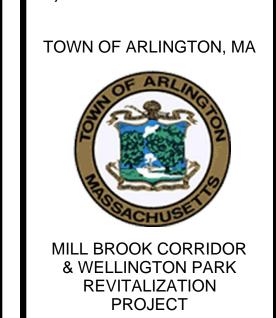

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Revisions:

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ale: AS SHOWN

Date: JANUARY 28, 2019
Drawn By: CB, EB
Reviewed By: JL, CR
Approved By: CR

W&S Project No: 2180078
W&S File No:

Drawing Title:

FLOOD STORAGE AREA GRADING & PLANTING PLAN

Sheet Number:

C3.01

- 1.0 GENERAL NOTES
- 1.1 ALL WORK SHALL CONFORM TO THE 9TH EDITION OF THE MASSACHUSETTS STATE BUILDING CODE AND ITS APPLICABLE REFERENCES.
- 1.2 THE GENERAL CONTRACTOR SHALL BE RESPONSIBLE FOR CHECKING, COORDINATING, AND VERIFYING ALL DIMENSIONS AND CONDITIONS IN THE FIELD. ANY DISCREPANCIES SHALL BE BROUGHT TO THE ATTENTION OF THE ENGINEER BEFORE PROCEEDING WITH THE AFFECTED PORTION OF WORK.
- 1.3 ALL BOLTS & HARDWARE SHALL BE HOT-DIPPED GALVANIZED U.N.O.
- 2.0 CONCRETE
- 2.1 CONCRETE WORK SHALL CONFORM TO "BUILDING CODE REQUIREMENTS FOR REINFORCED CONCRETE (ACI 318;318R)" AND "SPECIFICATIONS FOR STRUCTURAL CONCRETE FOR BUILDINGS (ACI 301)".
- 2.2 CONCRETE SHALL BE NORMAL WEIGHT AND HAVE A MINIMUM 28 DAY COMPRESSIVE STRENGTH OF 4500 PSI AND A MAXIMUM WATER-CEMENT RATIO OF 0.45.
- 2.3 CEMENT SHALL CONFORM TO ASTM C 150 TYPE I/II.
- 2.4 SLUMP OF CAST-IN-PLACE CONCRETE SHALL BE 4" +/- 1".
- 2.5 CONCRETE SHALL BE AIR ENTRAINED TO 6% ± 1.5%

3.0 REINFORCING

- 3.1 REINFORCEMENT WORK OF DETAILING, FABRICATION, AND ERECTION SHALL CONFORM TO "BUILDING CODE REQUIREMENTS FOR REINFORCED CONCRETE (ACI 318-02;318R-02)", "ACI DETAILING MANUAL (SP-66-1988)", "CRSI MANUAL OF STANDARD PRACTICE (DA4-90)," AND "STRUCTURAL WELDING CODE REINFORCING STEEL (AWS D1.4-79)" AT MINIMUM OR AS SPECIFIED HEREIN.
- 3.2 STEEL REINFORCEMENT, UNLESS OTHERWISE NOTED, SHALL CONFORM ASTM A615 GRADE 60.
- 3.3 MINIMUM CONCRETE PROTECTIVE COVERING FOR REINFORCEMENT, UNLESS NOTED OTHERWISE, SHALL BE 2.0".
- 3.4 REINFORCEMENT SHALL BE CONTINUOUS THROUGH CONSTRUCTION JOINTS UNLESS OTHERWISE INDICATED.
- 3.5 REINFORCEMENT SHALL NOT BE TACK WELDED.
- 3.6 INSTALLATION OF REINFORCEMENT SHALL BE COMPLETED AT LEAST 24 HOURS PRIOR TO THE SCHEDULED CONCRETE PLACEMENT.

- 4.0 TIMBER CONSTRUCTION
- 4.1 THE WORK COVERED UNDER THIS SECTION INCLUDES, BUT IS NOT NECESSARILY LIMITED TO, STRINGERS, BEAMS AND RAIL POSTS.
- 4.2 ALL VISUALLY GRADED STRUCTURAL LUMBER AND WOOD CONSTRUCTION SHALL CONFORM TO THE "NATIONAL DESIGN SPECIFICATION FOR WOOD CONSTRUCTION" (ANSI/NFPA NDS LATEST EDITION), ITS SUPPLEMENT, AND COMMENTARY BY THE AMERICAN FOREST & PAPER ASSOCIATION / AMERICAN WOOD COUNCIL.
- 4.3 TIMBER SHALL MEET THE REQUIREMENTS OF THE SOUTHERN PINE INSPECTION BUREAU INSPECTION RULES, LATEST EDITION FOR SOUTHERN PINE NO. 1 GRADE MINIMUM.
- 4.4 TIMBER SHALL BE HANDLED CAREFULLY, WITHOUT SUDDEN DROPPING, BREAKING OF OUTER FIBERS, BRUISING OR PENETRATING THE SURFACE WITH TOOLS.
- 4.5 TIMBER SHALL BE CUT AND FRAMED TO A CLOSE FIT IN SUCH A MANNER THAT THE JOINTS SHALL HAVE AN EVEN BEARING OVER THE ENTIRE CONTACT SURFACE. NO SHIMMING, UNLESS OTHERWISE NOTED, WILL BE PERMITTED IN MAKING JOINTS NOR WILL OPEN JOINTS BE ACCEPTED.
- 4.6 ALL TIMBERS SHALL BE PRESSURE TREATED (P.T.) WITH A WOOD PRESERVATIVE TO MEET AMERICAN WOOD PROTECTION ASSOCIATION (AWPA) USE CATEGORY 3B. FOR FRAMING IN CONTACT WITH THE GROUND, MEET AWPA USE CATEGORY 4A. FRAMING SHALL NOT BE INCISED.
- 4.7 FIELD TREAT NEWLY CUT SURFACES OF PRESSURE TREATED TIMBER WITH PRESERVATIVE PER MANUFACTURER'S RECOMMENDATIONS.
- 4.8 MATERIAL SHALL BE SOUND, WELL SEASONED, AND STRAIGHT GRAINED, FREE FROM SHAKES AND LARGE OR LOOSE KNOTS, AND SHALL HAVE NO DECAYED WOOD, WORM HOLES, OR ANY OTHER DEFECTS WHICH THE OWNER DETERMINES WILL IMPAIR ITS STRENGTH OR DURABILITY.
- 4.9 PIECES OF EXCEPTIONALLY LIGHT WEIGHT MATERIAL WILL NOT BE ACCEPTED.
- 4.10 MATERIAL SHALL BE STORED OFF OF THE GROUND IN A MANNER TO PREVENT DAMAGE AND TO PERMIT EASY INSPECTION.
- 4.11 TIMBER SHALL BE SURFACED FOUR SIDES (S4S) UNLESS OTHERWISE NOTED.
- 4.12 HOT-DIPPED OR Z MAX (G185) GALVANIZED SIMPSON STRONG-TIE CONNECTIONS OR APPROVED EQUAL SHALL BE UTILIZED AS SPECIFIED WITHIN THESE CONSTRUCTION DOCUMENTS.
- 4.13 ADHESIVE ANCHOR SYSTEMS SHALL BE UTILIZED AS SPECIFIED WITHIN THESE CONSTRUCTION DOCUMENTS. THE CONTRACTOR SHALL PROVIDE SHOP DRAWINGS FOR THE ADHESIVE ANCHORING SYSTEM TO THE ENGINEER FOR APPROVAL PRIOR TO PLACING ORDER.
- 4.14 ANCHOR RODS SHALL BE COUNTER-BORED BY THE CONTRACTOR WHERE REQUIRED SUCH THAT THERE IS NO INTERFERENCE BETWEEN DECK BOARDS OR OTHER FRAMING ELEMENTS.

- 5.0 DECKING
- 5.1 THE WORK COVERED UNDER THIS SECTION INCLUDES, BUT IS NOT NECESSARILY LIMITED TO DECKING.
- 5.2 DECKING SHALL BE FASTENED TO EACH 2X12 STRINGER WITH (2) 14 GAUGE 4" LONG 316 S.S. FLAT HEAD SCREWS .
- 5.3 SCREW HOLES SHALL BE PRE-DRILLED WITH A 5/32" LEAD HOLE. LEAD HOLE SHALL BE NO LONGER THAN THE SCREW EMBEDMENT.
- 5.4 LEAD HOLE SHALL BE COUNTER-SUNK TO ASSURE THAT SCREW HEAD IS FLUSH WITH THE FINISHED DECK SURFACE.
- 5.5 DECK WOOD SHALL BE STORED IN A CLEAN, DRY, WEATHER PROTECTED LOCATION PRIOR TO INSTALLATION. NO DENTED, STAINED, TWISTED, OR DAMAGED MATERIAL SHALL BE INCORPORATED INTO THE WORK.
- 5.6 DECKING TO HAVE 1/8" GAP BETWEEN ADJACENT BOARDS.
- 5.7 DECKING TO HAVE 2"X2" TRIMBOARD AROUND PERIMETER ANYWHERE WHERE GUARD IS NOT PROVIDED.
- 6.0 DESIGN LOADS

LOADS, LOADING CONDITIONS, AND COMBINATIONS SHALL BE IN ACCORDANCE WITH THE MASSACHUSETTS STATE BUILDING CODE - 780 CMR, IBC 2015, AND ASCE 7-10 AS APPLICABLE.

127 MPH


LOADS DESIGNATED BY "PSF" ARE UNIFORM LOADS, THOSE DESIGNATED BY "LB" ARE CONCENTRATED LOADINGS AND SHALL BE APPLIED AS REQUIRED BY THE MA STATE BUILDING CODE.

1. DEAD LOADS

4.1. BASIC WIND SPEED, V

1.1. SELF-WEIGHT OF ALL ATTACHED ELEMENTS.

2. <u>LIVE LOADS</u> 2.1. DECK	90 PSF
B. SNOW LOAD	
3.1. GROUND SNOW LOAD, PG	40 PSF
3.2. WEATHER EXPOSED STRUCTURES	
3.2.1. SNOW EXPOSURE FACTOR, CE	1.0
3.2.2. SNOW LOAD IMPORTANCE FACTOR, I	1.0
3.2.3. THERMAL FACTOR, CT	1.2

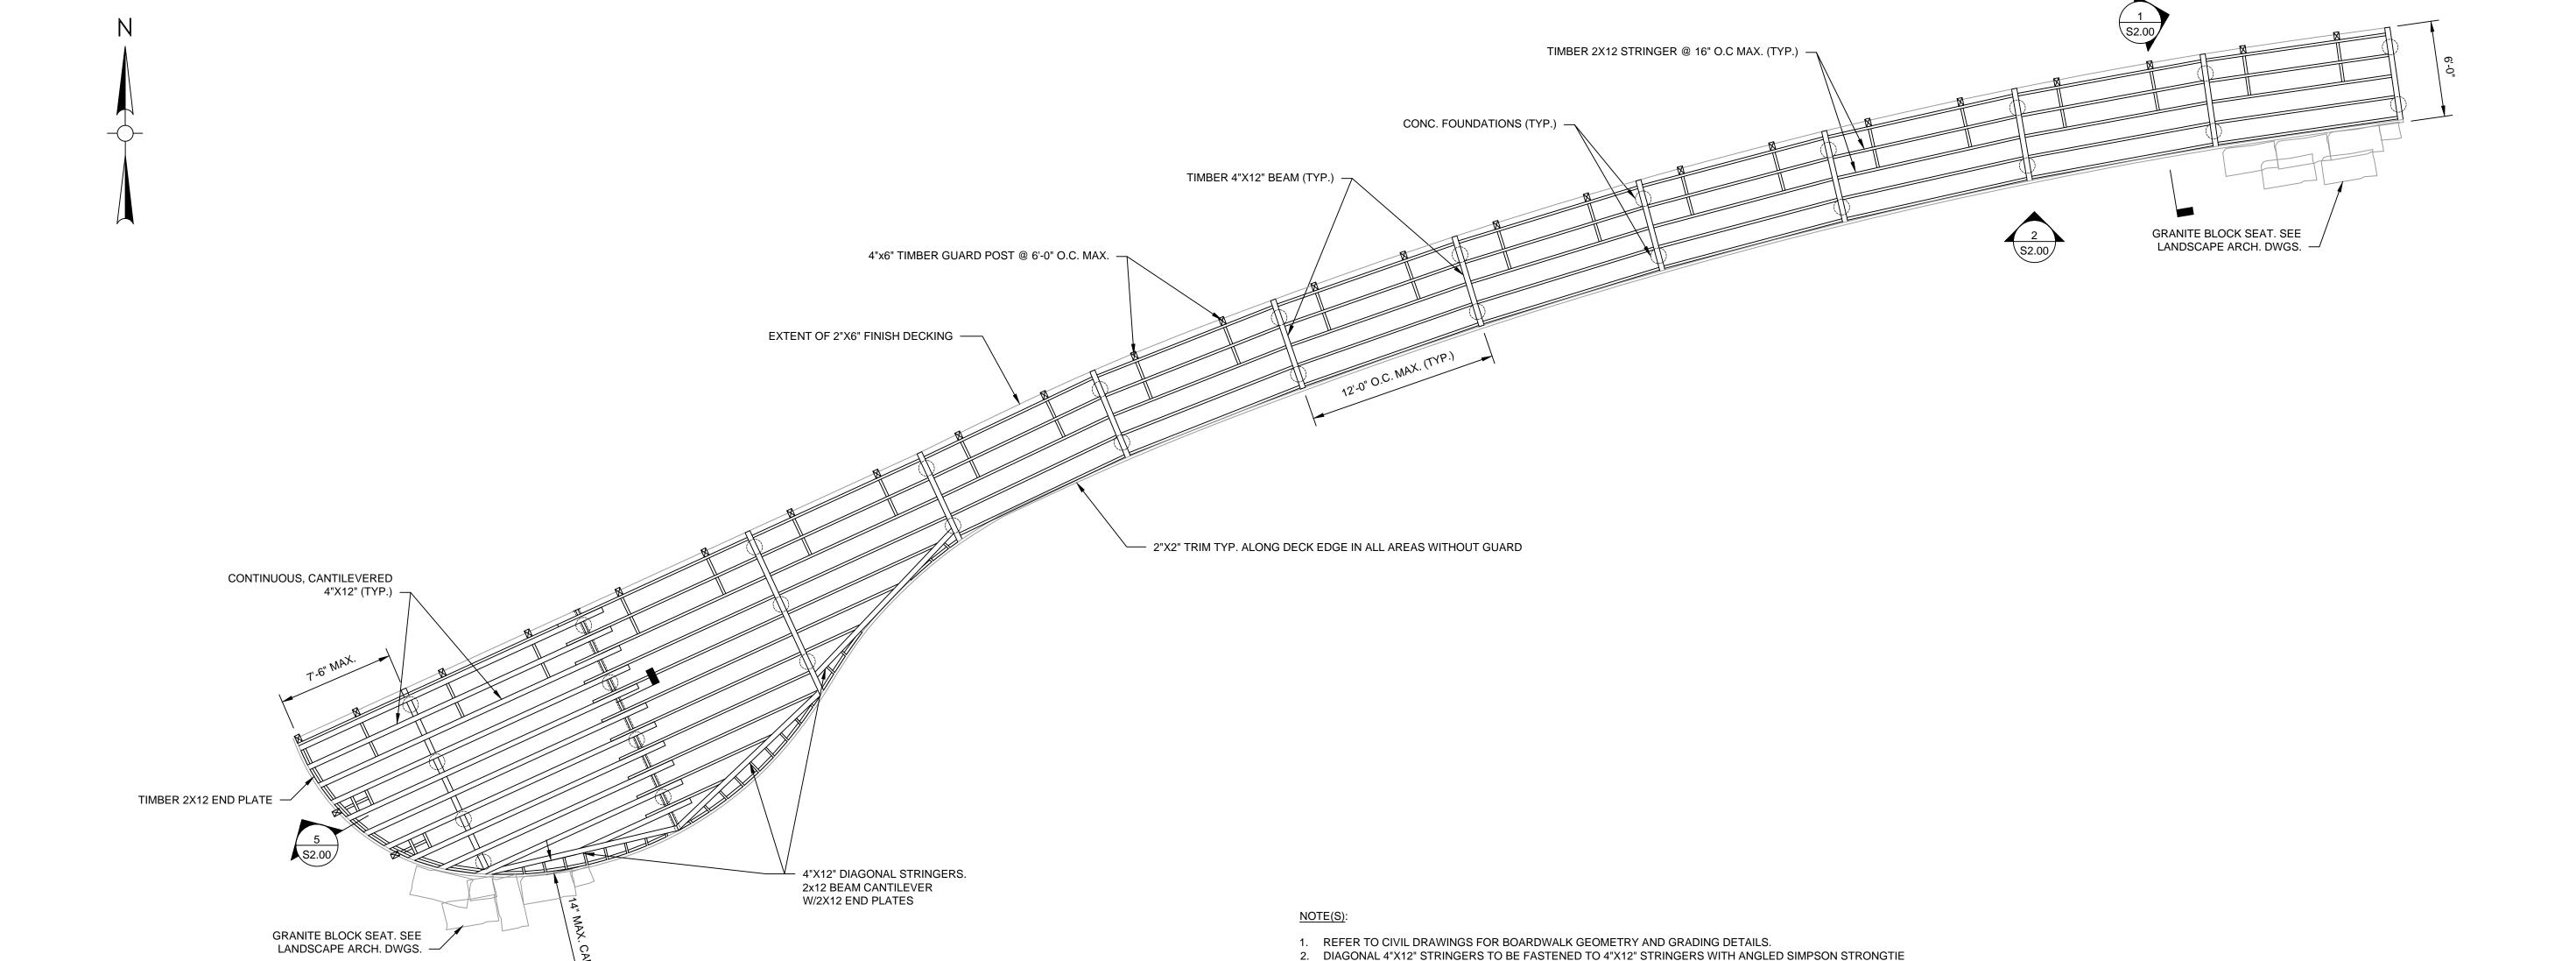



3. FOUNDATIONS TO BE PRE-CAST EZ-CRETE OR APPROVED EQUAL.

SUR/SUL (MIN. VERTICAL CAPACITY OF 2500 LBS). BEARING LENGTH AND WIDTH SHALL BE 4" MIN.

roject:

TOWN OF ARLINGTON, MA




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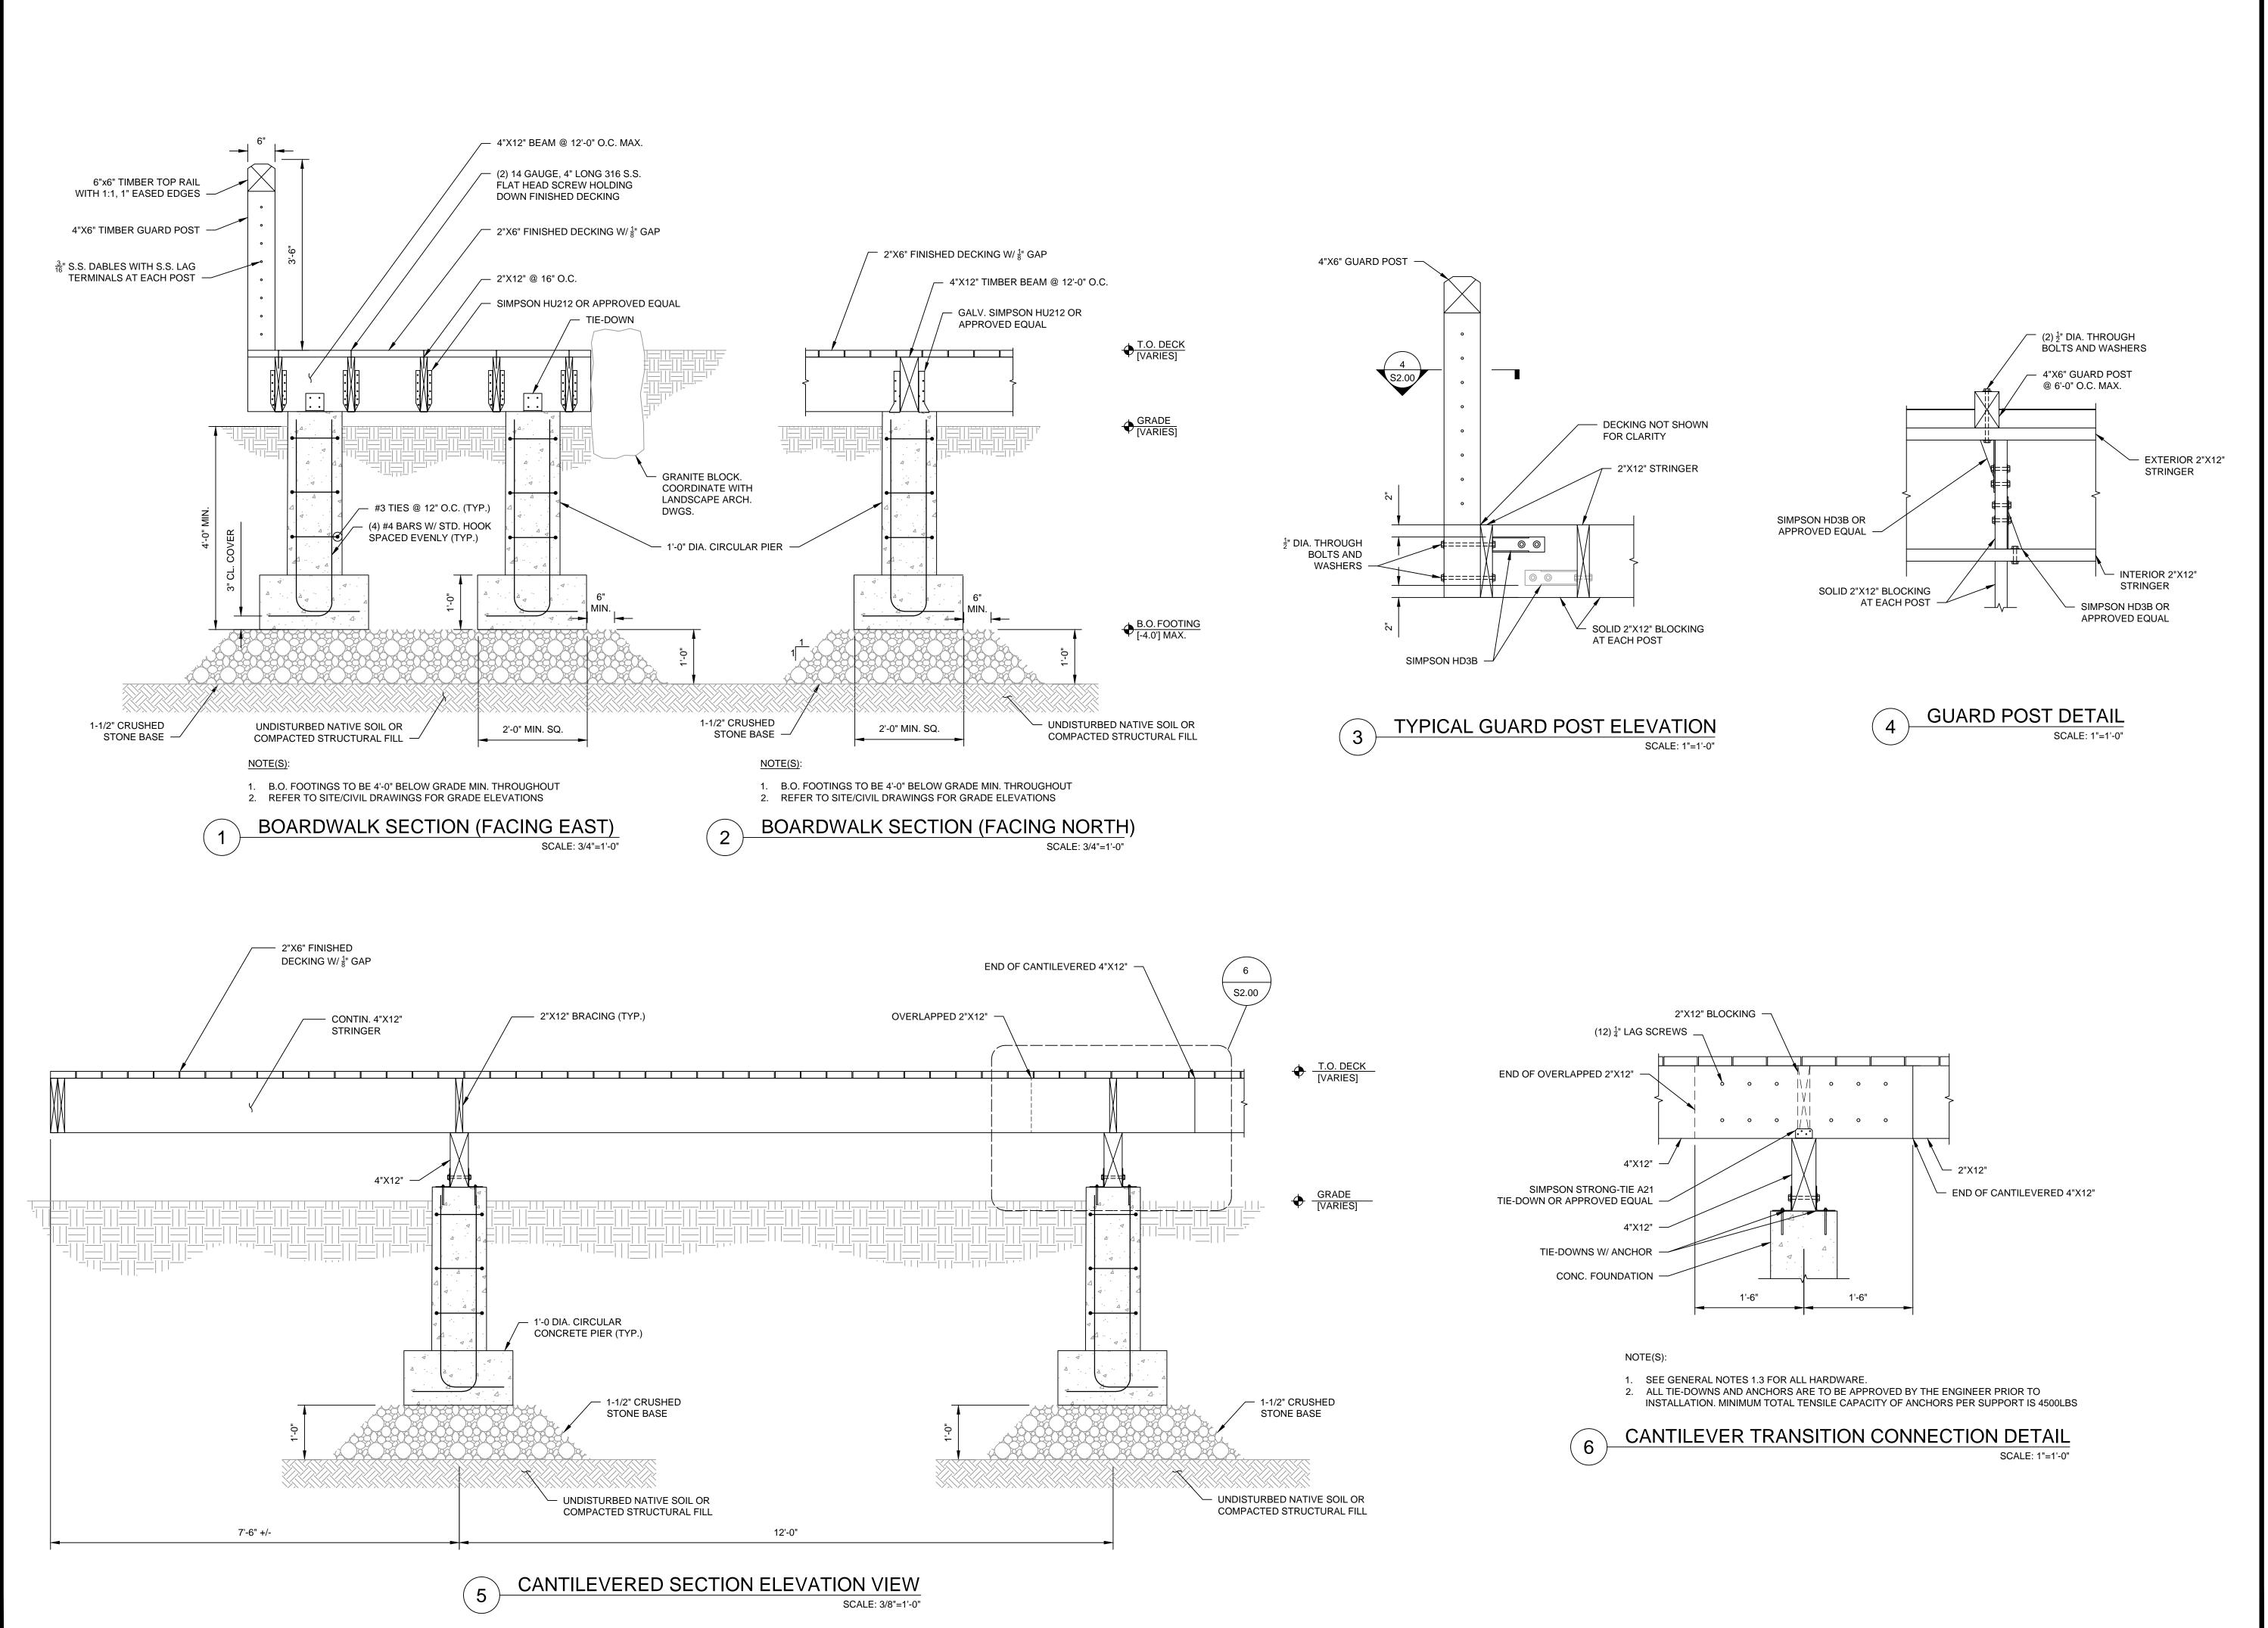
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BOARDWALK GENERAL NOTES, PLANS & ELEVATION

Sheet Number:

S1.0²



TOWN OF ARLINGTON, MA

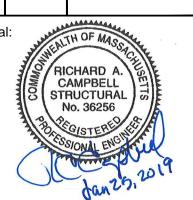WILL BROOK CORRIDOR

WELLINGTON PARK

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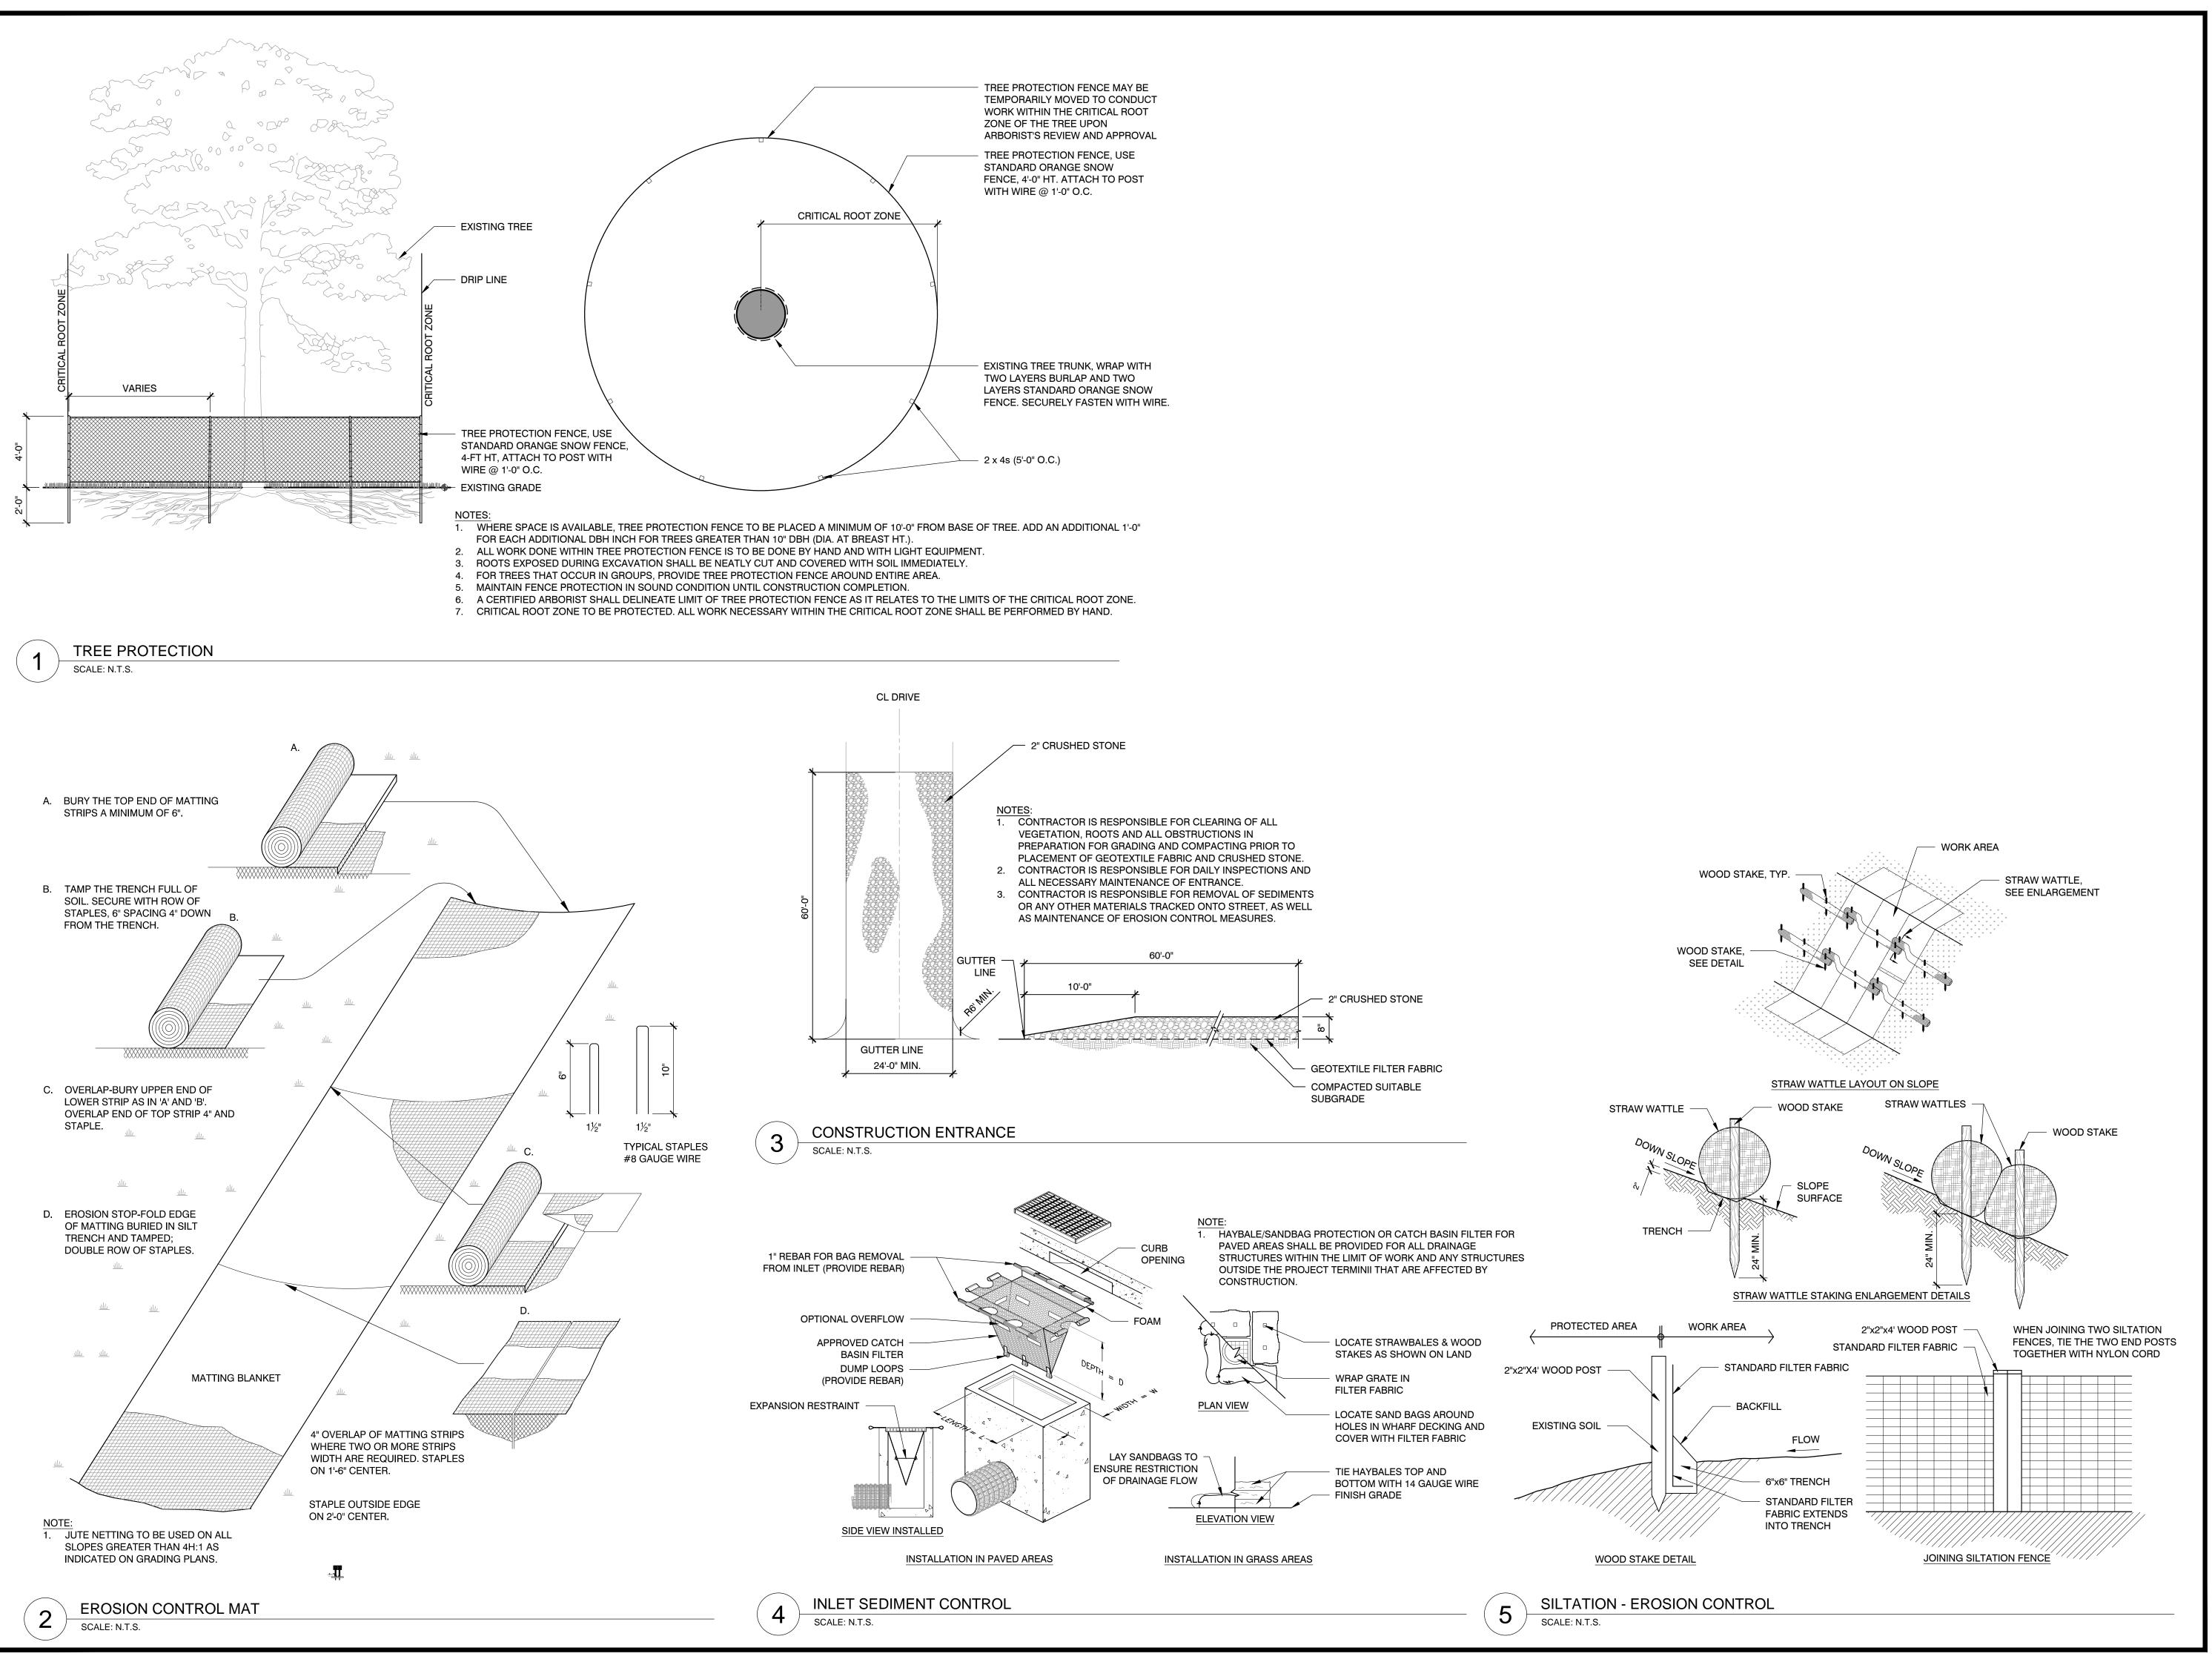
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BOARDWALK SECTIONS & DETAILS

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S2.01



TOWN OF ARLINGTON, MA

WILL BROOK CORRIDOR
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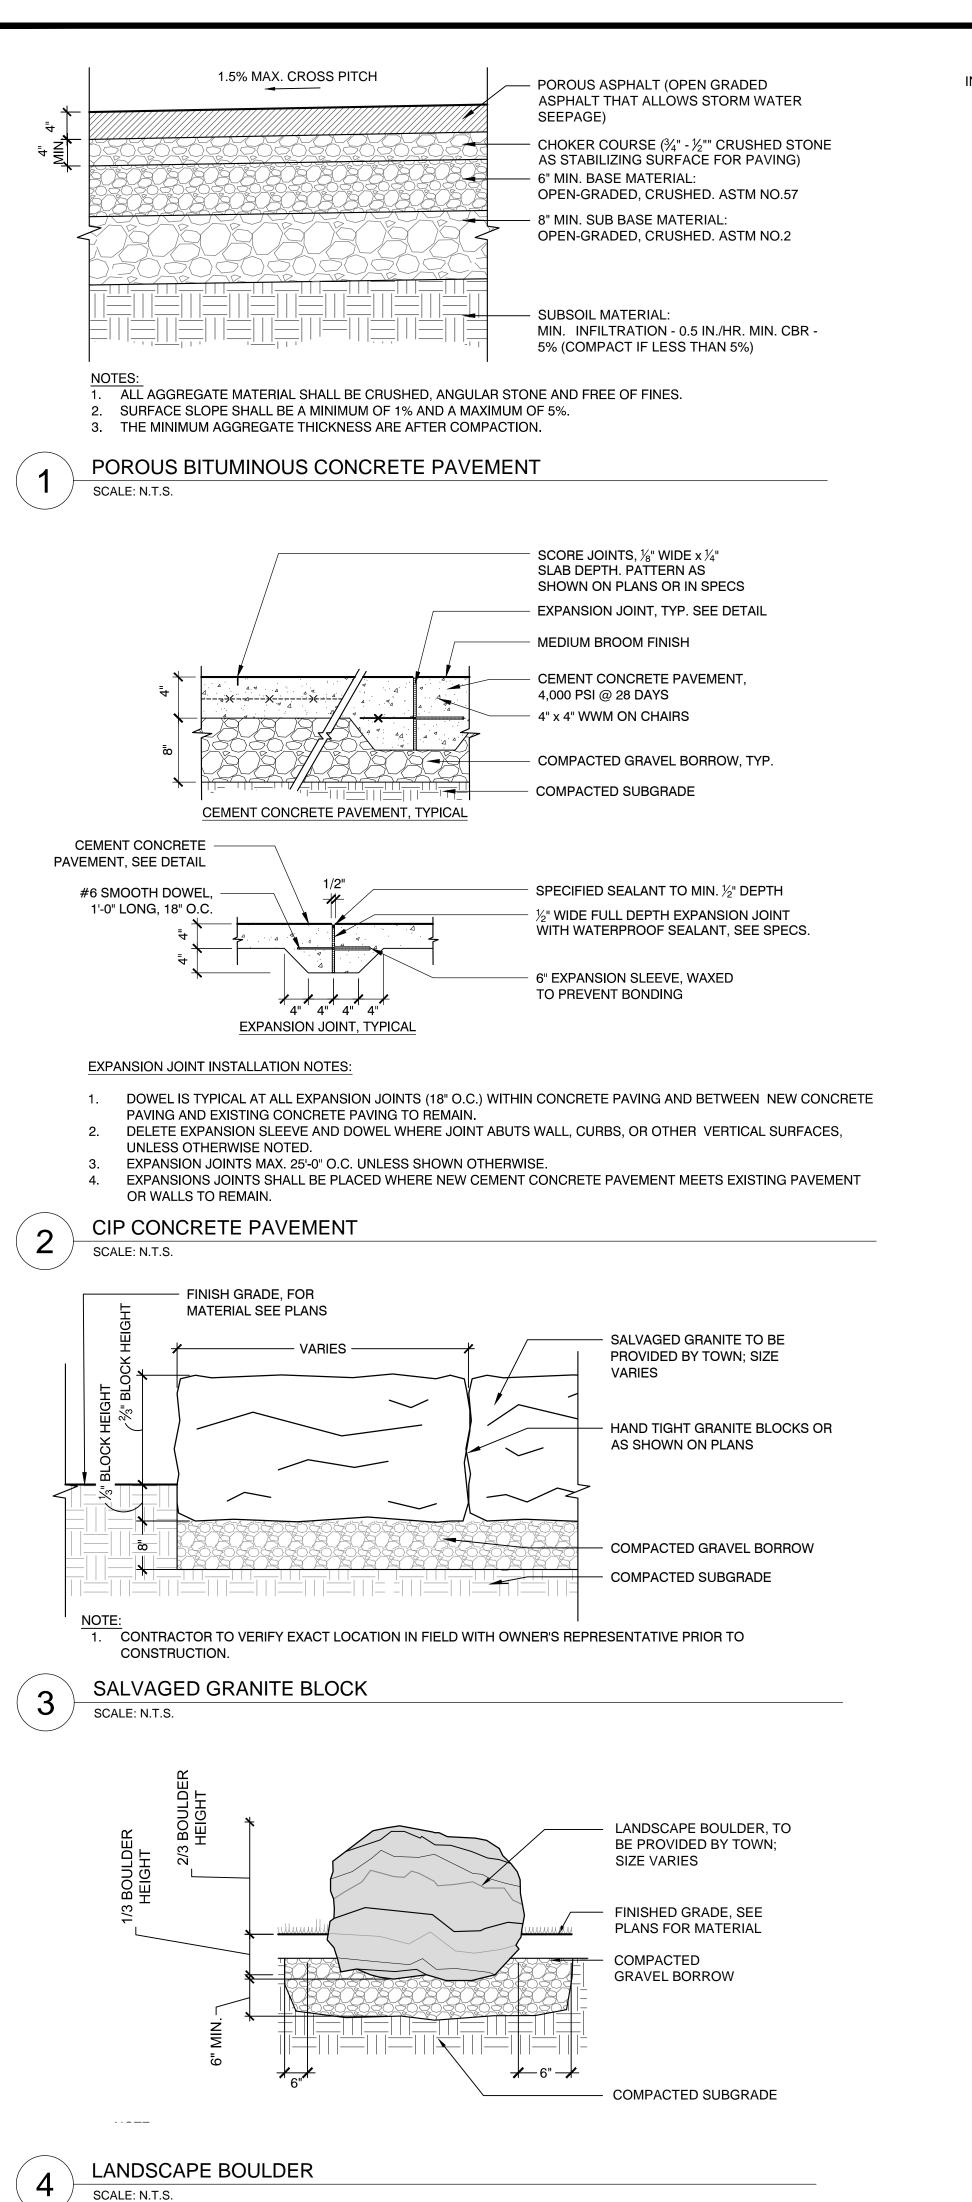
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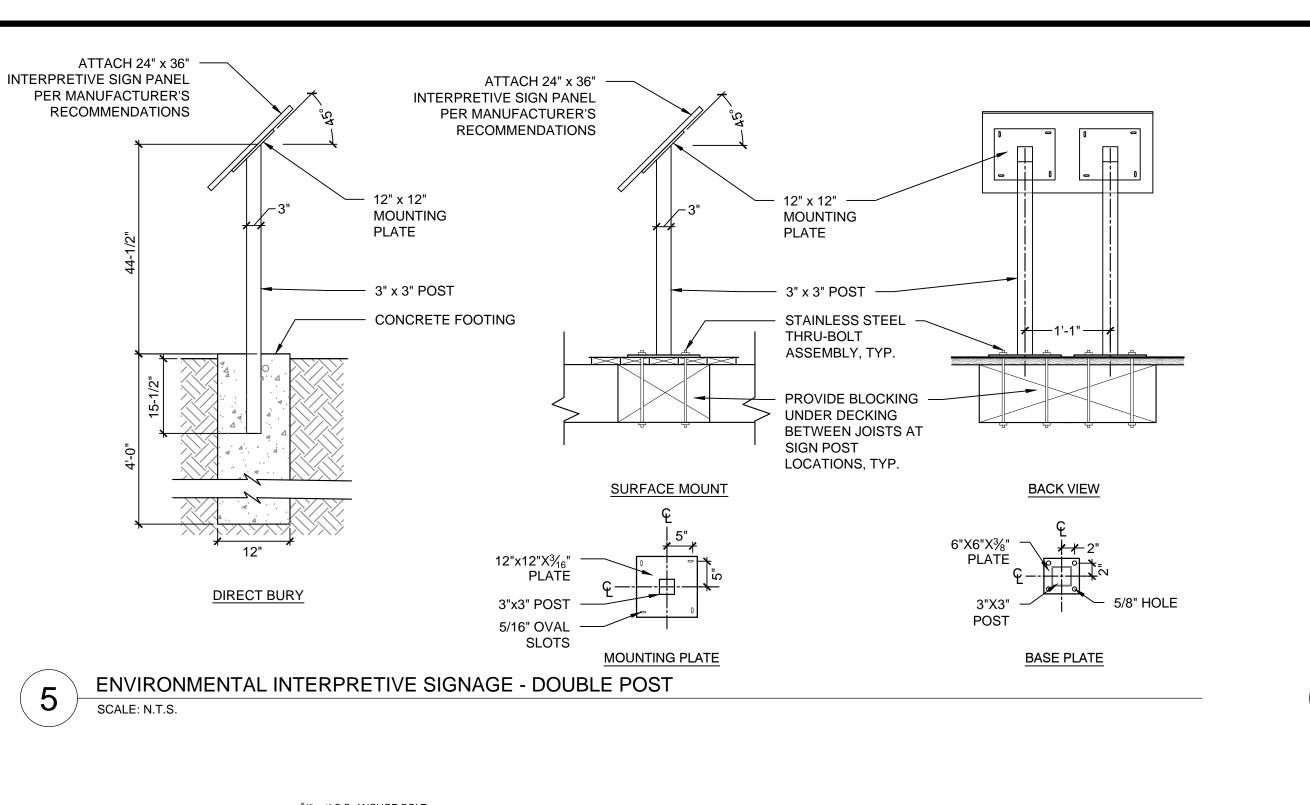
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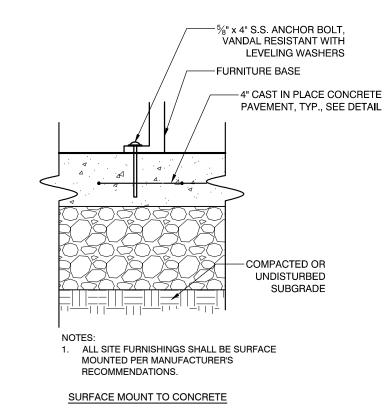
LANDSCAPE DETAILS

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L6.01











SCALE: N.T.S.

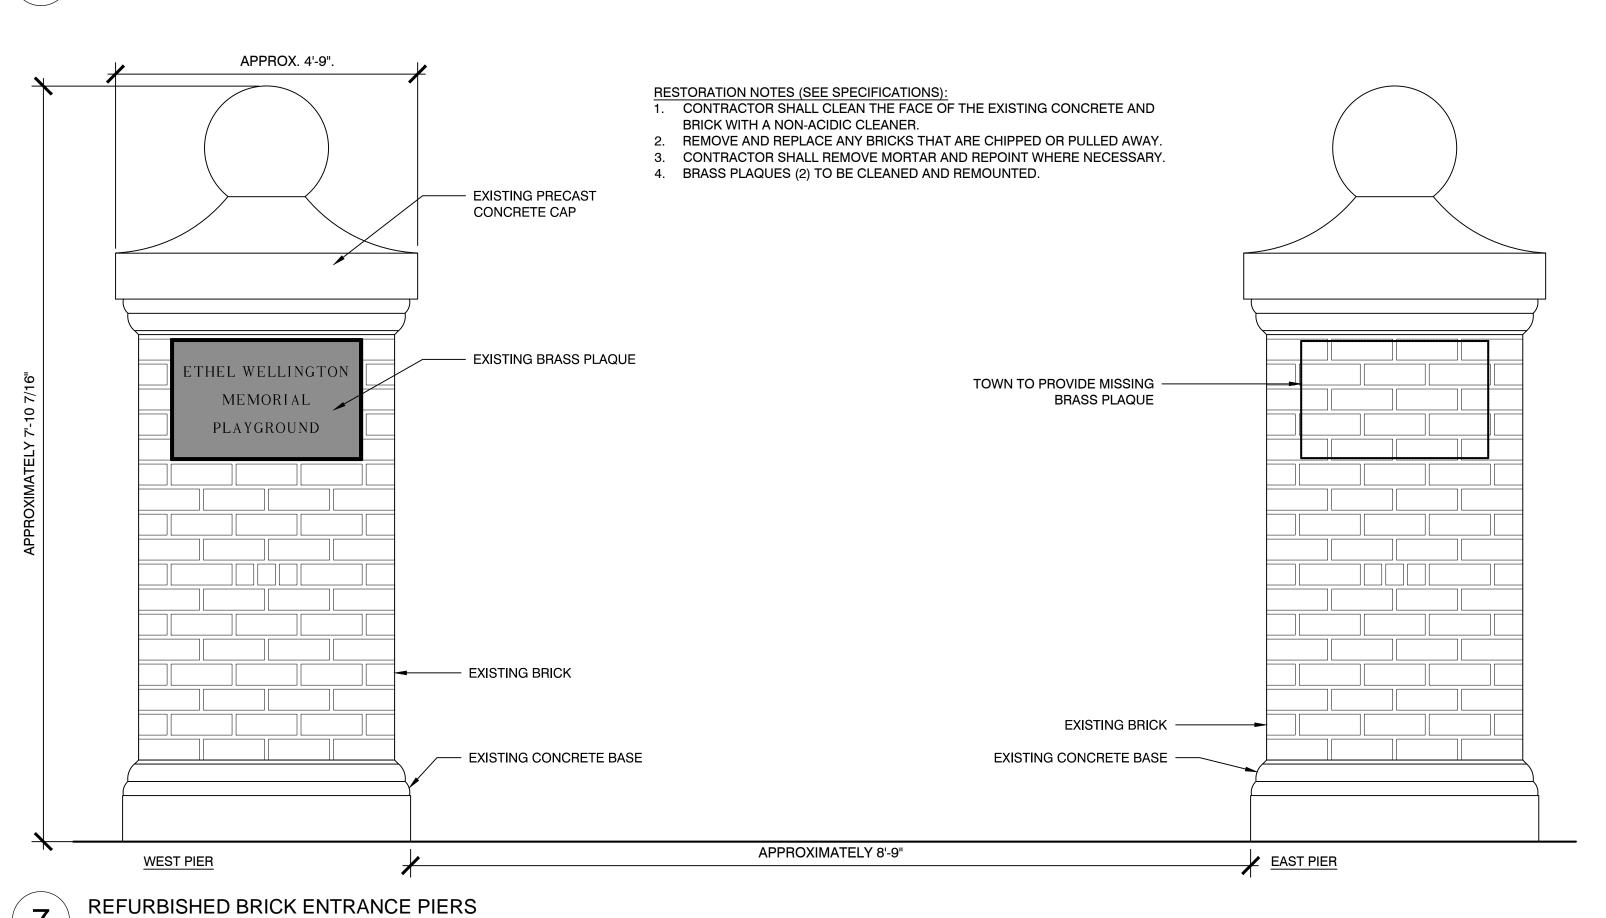

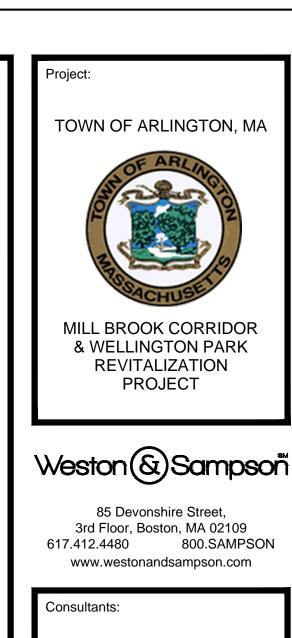

WOOD GUARDRAIL

AND SPECS.

FENCE, SEE STRUCTURAL

DRAWINGS \$1.01, \$2.01

FINISH GRADE

∮ COMPACTED

SUBGRADE

COMPACTED GRAVEL

BORROW

6" TYP.

BE 6' - 8' O.C.

SCALE: N.T.S.

1. FENCE POST SPACING IN LAWN SHALL

WOOD FENCE AT LAWN

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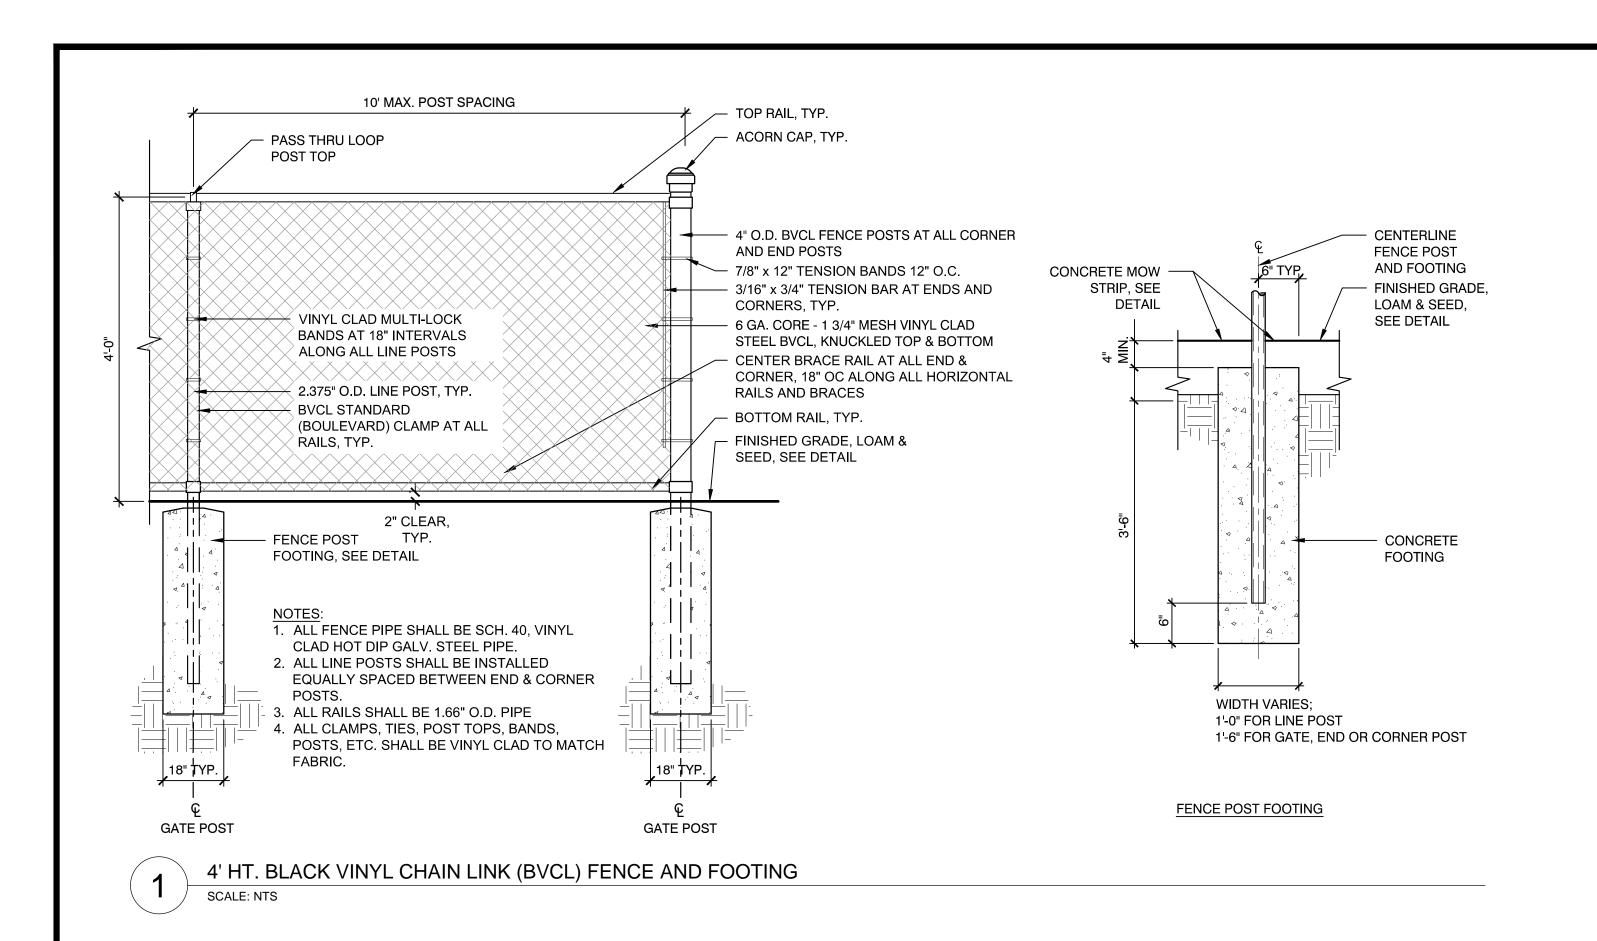
Reviewed By: JL, CR

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LANDSCAPE DETAILS

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L6.02



HYDROMULCH SEED, SEE PLANS

LOAM TOP SOIL AMEND SOIL MIX SEE

- 3" DEPTH HARDWOOD BARK MULCH (HOLD AWAY FROM

PREPARED PLANTING SOIL MIX,

CROWN/ROOT FLARE)

SEE SPECIFICATIONS

SHRUB ROOT BALL, TYP.

COMPACTED SUBGRADE

AND SPECIFICATIONS

SPECIFICATIONS

1. ALL MULCH MUST BE DARK IN COLOR. PROVIDE SAMPLE PRIOR TO INSTALLATION TO BE APPROVED BY OWNER'S REPRESENTATIVE.

✓ SEE PLANS

✓

LOAM & SEED

SCALE: N.T.S.

FLEXIBLE GROWTH ·

SOIL SAUCER, TYP.


TEMPORARY MOUNDED -

MEDIUM

SHRUB PLANTING

SCALE: N.T.S.


COMPACTED SUBGRADE

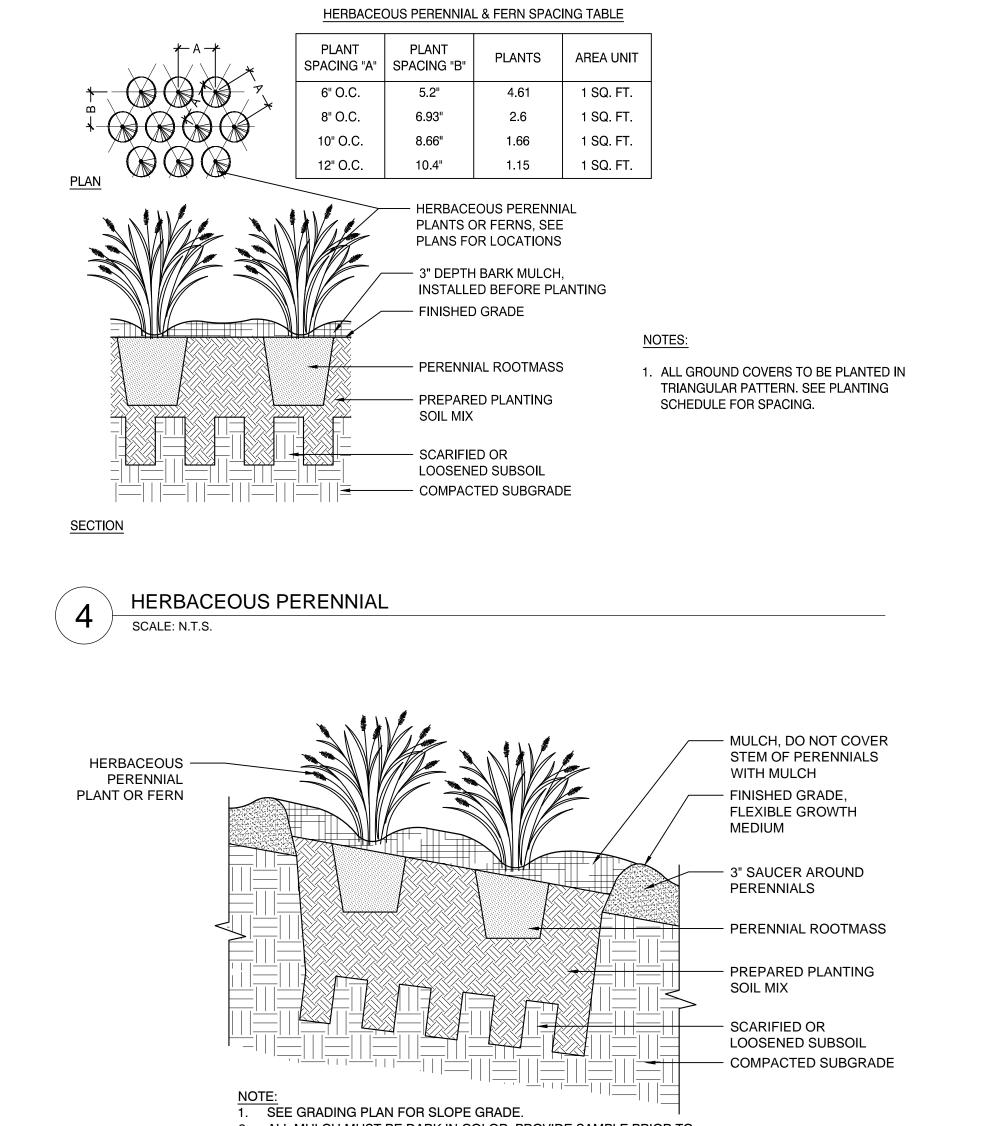

2. ALL MULCH MUST BE DARK IN COLOR. PROVIDE SAMPLE PRIOR TO INSTALLATION TO BE APPROVED BY OWNER'S REPRESENTATIVE.

HERBACEOUS PERENNIAL PLANTING ON SLOPE

SCALE: N.T.S.

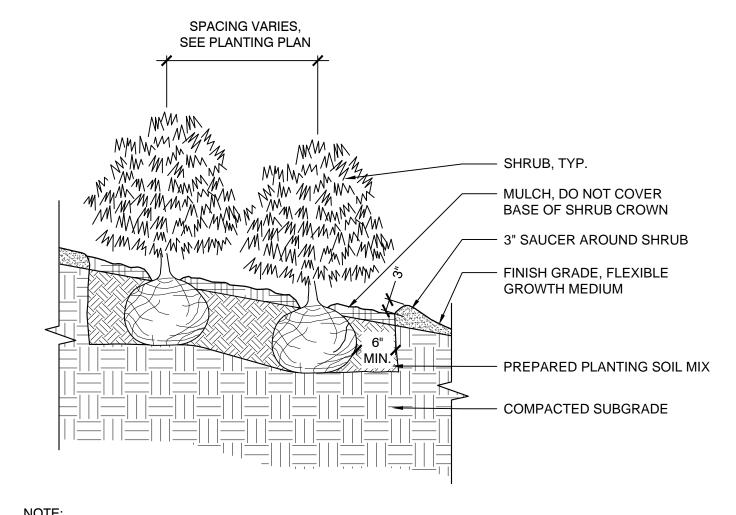

INSTALLATION TO BE APPROVED BY OWNER'S REPRESENTATIVE.

SHRUB PLANTING ON SLOPE

SCALE: N.T.S.

1. SEE GRADING PLAN FOR SLOPE GRADE.

2. ALL MULCH MUST BE DARK IN COLOR. PROVIDE SAMPLE PRIOR TO

TOWN OF ARLINGTON, MA

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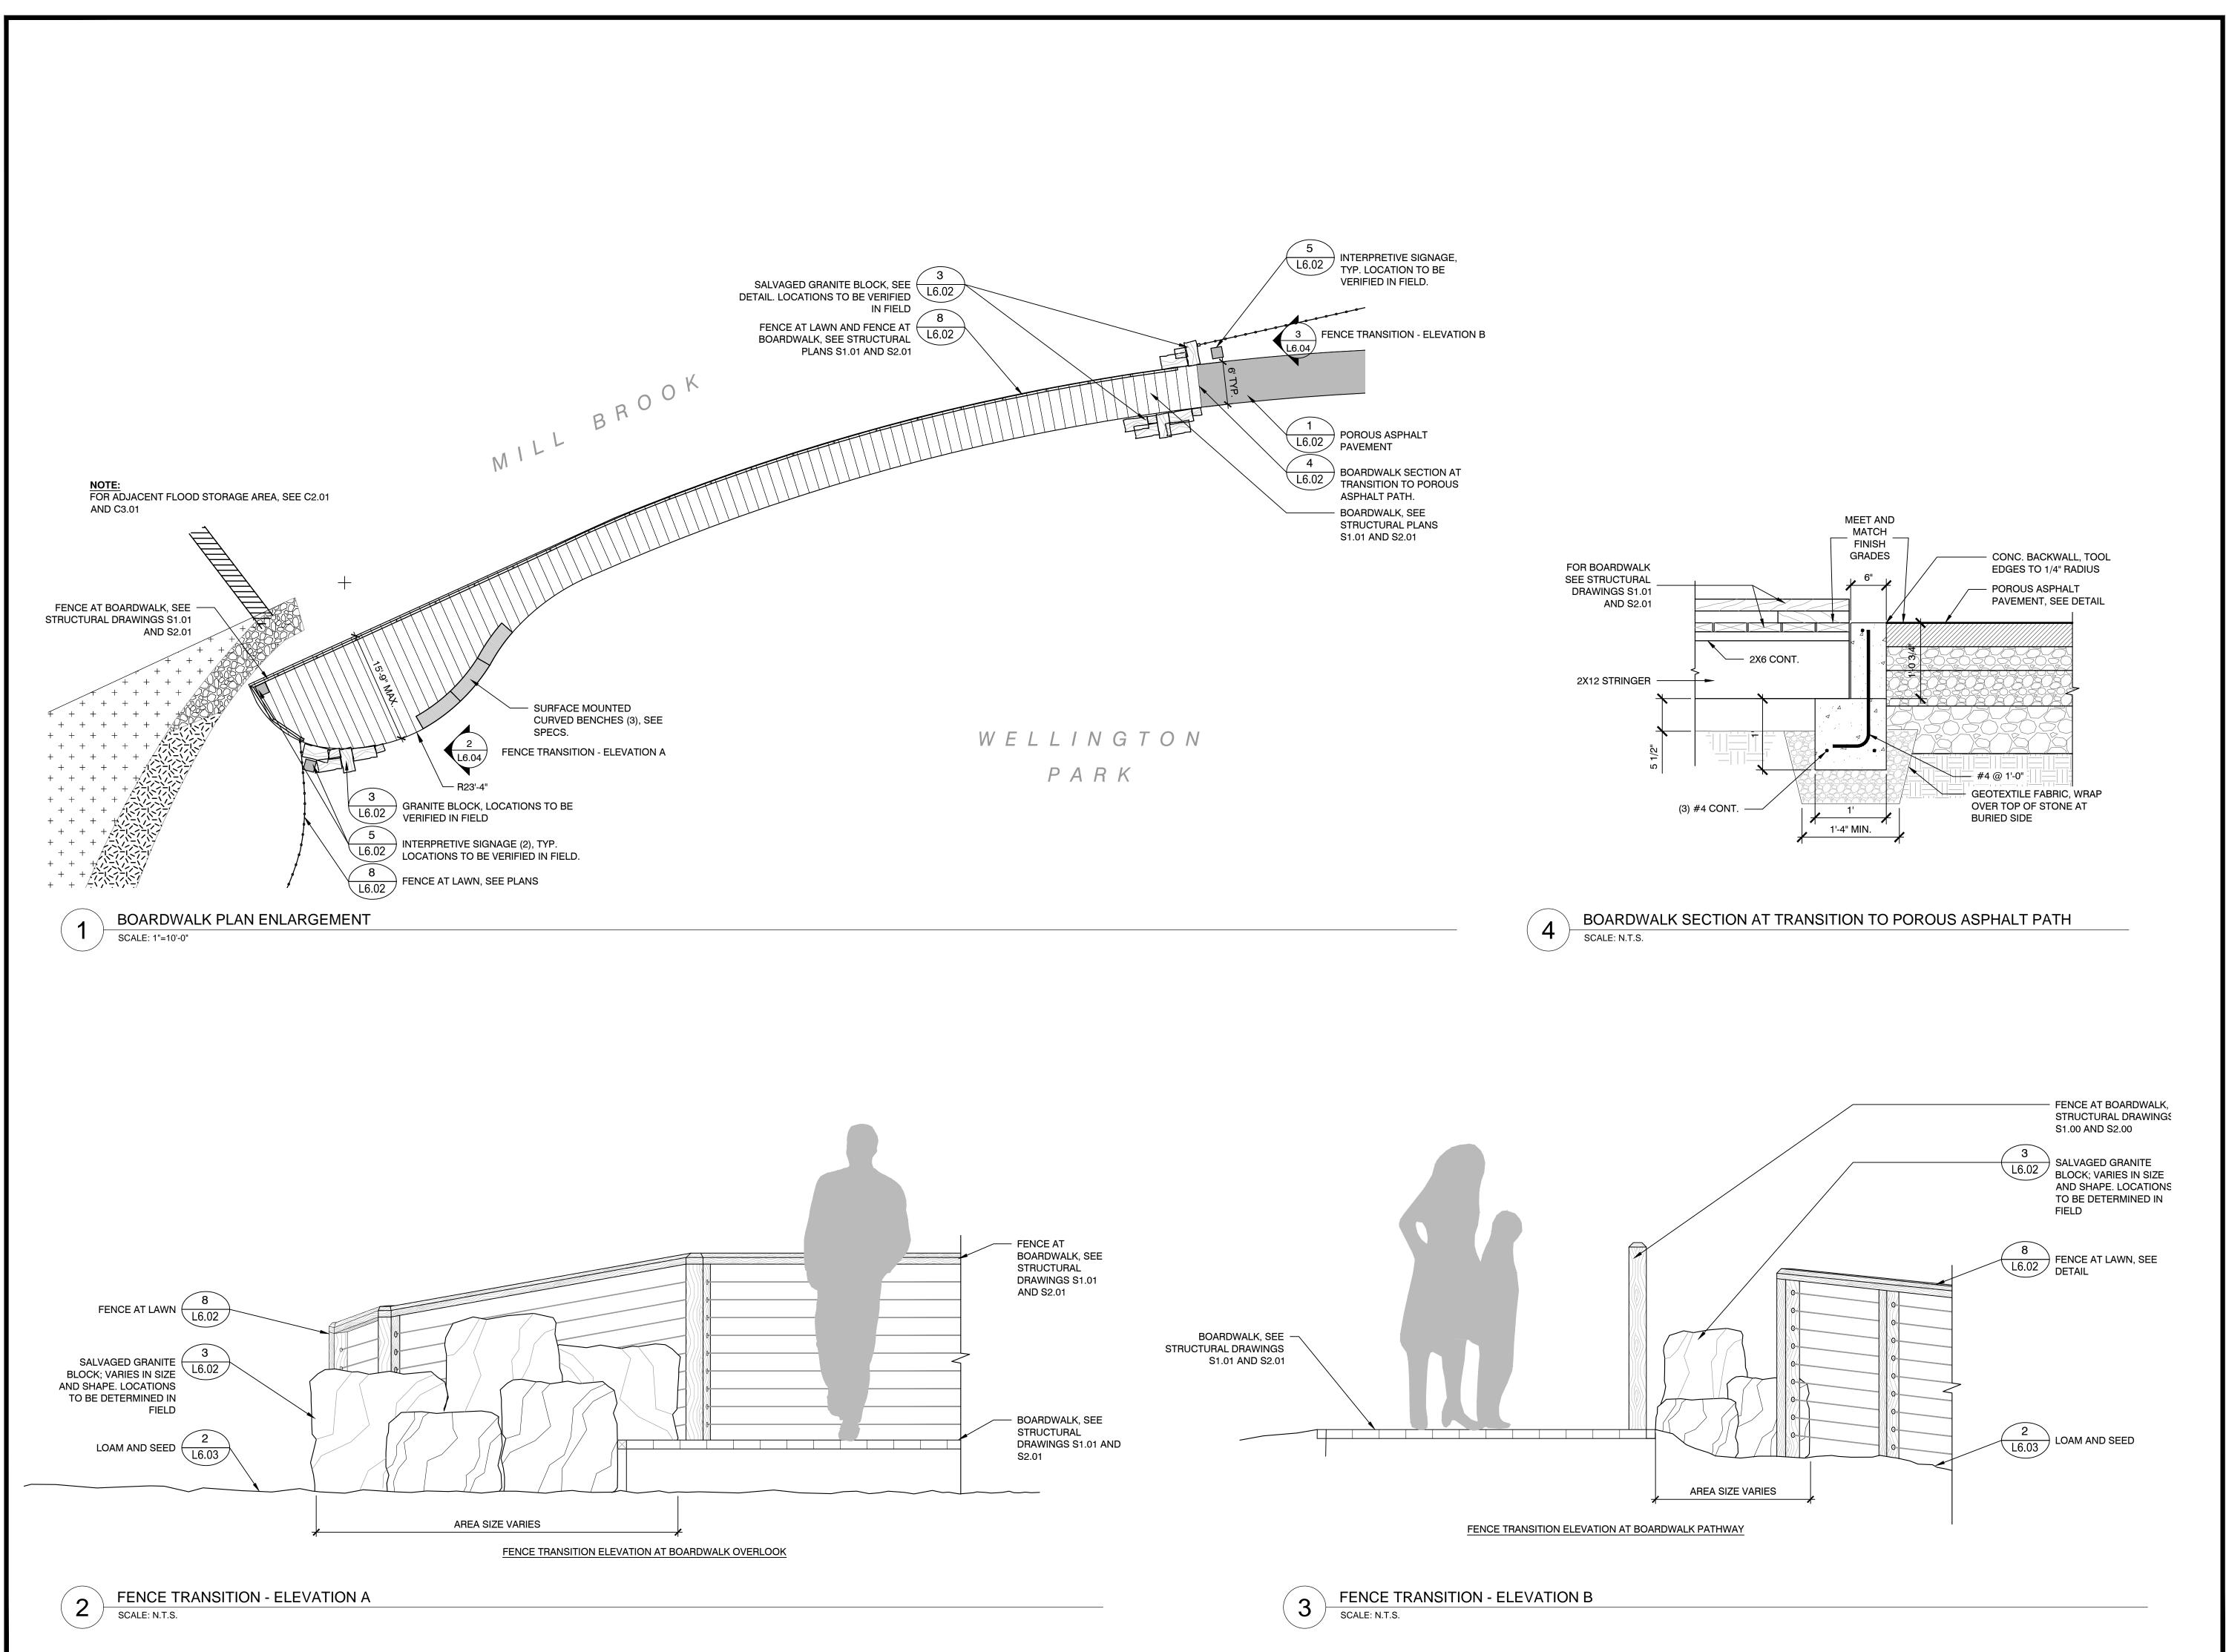
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LANDSCAPI
DETAILS

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